12 Clermont Ave

Proposed Dual Occupancy @ 12 Clermont Ave, RYDE NSW 2112

Section 4.55 Issue - 20th June 2022

STUDIO_BD ARCHITECTURE & INTERIORS

CLERMONT

R E S I D E N C E S

BY YOUNES PROPERTY

CONTENTS


<u>Architecturals</u>

783DA A 01	Cover Sheet
783DA A 04	Basement Floor Pla
783DA_A_05	Ground Floor Plan
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783DA_A_07	Roof Plan
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783DA_A_15	Sections (Part 3)
783DA_A_16	Shadow Diagrams
783DA_A_18	Area Schedule
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Additional Information


Statement of Environmental Effects (Robinson Urban Planning)
Stormwater Drainage Plans (NY Civil Engineering)
Geotechnical Assessment (Douglas Partners)
Urban Design Addendum Report (Audax Urban)





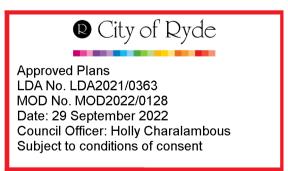



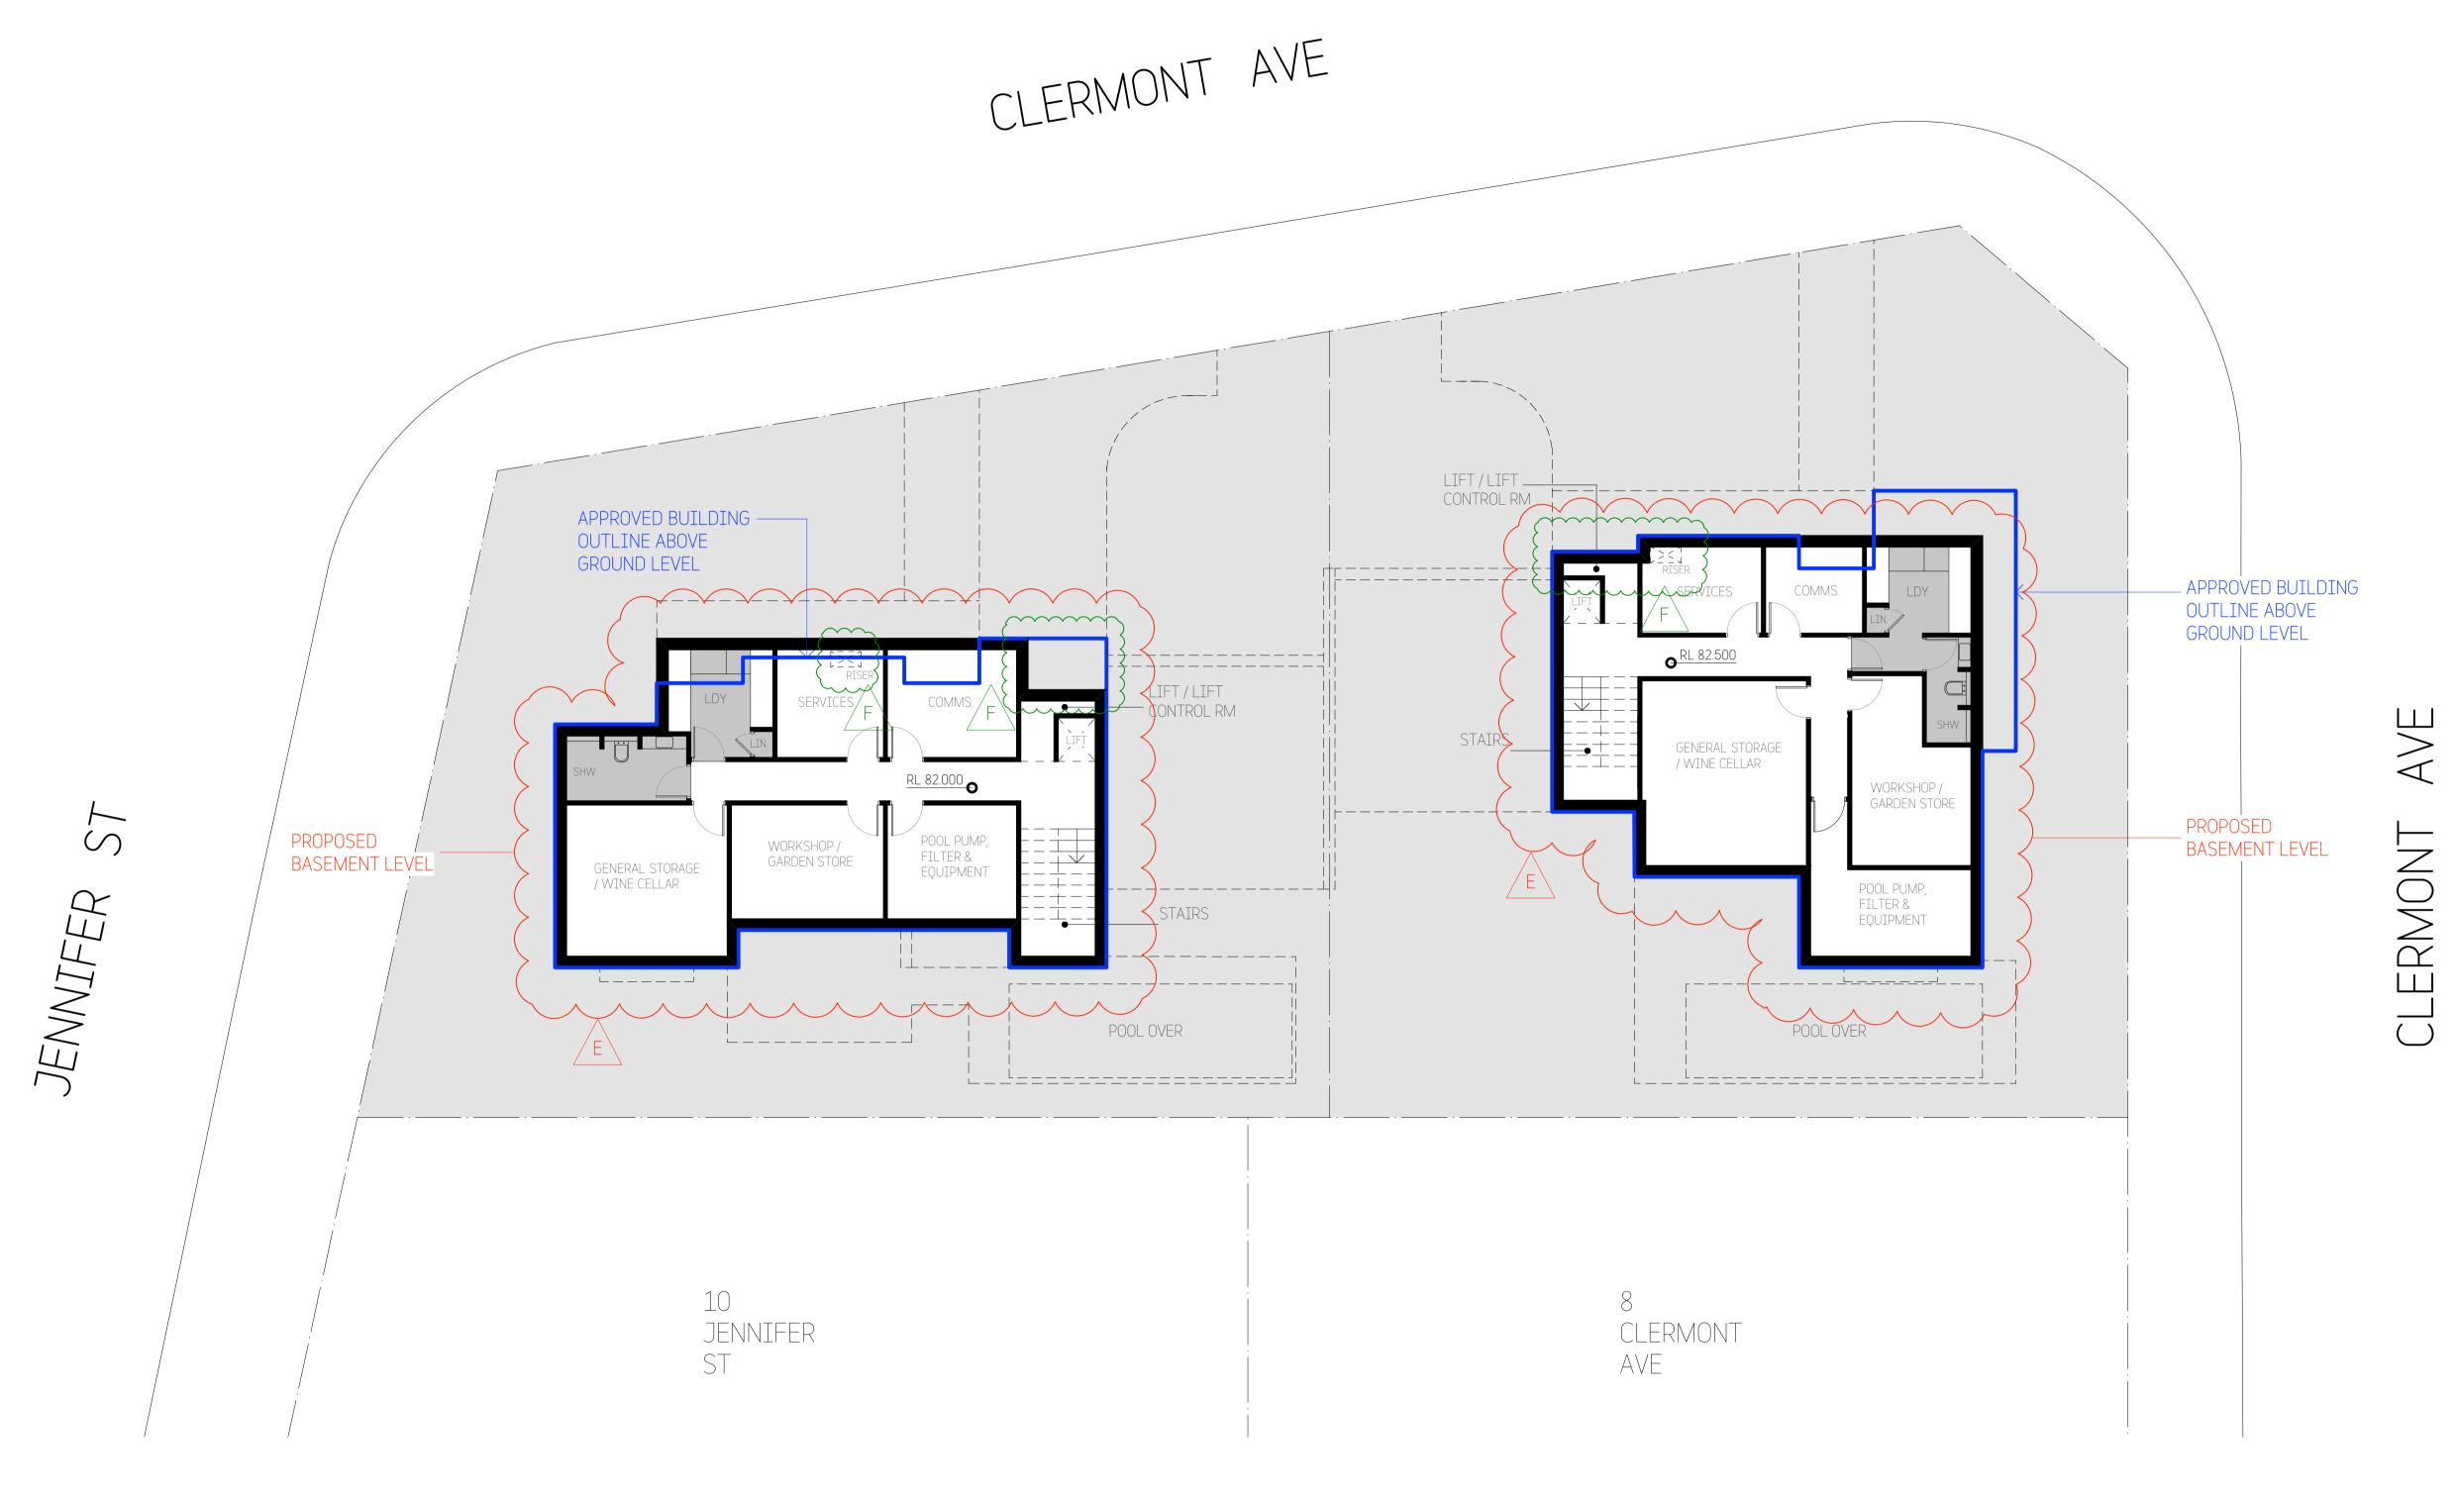

NOTES:
- SERVICES ROOMS WILL ACCOMMODATE ALL
HEATING, VENTILATION & A/C.
- ALL BASEMENT AREAS TO BE NON-HABITABLE.

Approved Plans
LDA No. LDA2021/0363
MOD No. MOD2022/0128
Date: 29 September 2022
Council Officer: Holly Charalambous
Subject to conditions of consent



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No	Description	Ву	Date
С	Preliminary S4.55 Issue - 2	BD	31/05/22
D	Preliminary S4.55 Issue - 3	BD	17/06/22
Е	Section 4.55 Issue	BD	20/06/22
F	Revised Section 4.55 Issue	BD	29/08/22

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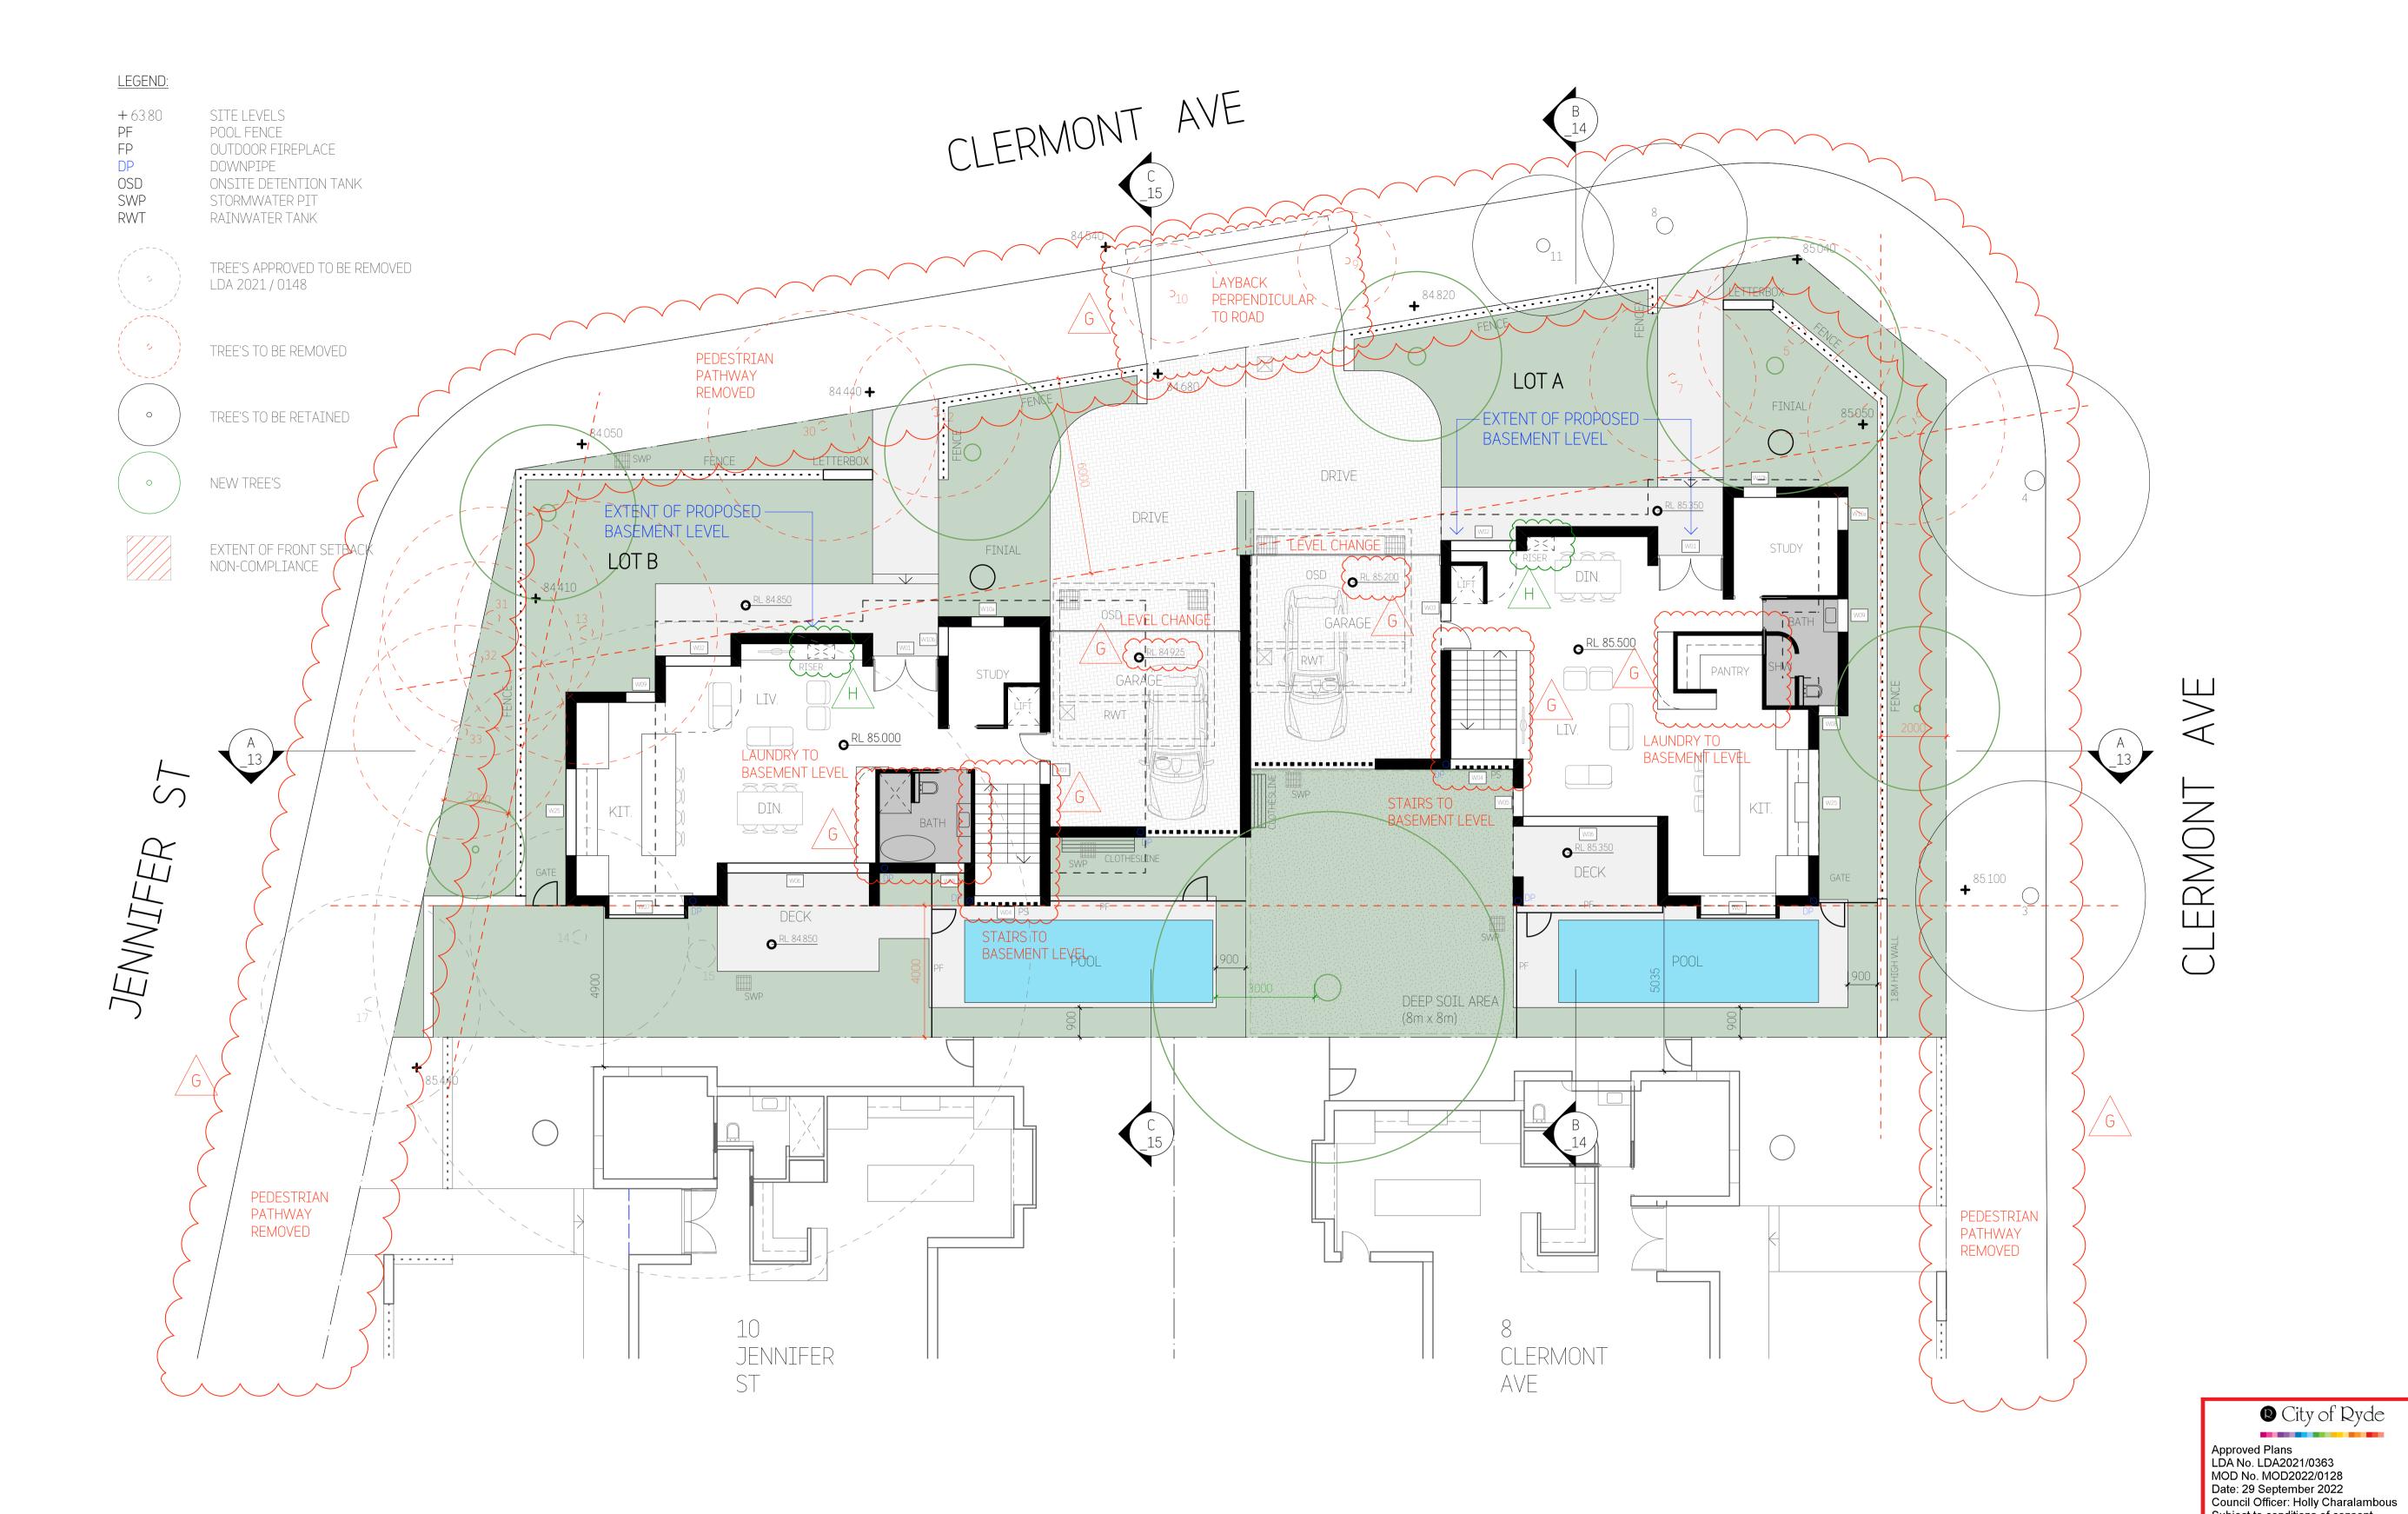
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THERIURS No ±:(TUDIO_BD ARCHITECTURE & INTERIORS ominated Architect Boris Dragas NSW ARB #7658 0414 866 065 e: boris@studiobd.com.au : studiobd.com.au on: 74 219 560 787
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Project:	Drawn: BD Date: 20/07/21		/07/21
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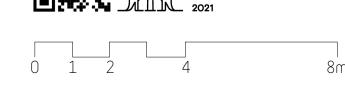


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Е	Development Application Issue	BD	28/09/21
F	Revised Development Application Issue	BD	28/01/22
G	Section 4.55 Issue	BD	20/06/22
Н	Revised Section 4.55 Issue	BD	30/08/22

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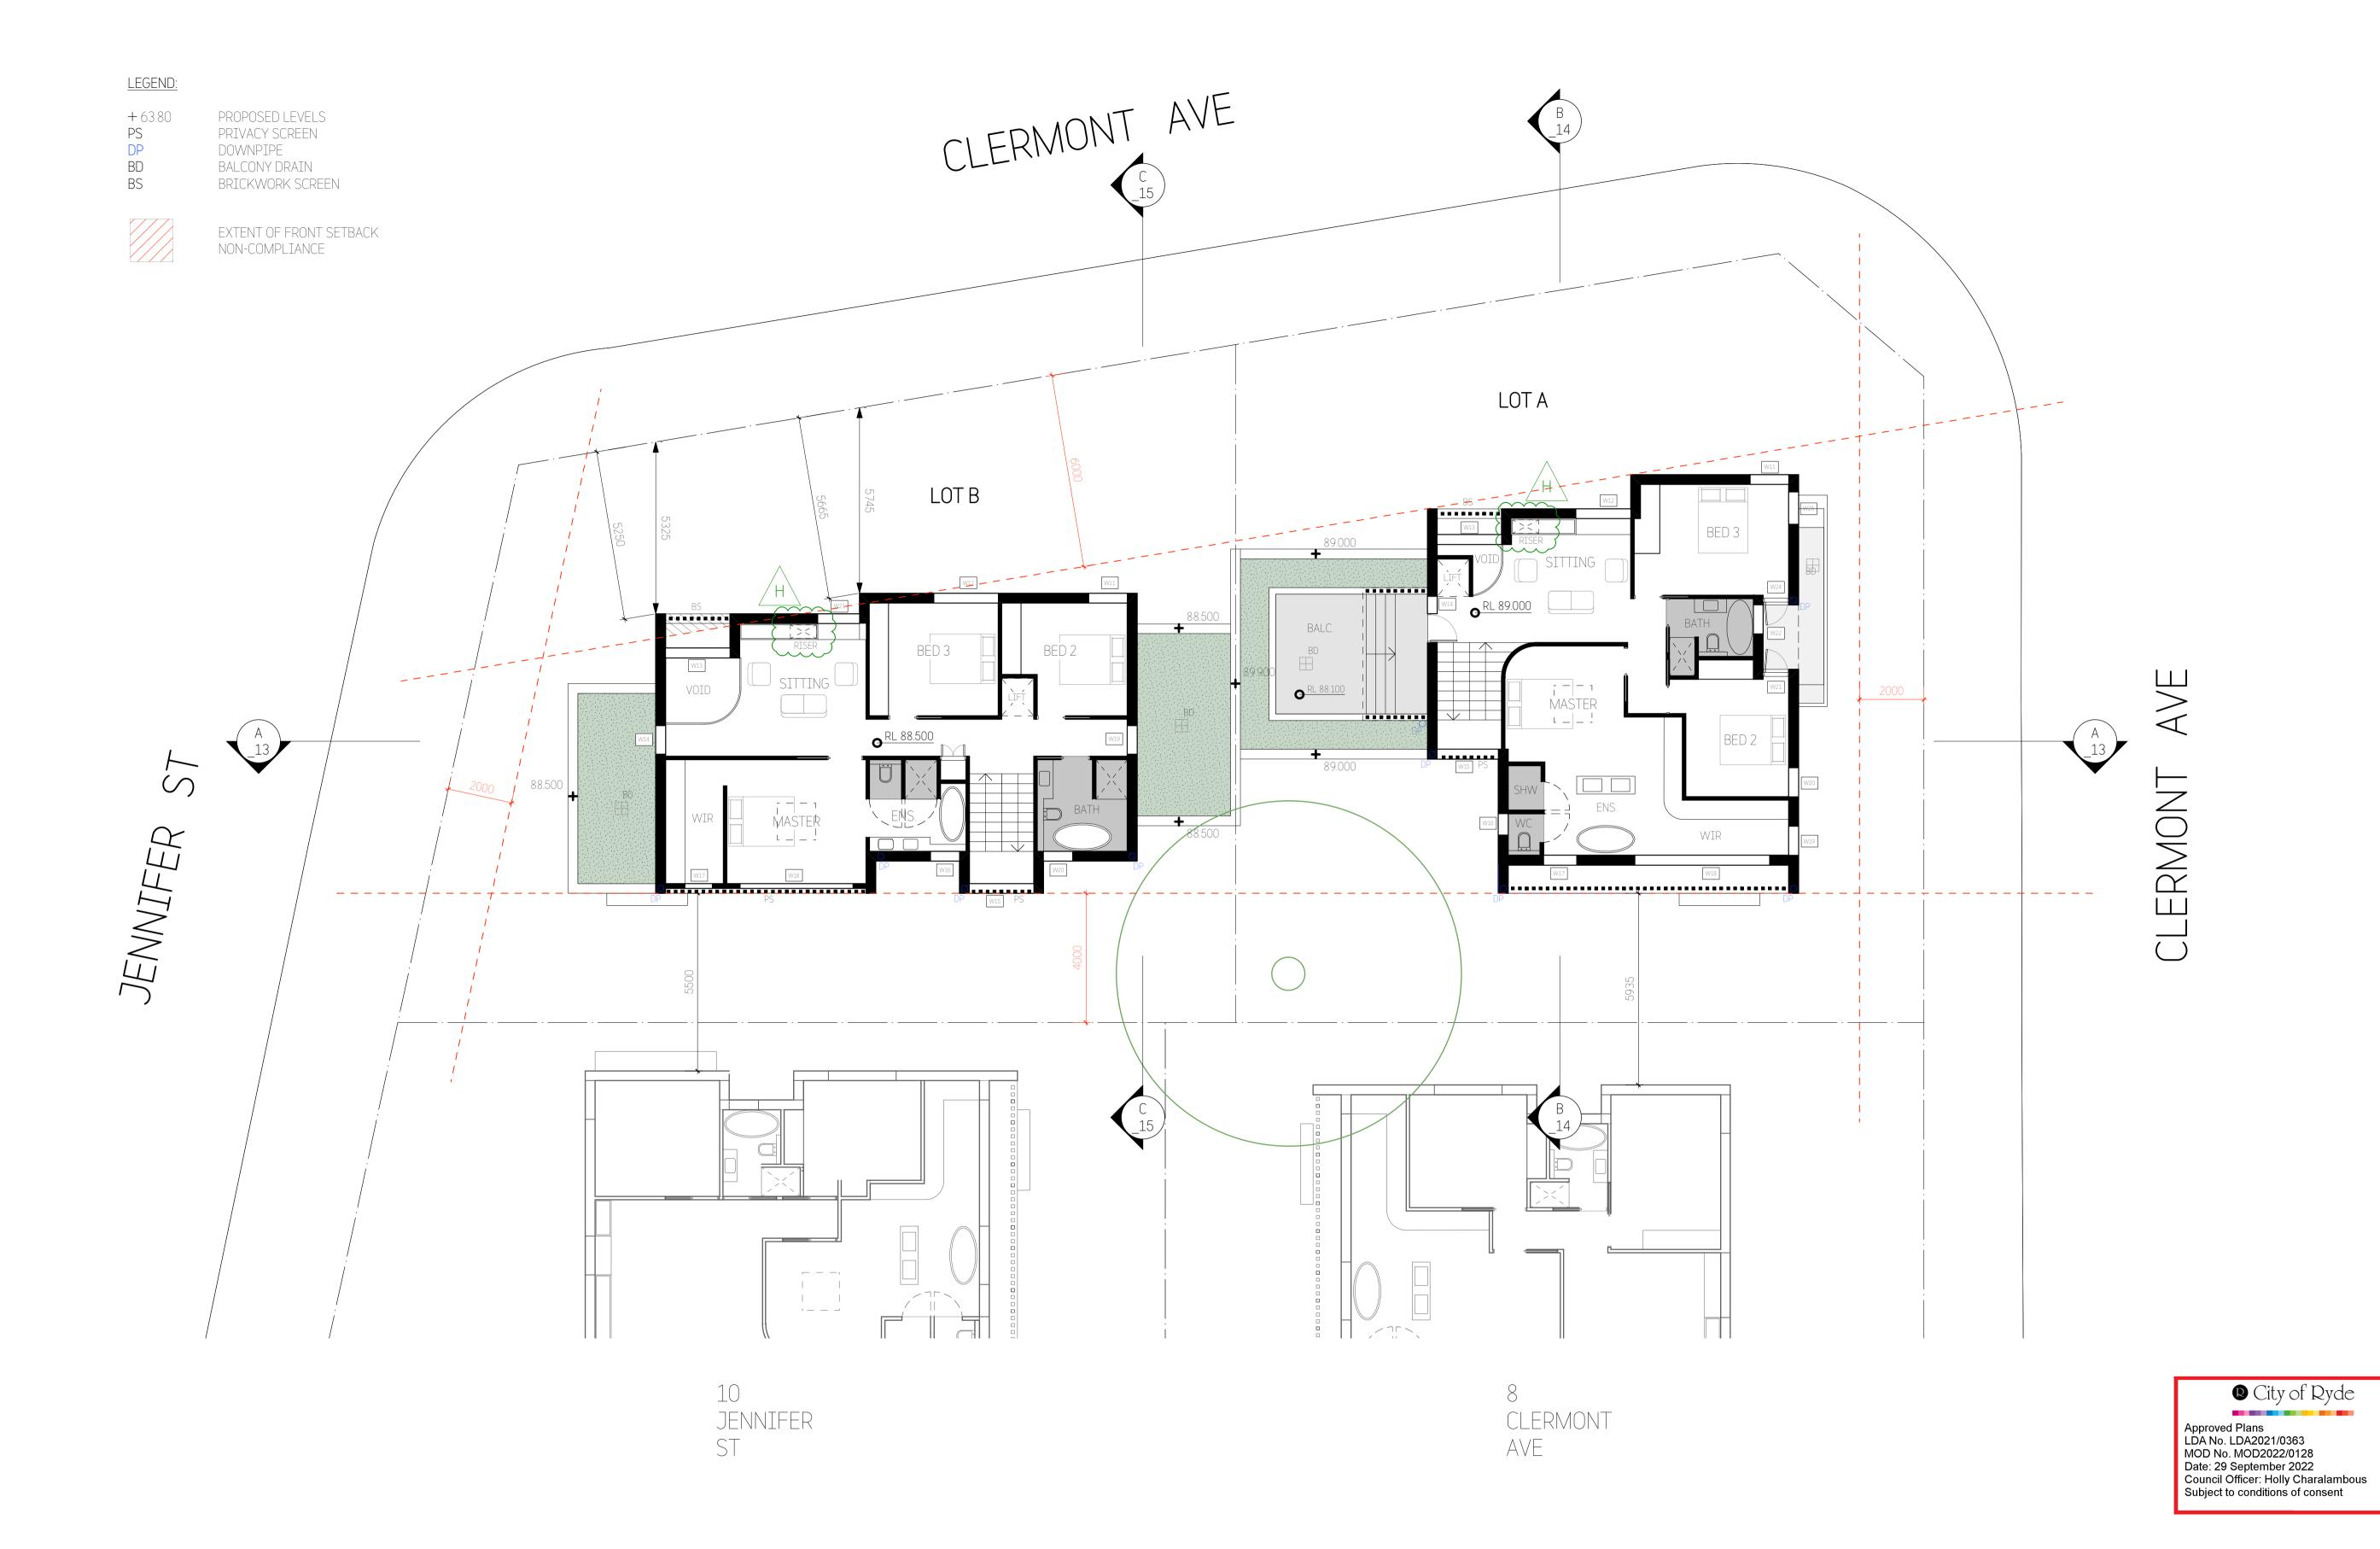


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GROUND FLOOR PLAN	783DA_A_	05	Н

Subject to conditions of consent






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F	Revised Development Application Issue	BD	28/01/22
G	Section 4.55 Issue	BD	20/06/22
Н	Revised Section 4.55 Issue	BD	30/08/22

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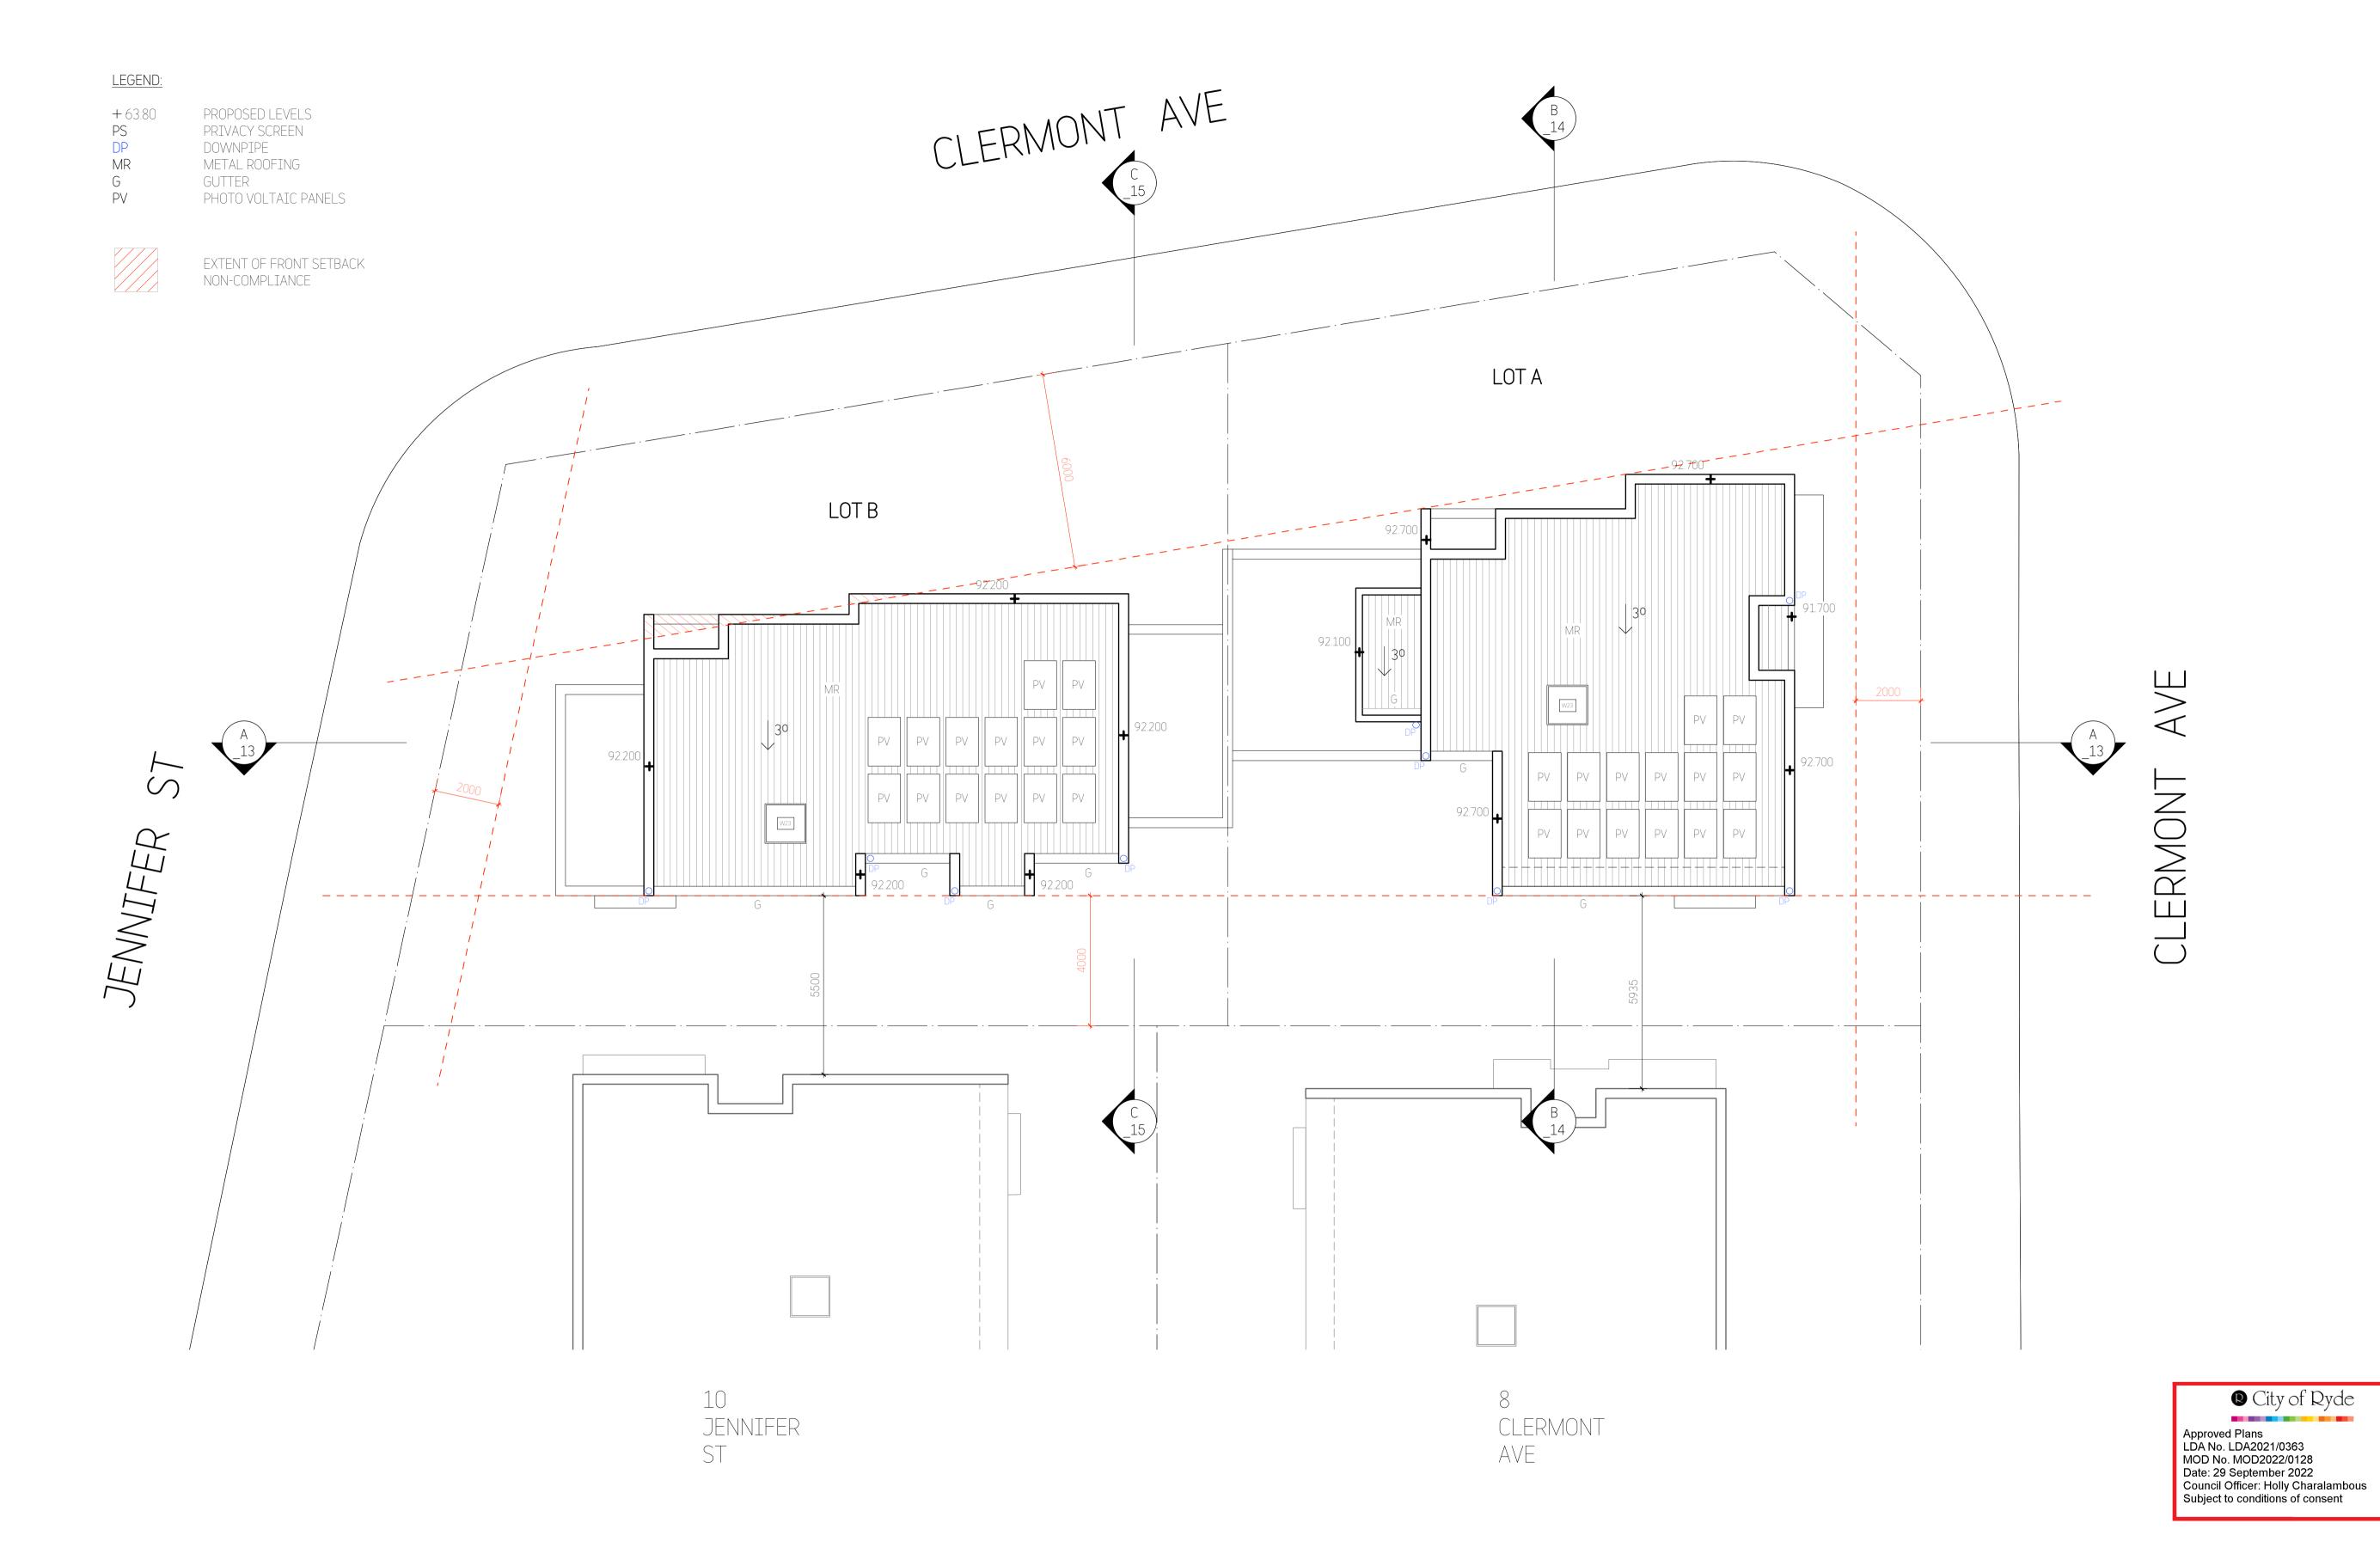
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FIRST FLOOR PLAN	783DA_A_	06 H



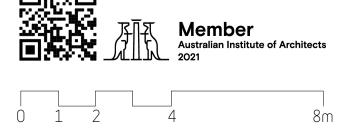

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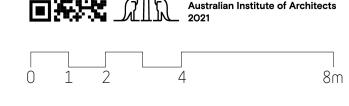


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ROOF PLAN	783DA_A_	07 F

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D	Revised Development Application Issue	BD	28/01/22	Figured dimensions to be used only. Do not scale off drawings. Any
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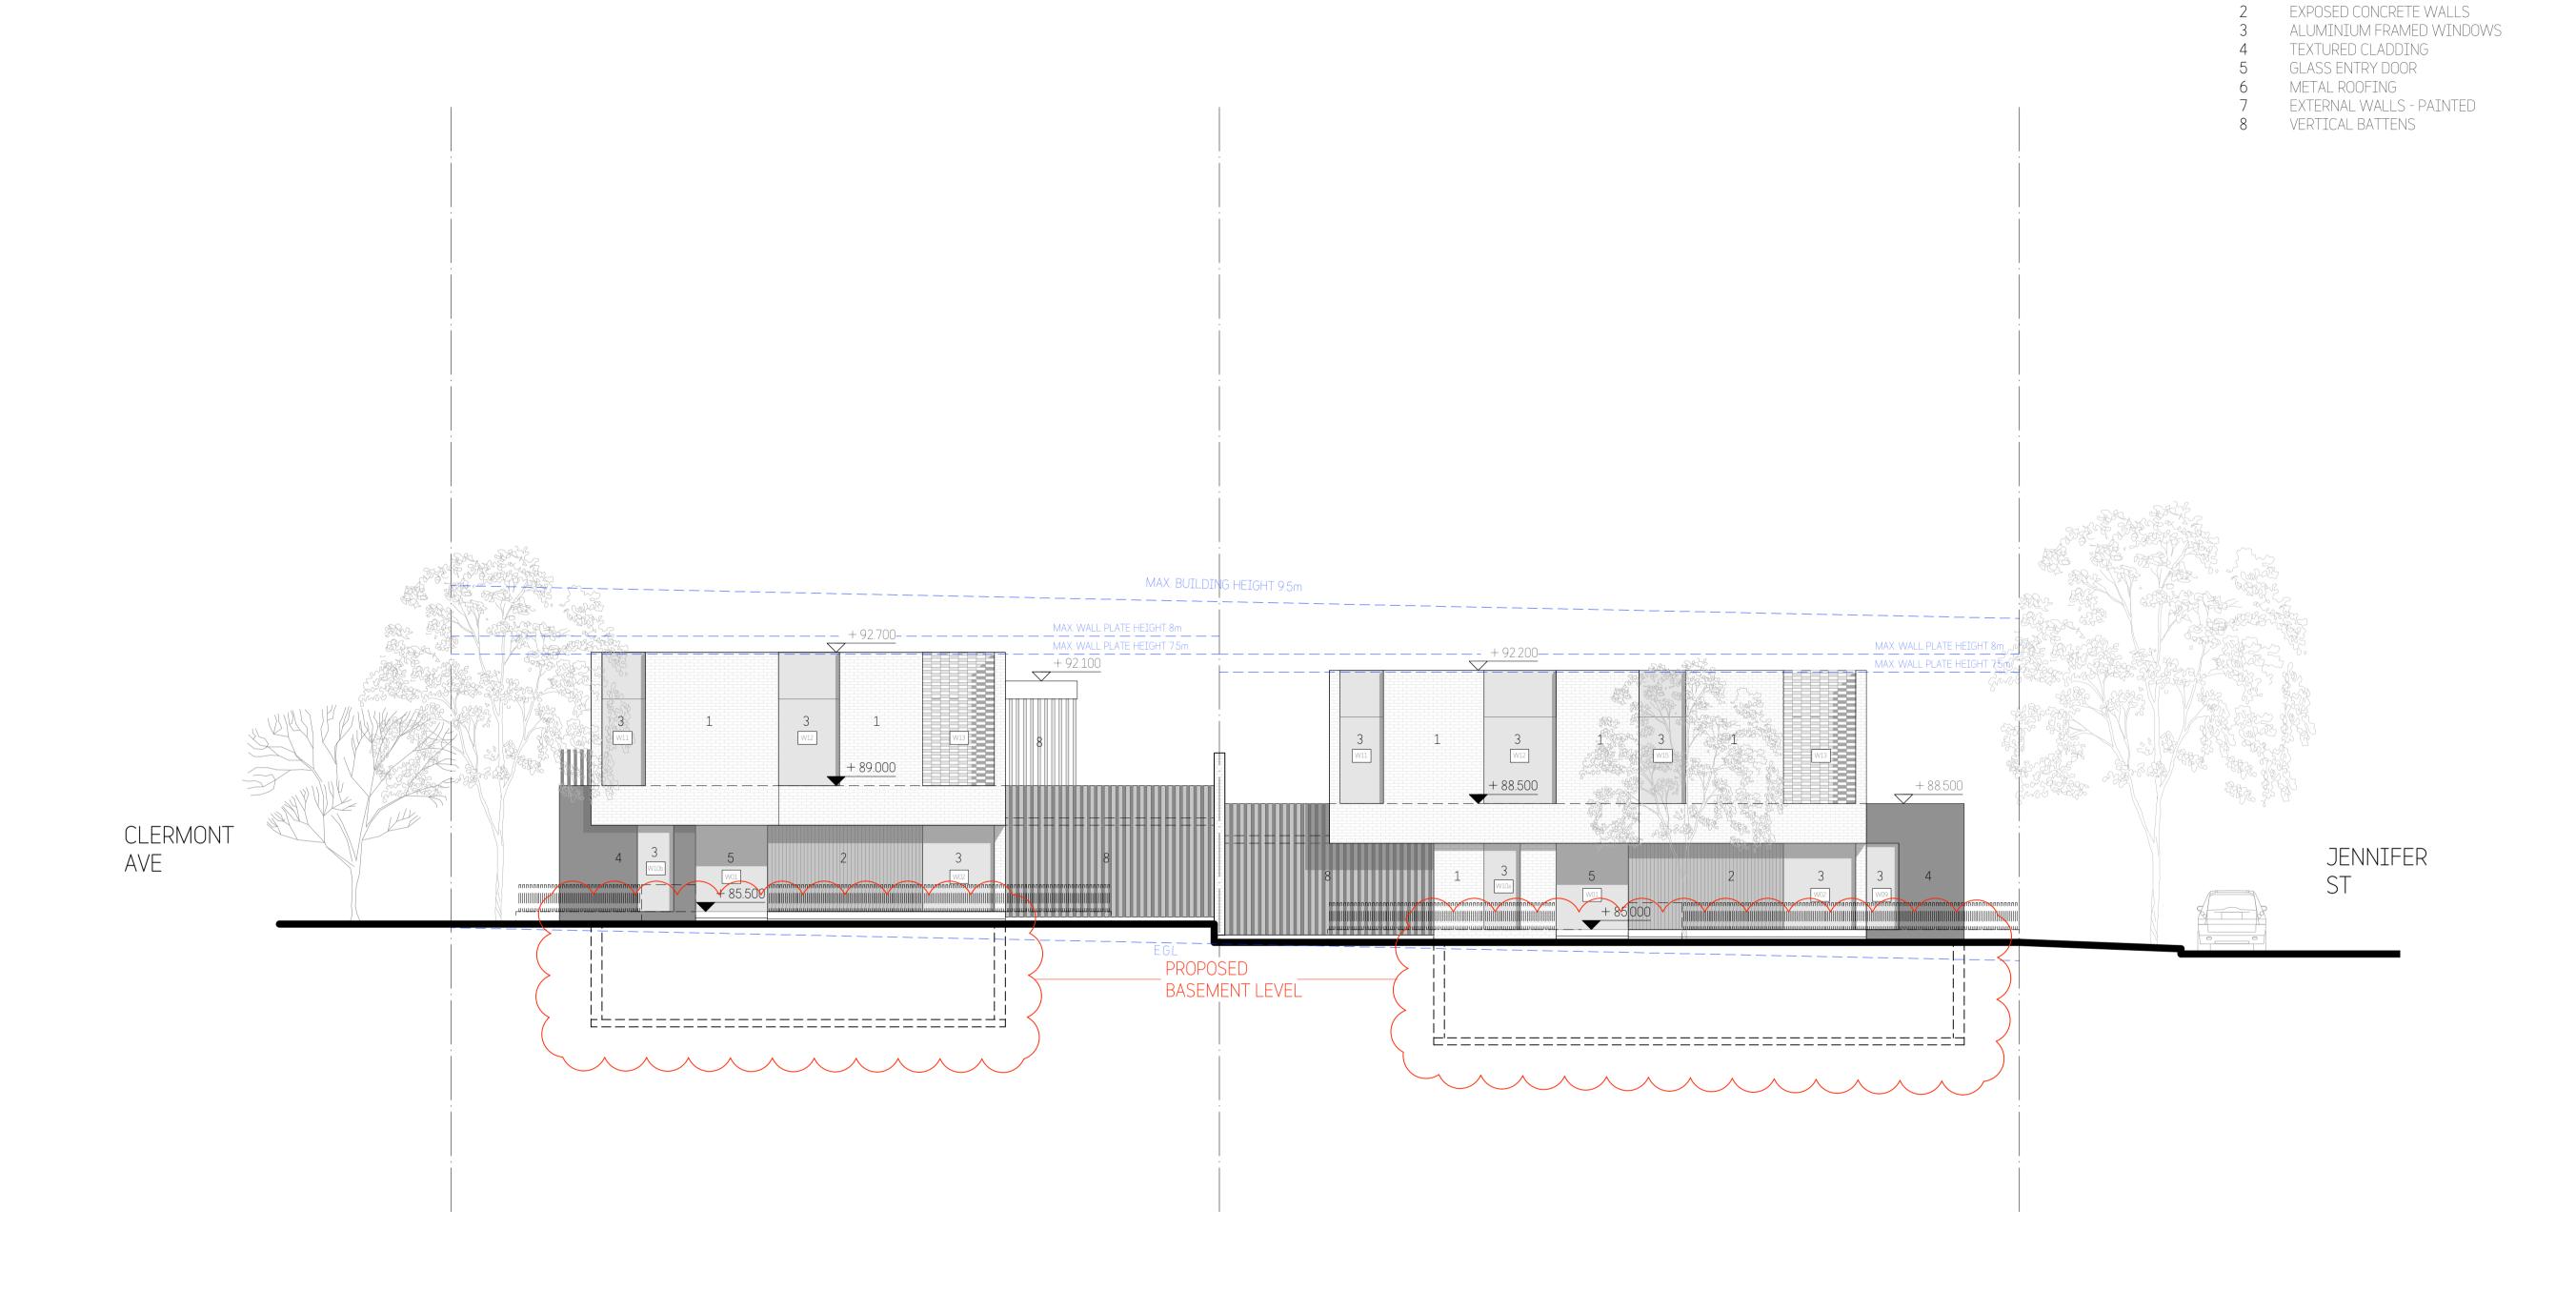
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00	EAST ELEVATION	7810	DA_A_	09		Е

City of Ryde

Approved Plans LDA No. LDA2021/0363 MOD No. MOD2022/0128 Date: 29 September 2022 Council Officer: Holly Charalambous Subject to conditions of consent

MATERIALS LEGEND: Refer to External Finishes Schedule

BRICKWORKS WALLS - PAINTED



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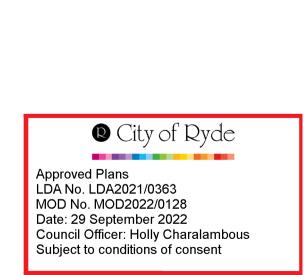
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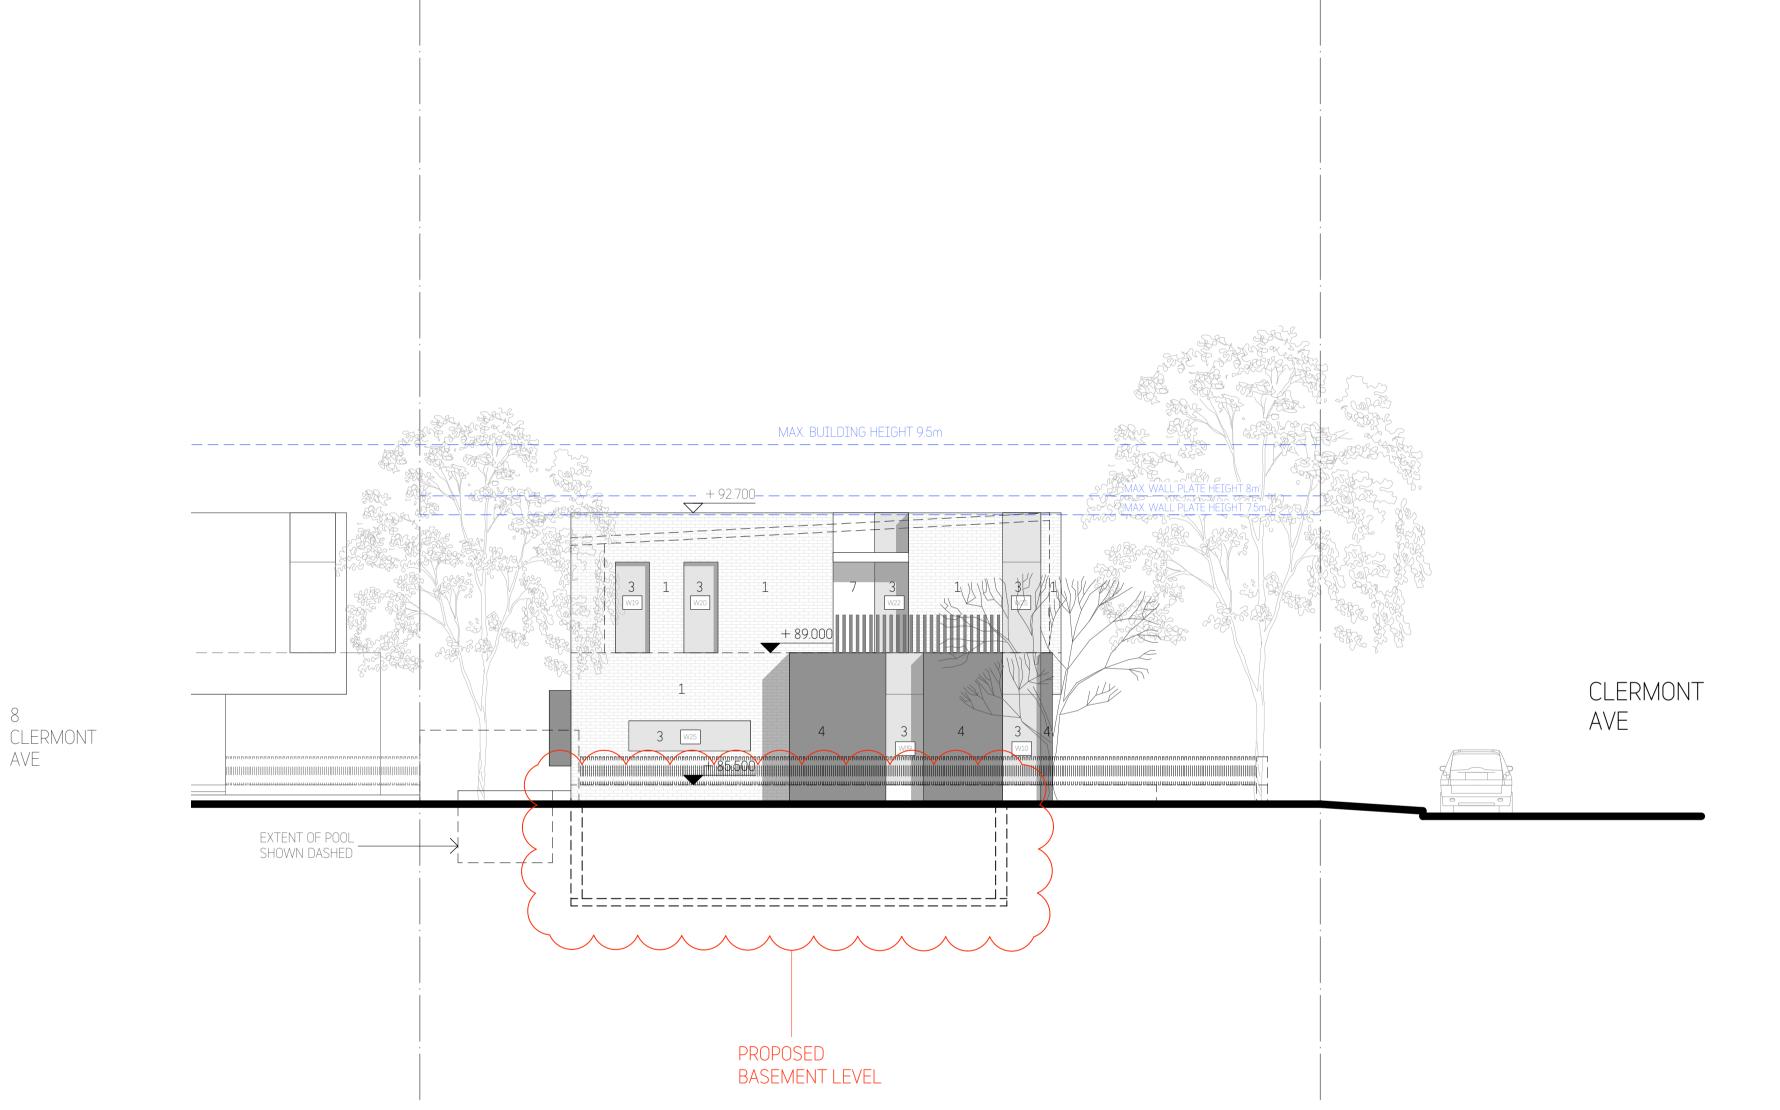






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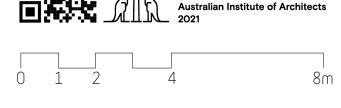
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- 1 BRICKWORKS WALLS PAINTED
- 2 EXPOSED CONCRETE WALLS
 - ALUMINIUM FRAMED WINDOWS
- TEXTURED CLADDING
- GLASS ENTRY DOOR
- METAL ROOFING
- EXTERNAL WALLS PAINTED VERTICAL BATTENS

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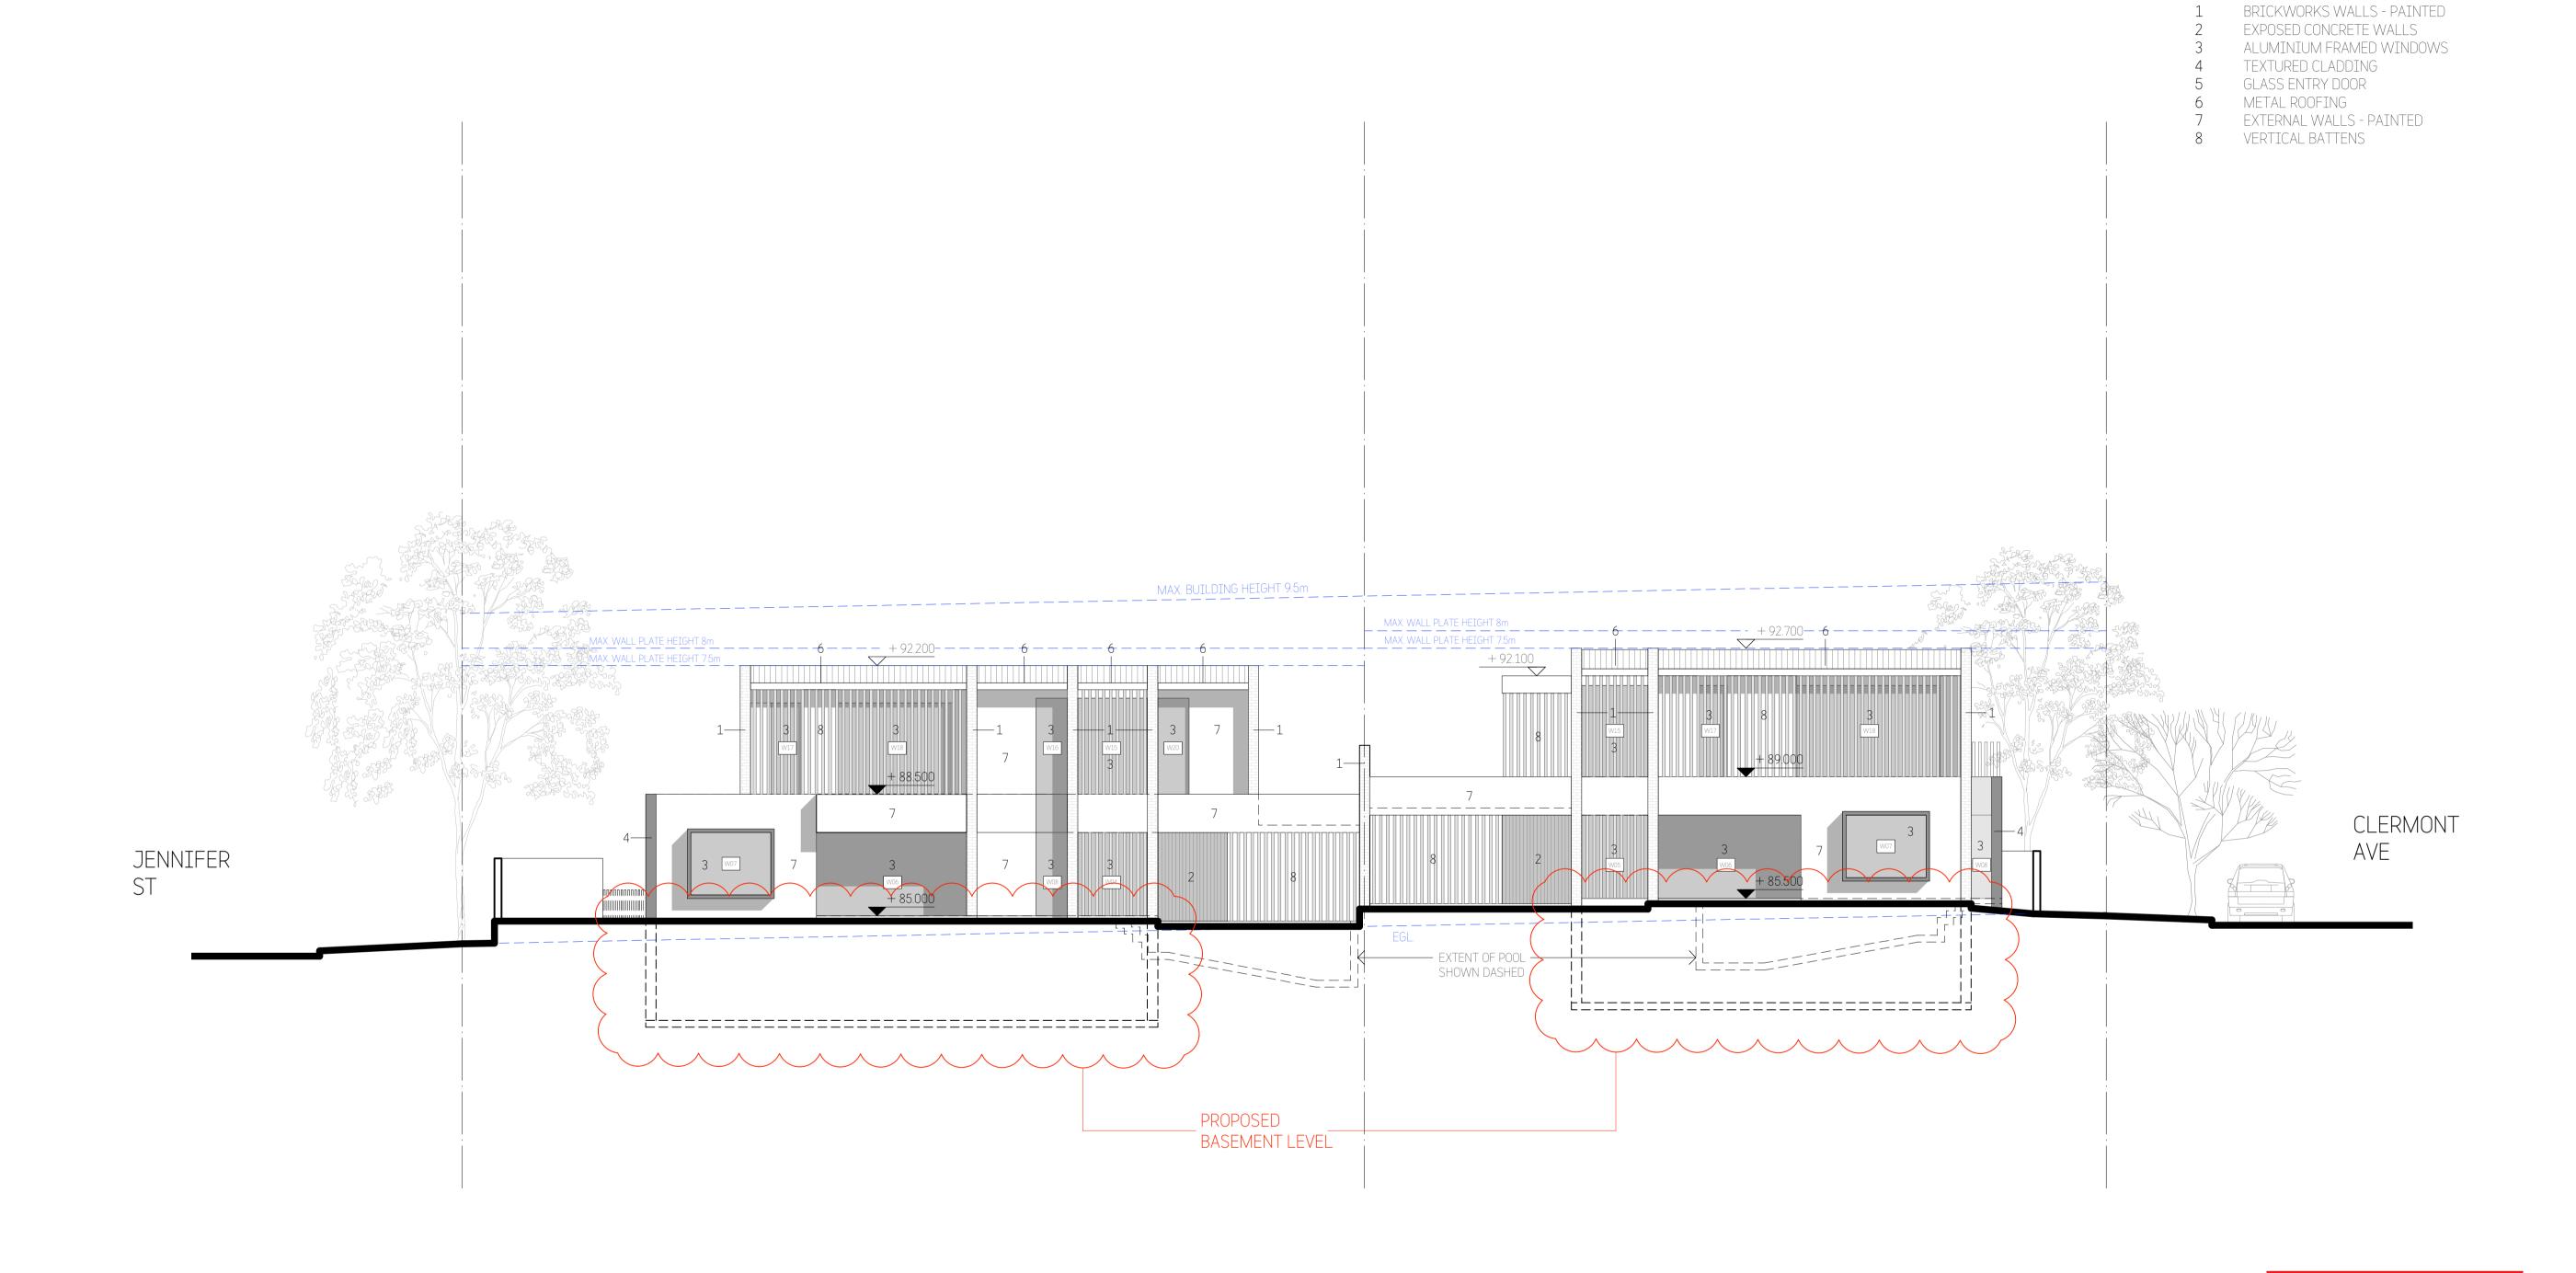
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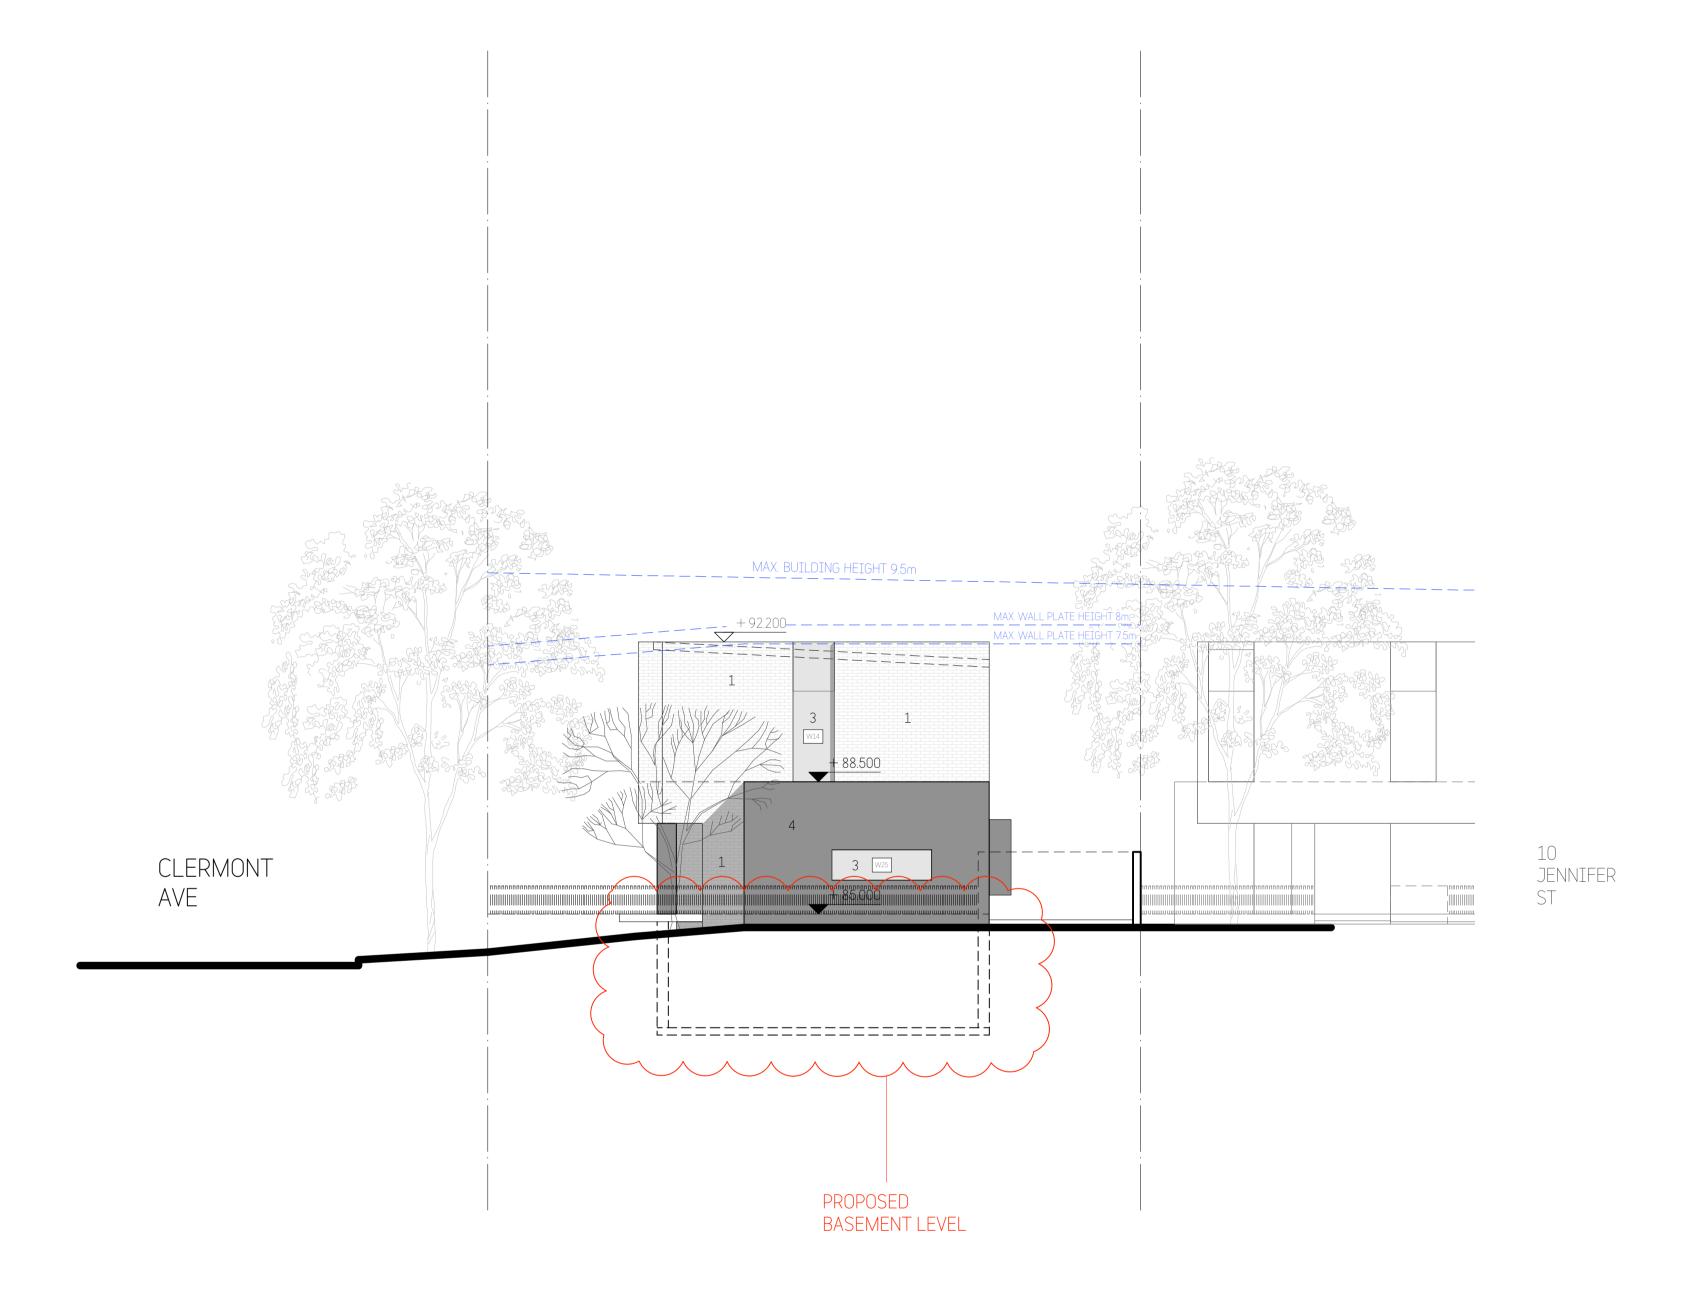
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1 BRICKWORKS WALLS - PAINTED 2 EXPOSED CONCRETE WALLS

> TEXTURED CLADDING GLASS ENTRY DOOR METAL ROOFING

VERTICAL BATTENS

ALUMINIUM FRAMED WINDOWS

EXTERNAL WALLS - PAINTED

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& INTERIORS -

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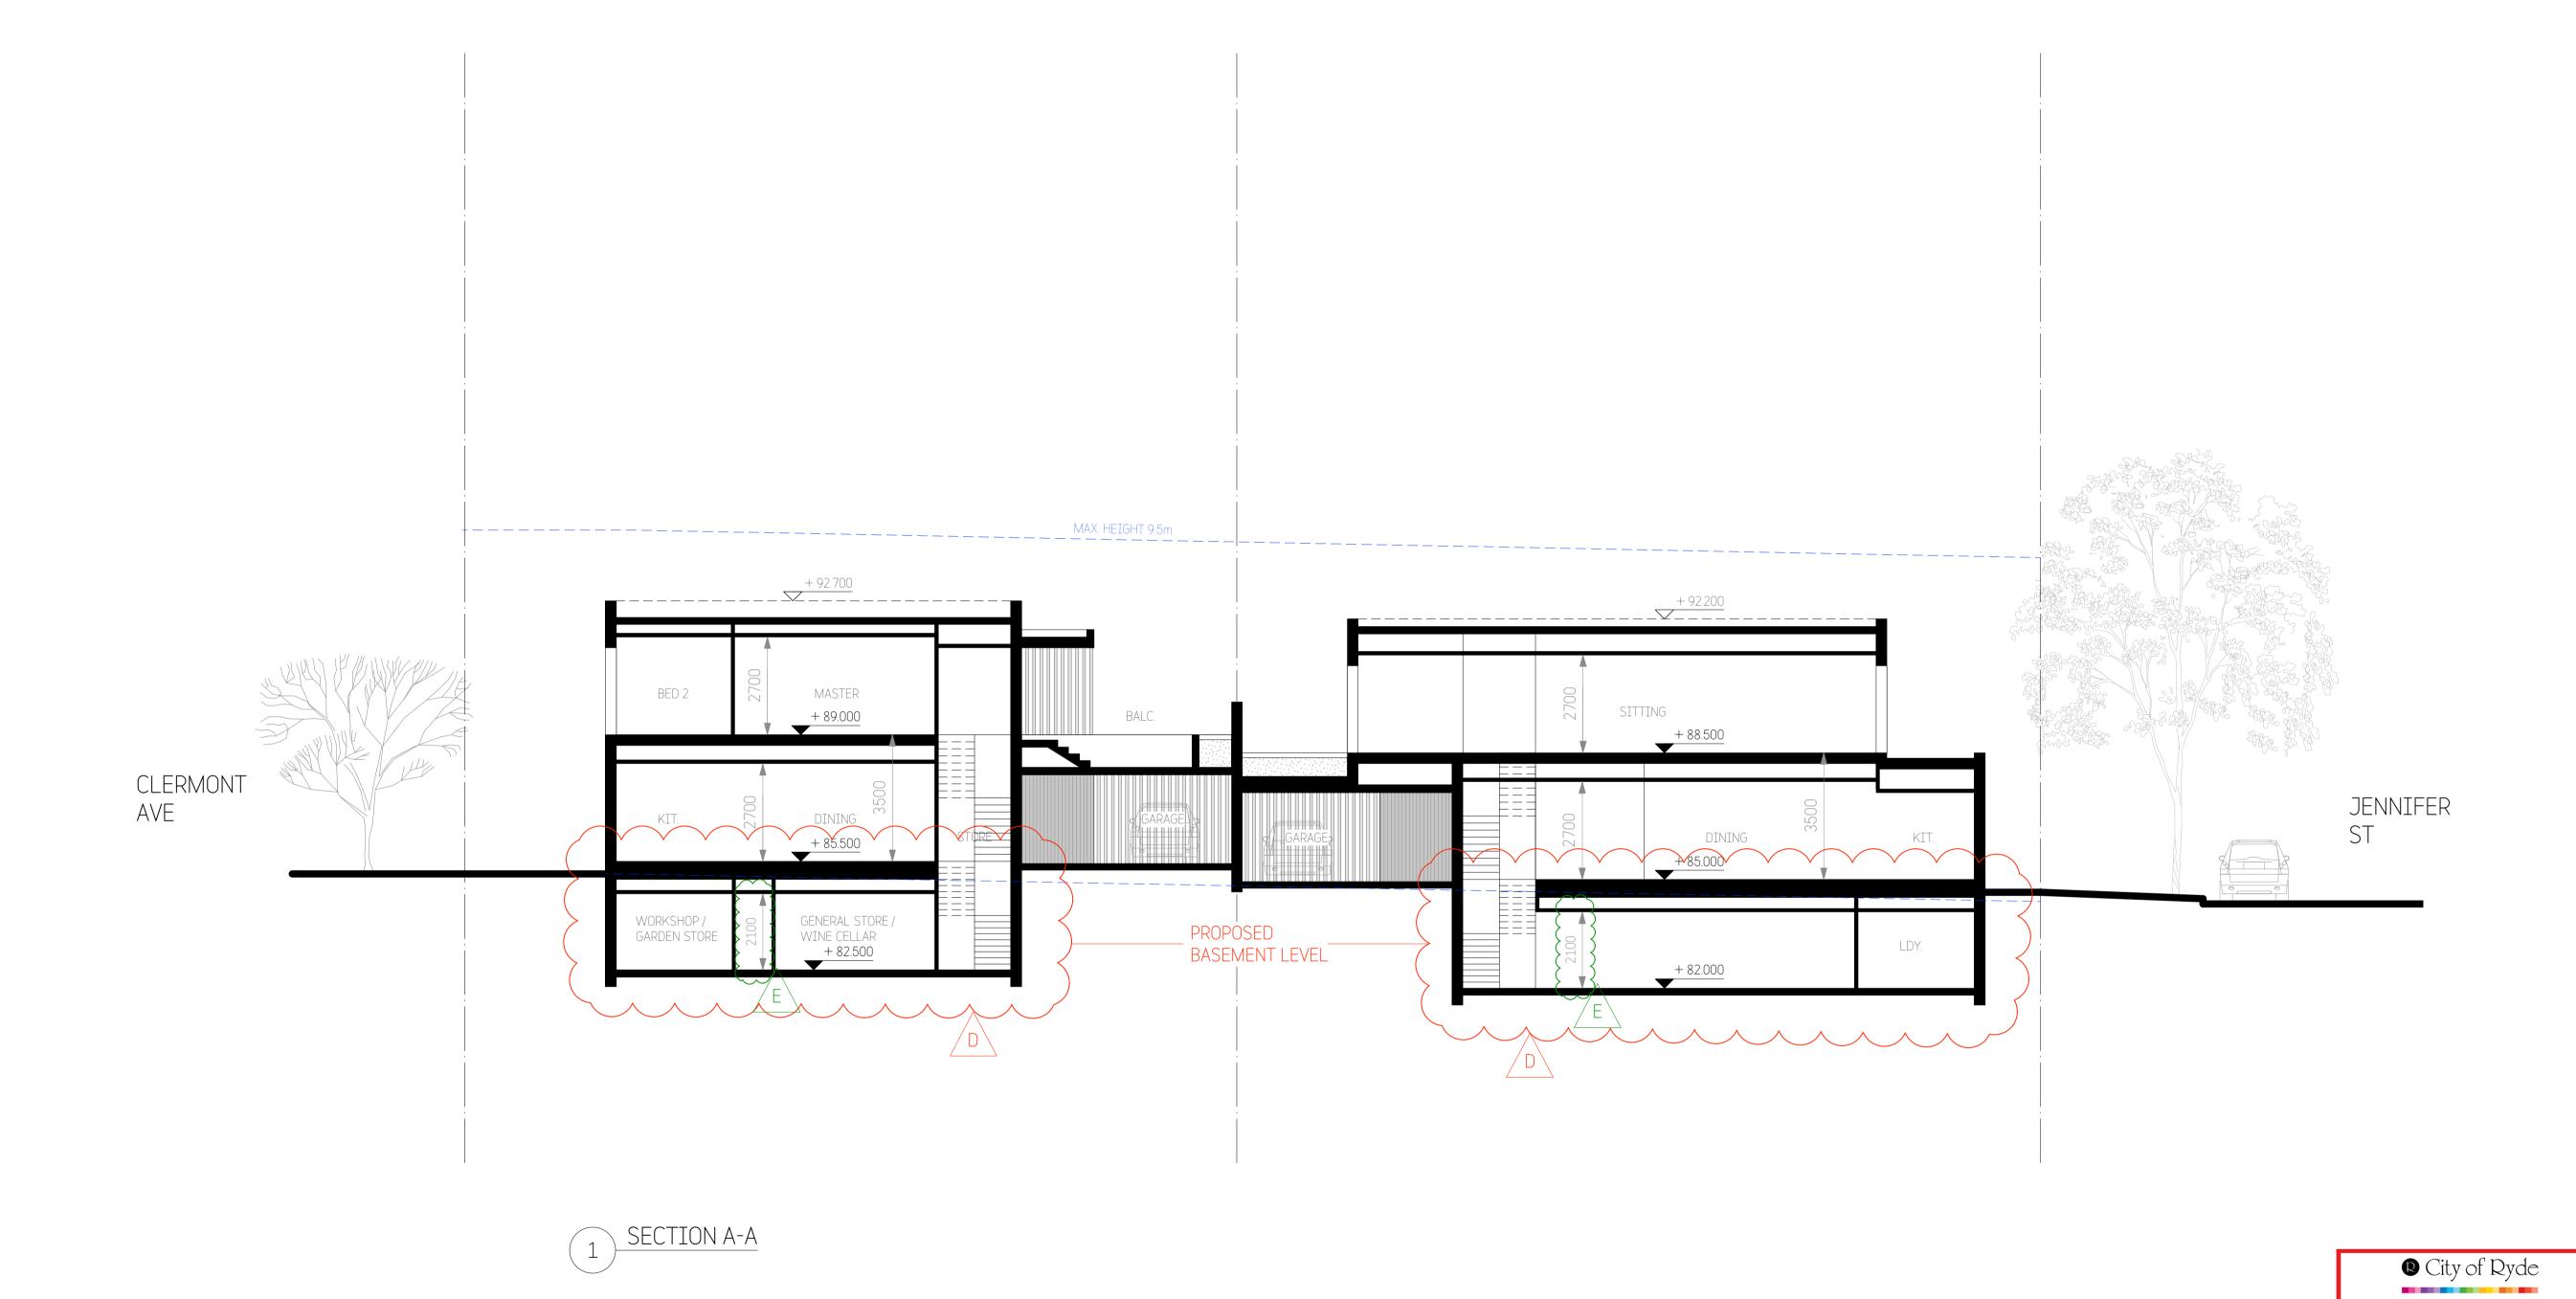
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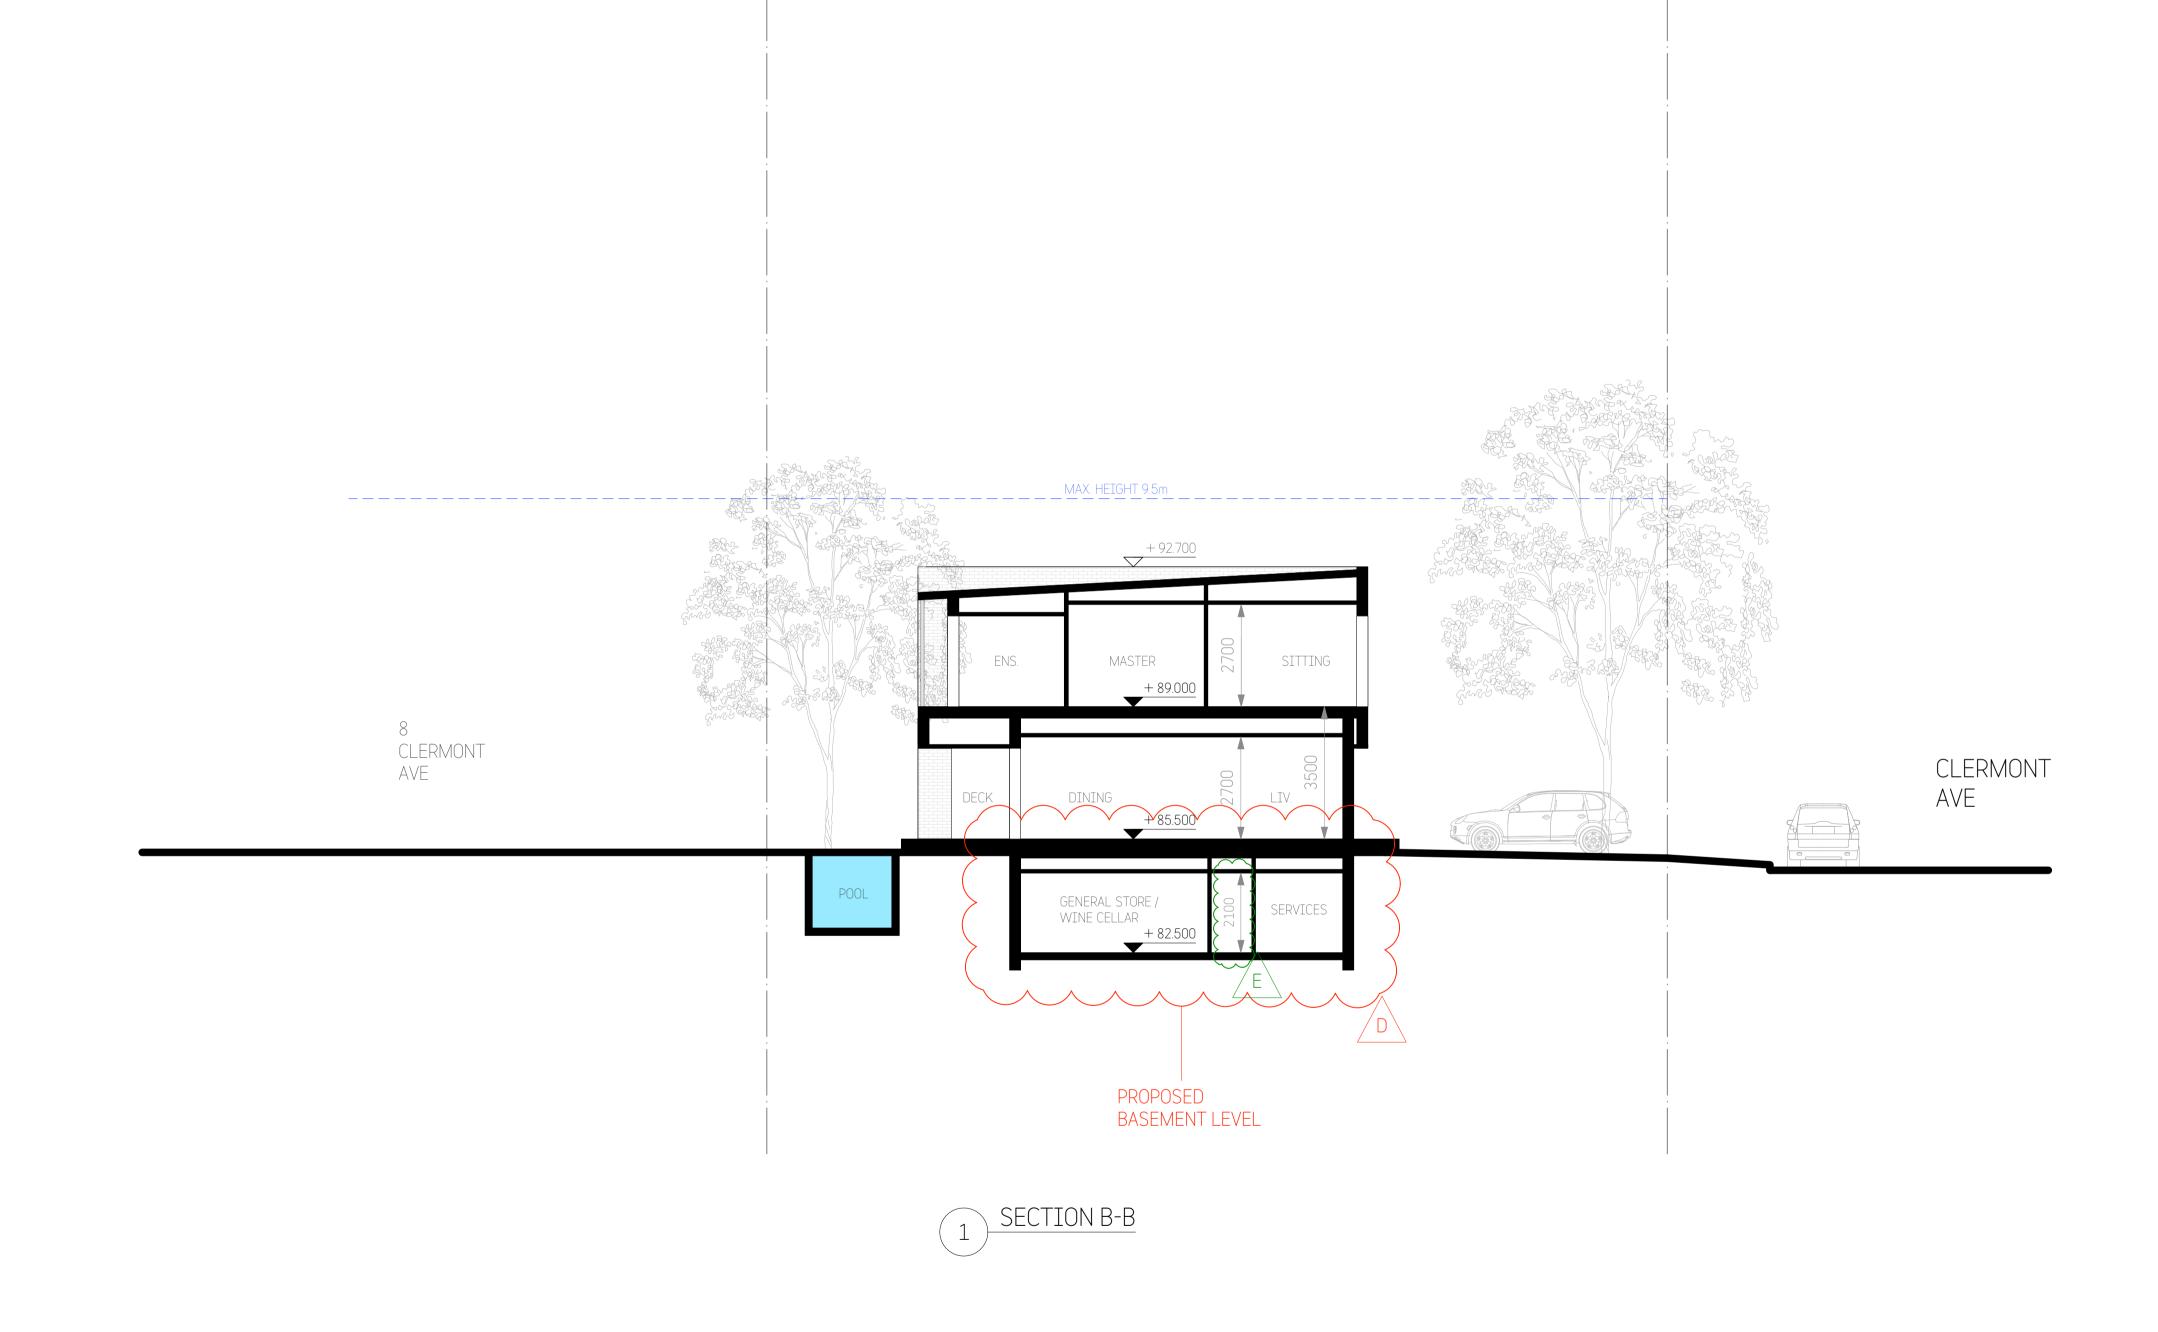


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abn: 74 219 560 78 ⁻	7

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Date

28/09/21

28/01/22

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Revisions:

No Description

Development Application Issue

Revised Section 4.55 Issue

Section 4.55 Issue

Revised Development Application Issue

Drawn: BD Date: 20/07/21 12 CLERMONT AVE, RYDE Scale: 1:200@A3 1:100@A1 Checked: BD Sheet Size: A3/A1 STUDIO_BD ARCHITECTURE & INTERIORS Title:

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t: 0414 866 065 e: boris@studiobd.com.au SFC. Job No: Drawing No: 783DA_A_ SECTIONS - 2

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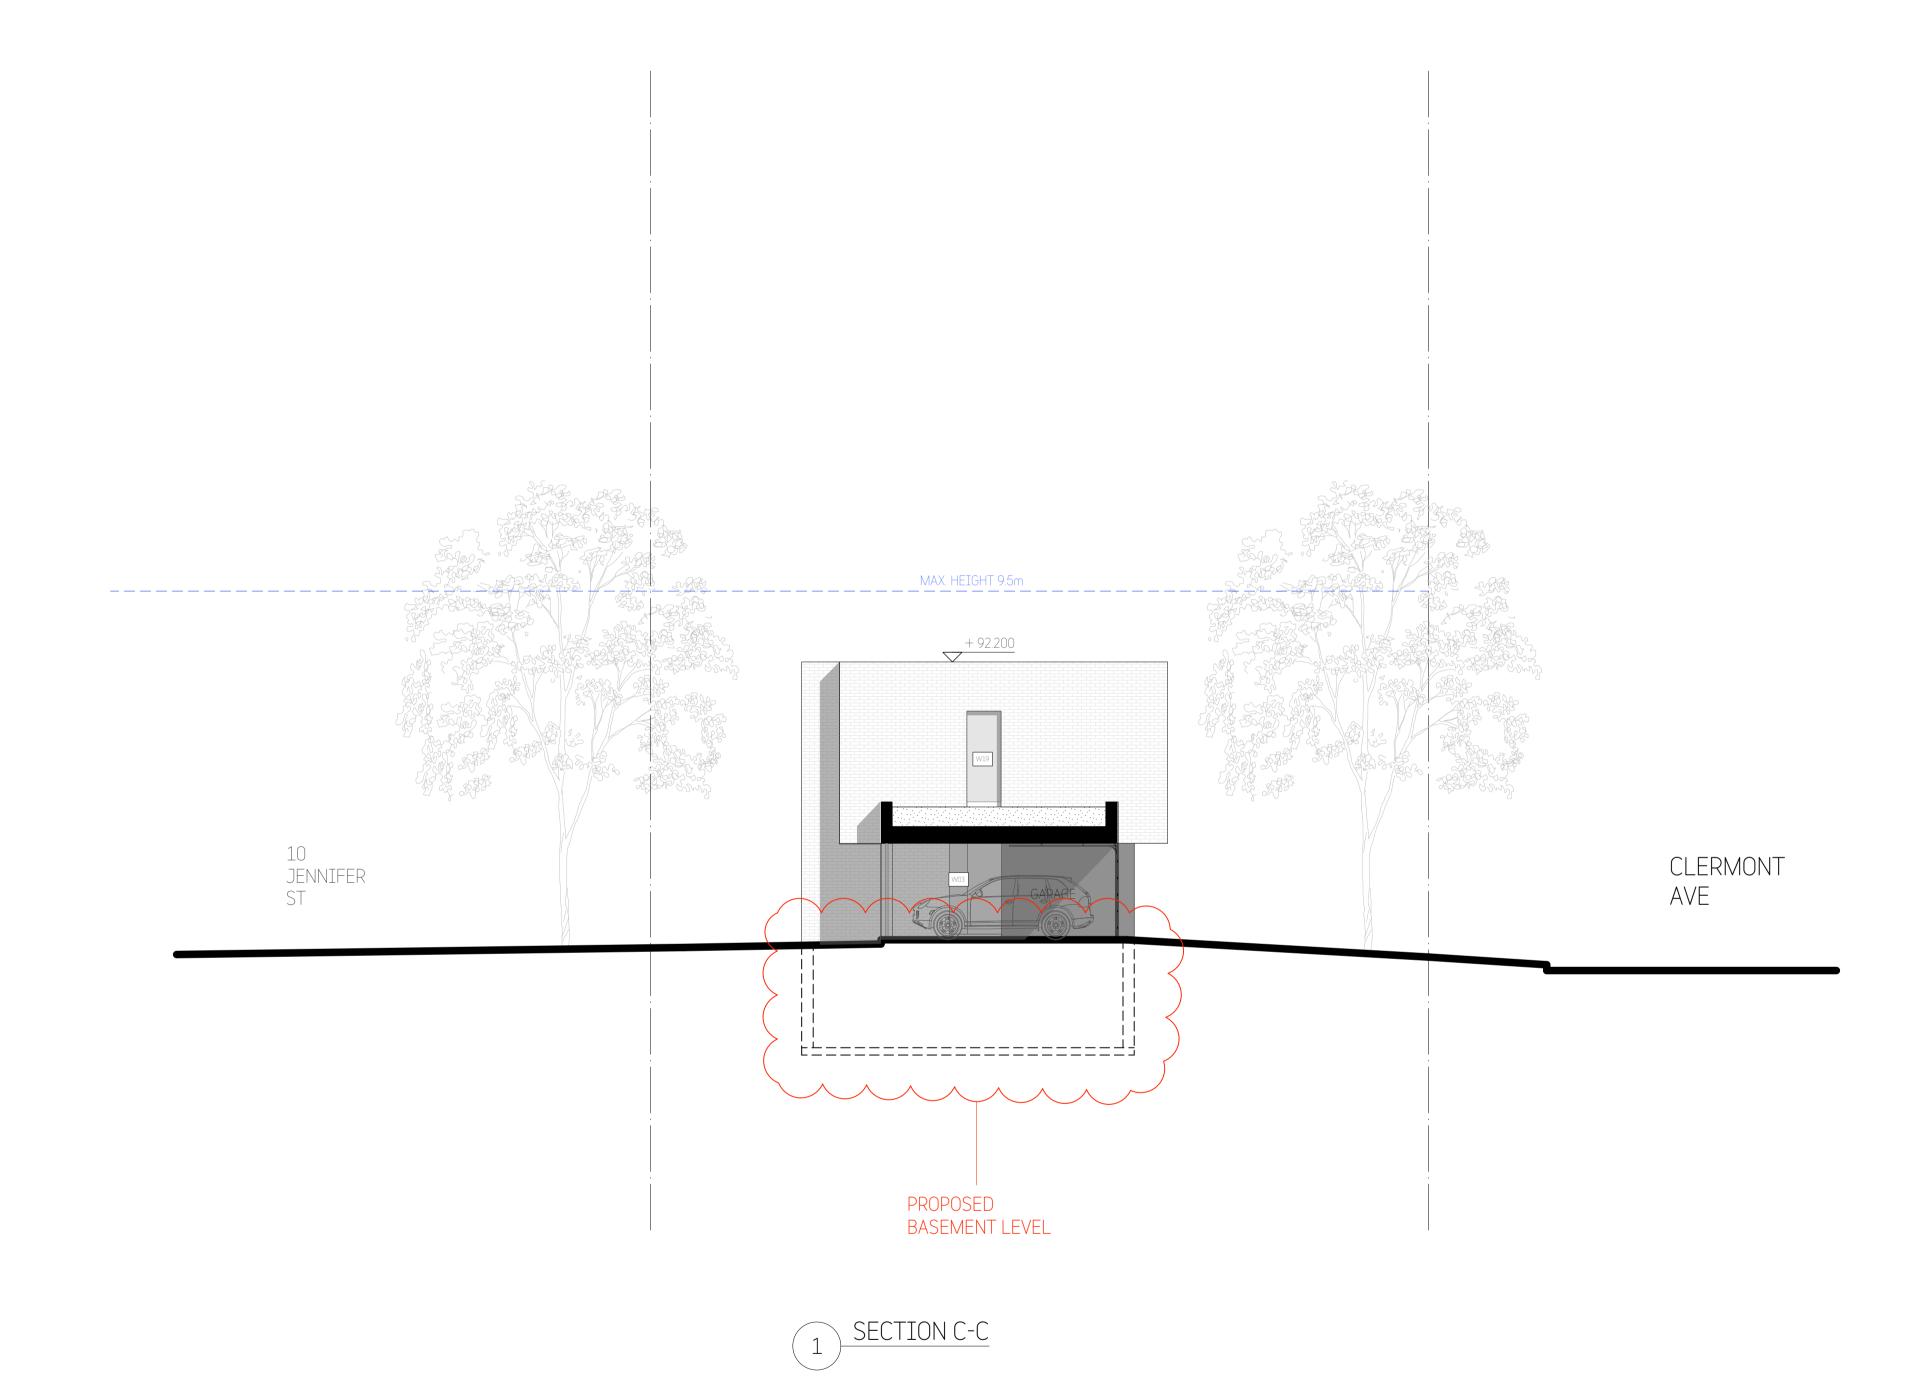





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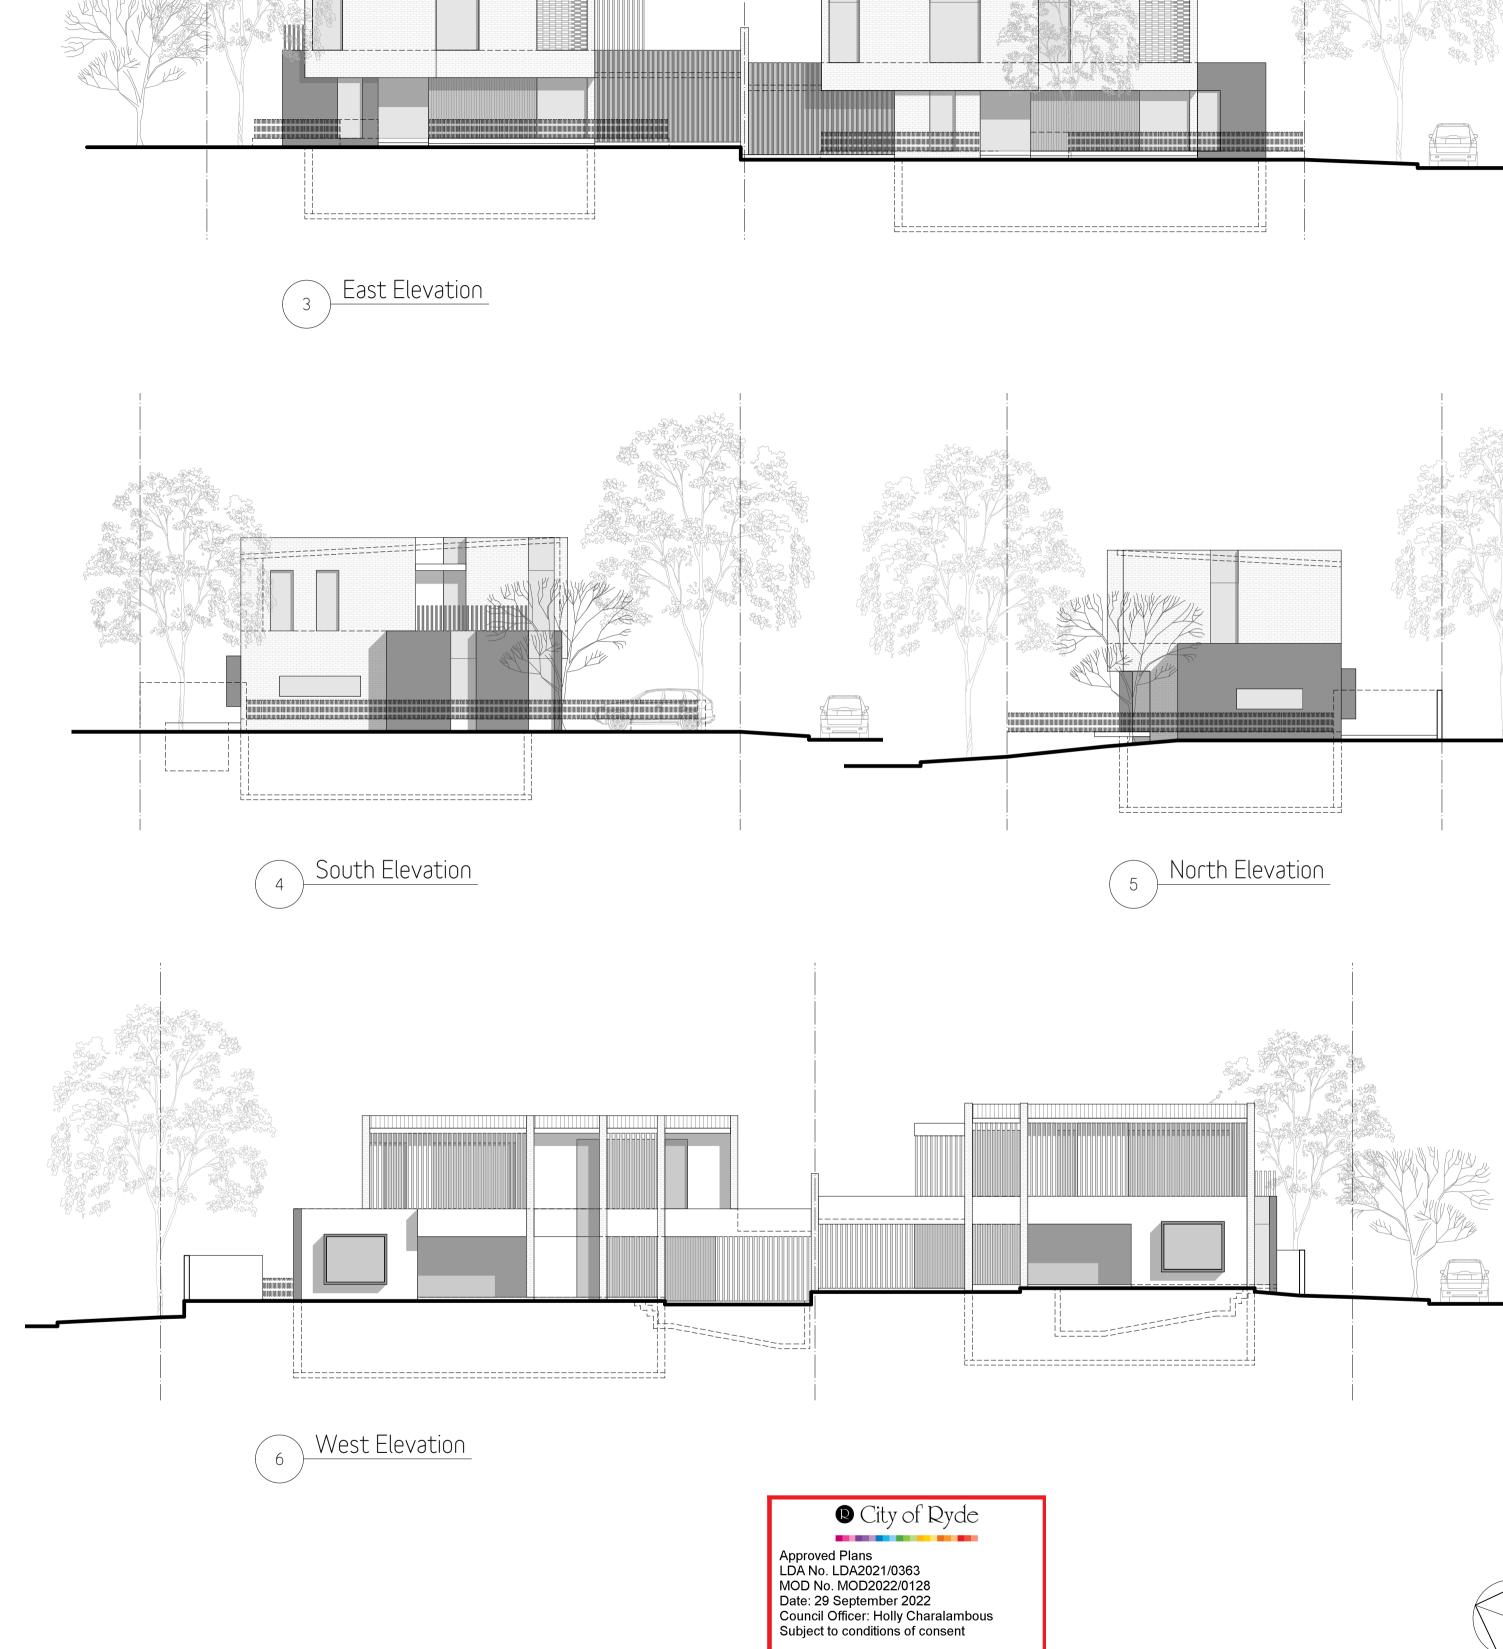
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Approved Plans LDA No. LDA2021/0363 MOD No. MOD2022/0128 Date: 29 September 2022 Council Officer: Holly Charalambous Subject to conditions of consent







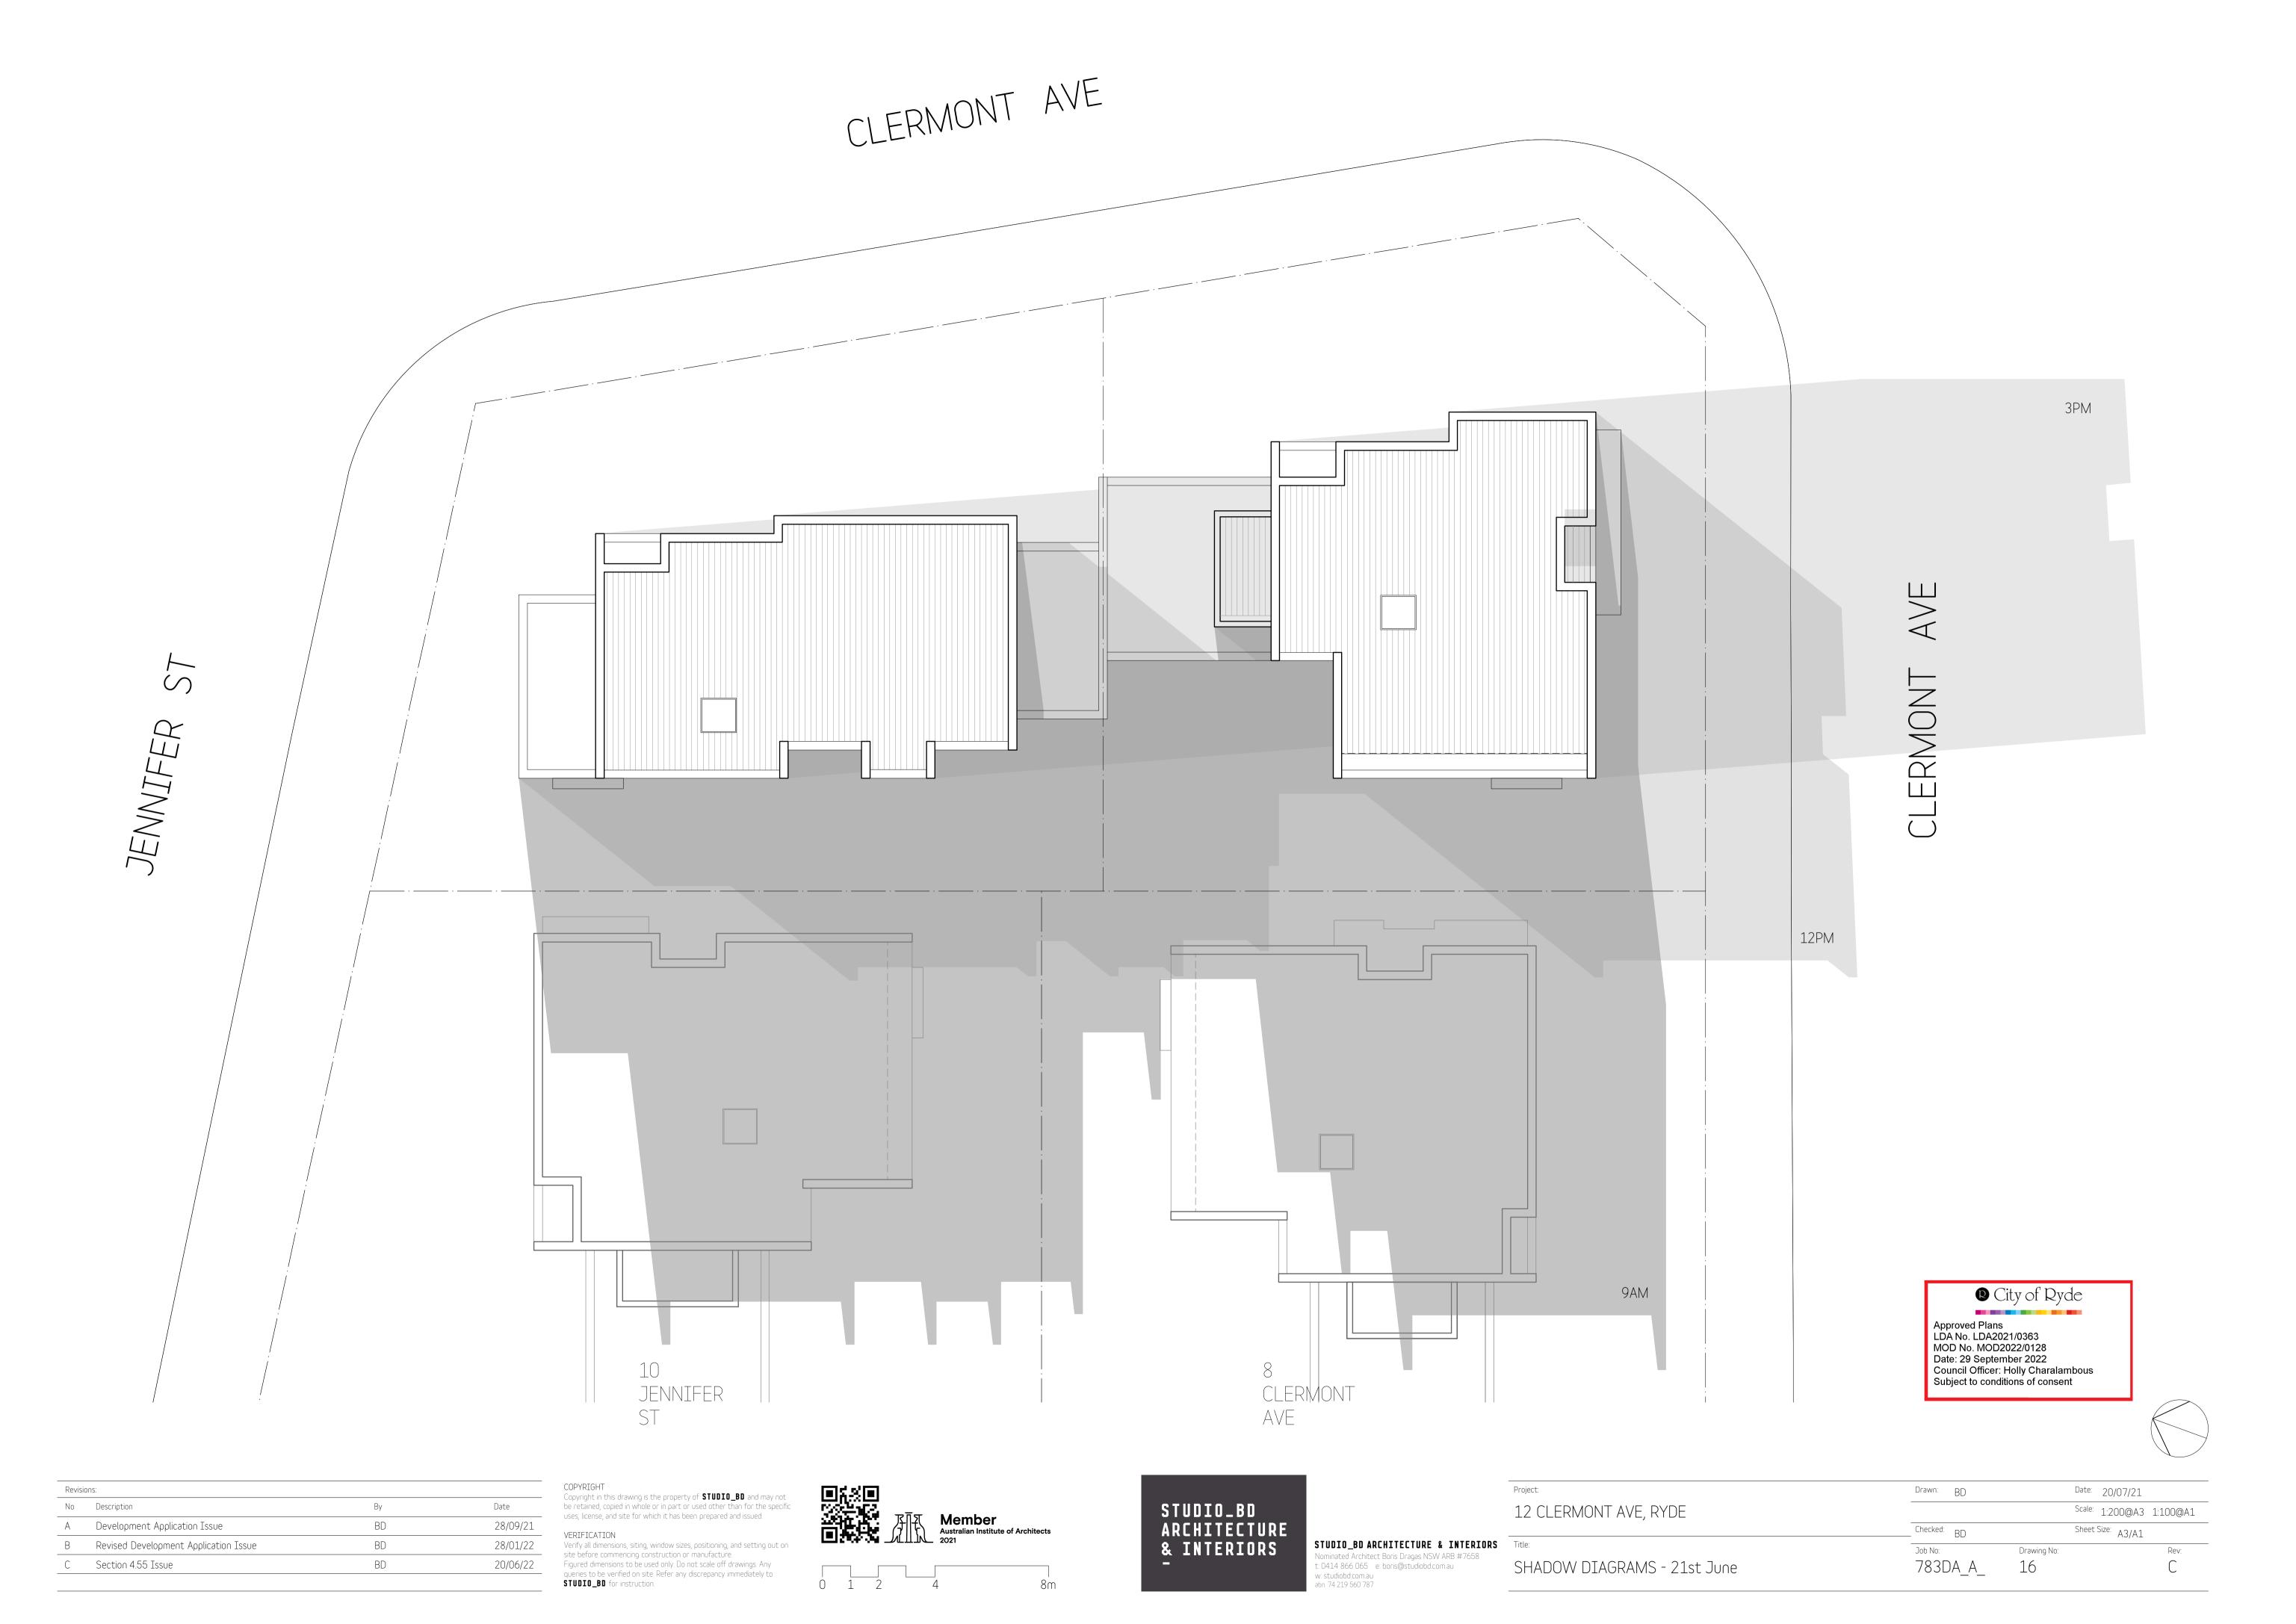

12 CLERMONT AVE, RYDE

NOTIFICATION PLANS

STUDIO_BD ARCHITECTURE & INTERIORS

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Title:

w: studiobd.com.au abn: 74 219 560 787

STUDIO_BD ARCHITECTURE & INTERIORS Drawn: BD

Checked: BD

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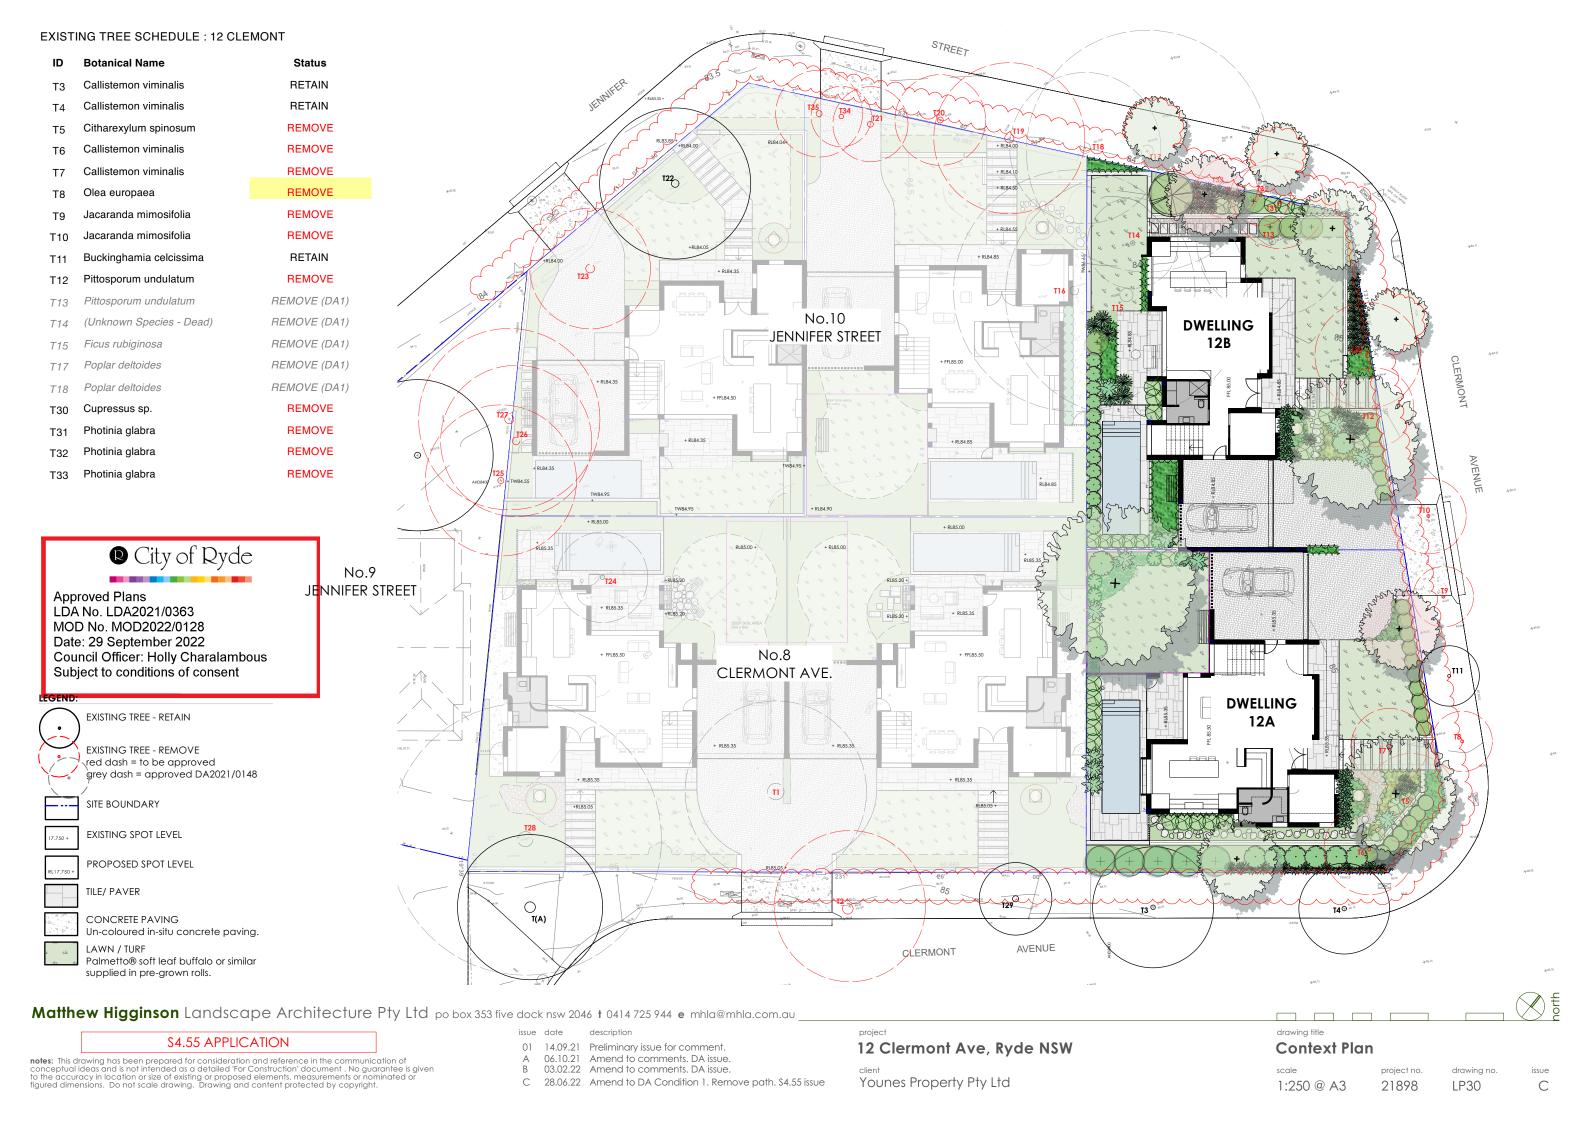
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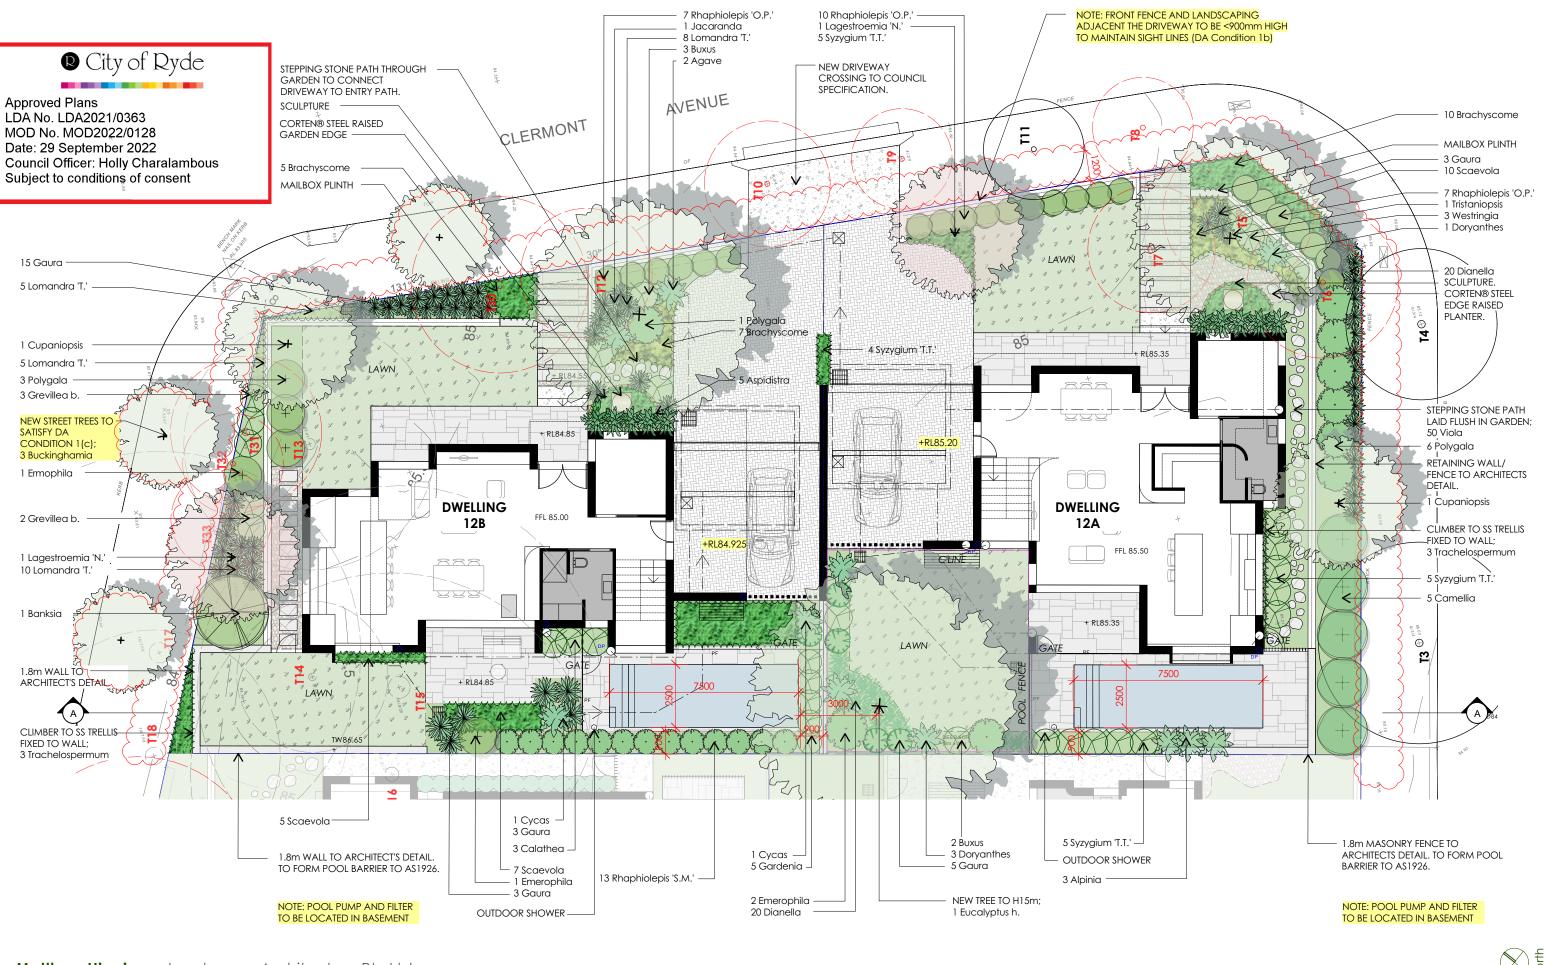
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Matthew Higginson Landscape Architecture Pty Ltd po box 353 five dock nsw 2046 t 0414 725 944 e mhla@mhla.com.au

\$4.55 APPLICATION

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01 14.09.21 Preliminary issue for comment.
A 06.10.21 Amend to comments. DA issue.

B 03.02.22 Amend to comments. DA issue.
C 28.06.22 Amend to DA Condition 1. Remove path. \$4.55 issue

12 Clermont Ave, Ryde NSW

Younes Property Pty Ltd

Landscape Plan

drawina title

scale project no. 1:150 @ A3 21898

LP31


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PLANT SCHEDULE: 12 CLERMONT AVE

Botanic Name	Common Name	Supply Size (mm/L)	Mature Height	Mature Spread	Qty
Trees					
Buckinghamia celsissima #	Ivory Curl Tree	45L	8m	4m	3
Cupaniopsis anacaroides	Tuckeroo	75L	6m	4m	2
Eucalyptus haemastoma *	Scribbly Gum	75L	15m	6m	1
Jacaranda mimosifolia	Jacaranda	75L	10m	8m	1
Lagestroemia 'Nafray'	Nafray Crepe Myrtle	75L	5m	4m	2
Tristaniopsis laurina *	Water Gum	75L	12m	4m	1
Shrubs					
Agave attenuata	Agave	200mm	1m	1m	5
Alpinia zerumbet 'Variagata'	Variagated Shell Ginger	200mm	2m	1m	3
Banksia marginata	Banksia	300mm	3m	2m	1
Buxus sempervirens	Boxwood	200mm	1m	1m	15
Camellia sasanqua	Camellia	45L	5m	2m	5
Crassula ovata	Jade Plant	200mm	1.2m	1.2m	3
Doryanthes excelsa	Gymea Lily	45L	1.2m	1.2m	4
Emerophila nivea	Silky Emu Bush	200mm	1.5m	1.5m	4
Gardenia thunbergia	Thunberg's Gardenia	300mm	2m	1m	5
Grevillea buxifolia	Grey Spider Flower	200mm	1m	1m	5
Phormium tenax	NZ Flax	300mm	1.5m	1.5m	1
Polygala myrtifolia	Milkwort	300mm	1.5m	1.5m	12
Rhaphiolepis 'Oriental Pearl'	Oriental Pearl Hawthorn	300mm	1m	1m	35
Rhaphiolepis 'Snow Maiden'	Snow Maiden Hawthorn	300mm	1.2m	1m	13
Syzygium australe 'Select'	Brush Cherry Select Form	300mm	2m	1m	5
Syzygium 'Tiny Trev'	Tiny Trev Lily Pily	200mm	1m	1m	14
Westringia 'Aussie Box'	Aussie Box Coast Rosemary	200mm	0.9m	0.9m	3
Palms / Ferns / Cycads					
Cycas revoluta	Sago Palm	45L	1.5m	1m	2
Groundcovers / Climbers					
Aspidistra elatior	Cast Iron Plant	200mm	1m	1m	5
Brachyscome multifida	Cut Leaf Daisy	200mm	0.3m	0.6m	42
Calathea zebrina	Zebra Plant	200mm	0.7m	0.7m	3
Dianella caerulea	Flax Lily	140mm	0.7m	0.7m	40
Dichondra 'Silver Falls'	Silver Falls Kidney Weed	140mm	0.2m	1m	14
Gaura lindheimeri	Butterfly Bush	200mm	1.2m	1m	26
Lomandra 'Tanika'	Tanika Mat Rush	140mm	0.7m	0.7m	48
Scaevola aemula	Fan Flower	140mm	0.3m	0.6m	22
Trachelospermum jasminoides	Star Jasmine	140mm	0.3m	1m	6
Viola hederacea	Native Violet	140mm	0.2m	0.5m	50

- * Denotes selection to satisfy Council DCP part 2.13 Landscaping
- # Denotes selection to satisfy Council DA condition 1(c) & 32 (LDA2021/0363)





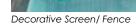





Patio Fireplace : 2-sided



Landscape steps



Driveway: Cobblestone



Paving: Stone Flagging



Stepping Stones



Steel Edge : Corten®



Approved Plans LDA No. LDA2021/0363 MOD No. MOD2022/0128 Date: 29 September 2022 Council Officer: Holly Charalambous Subject to conditions of consent



Eucalyptus haemastona





Jacaranda mimosifolia



Cupaniopsis anacaroides



Alpinia zerumbet 'Variagata'



Buxus sempervirens



Grevillea buxifolia



Westringia 'Aussie Box'



Rhaphiolepis 'Oriental Pearl'



Polygala myrtifolia



Gaura lindheimerii



Phormium tenax

Matthew Higginson Landscape Architecture Pty Ltd po box 353 five dock nsw 2046 t 0414 725 944 e mhla@mhla.com.au _

\$4.55 APPLICATION

notes: This drawing has been prepared for consideration and reference in the communication of conceptual ideas and is not intended as a detailed 'For Construction' document. No guarantee is given to the accuracy in location or size of existing or proposed elements, measurements or nominated or figured dimensions. Do not scale drawing. Drawing and content protected by copyright.

01 14.09.21 Preliminary issue for comment.

A 06.10.21 Amend to comments. DA issue. B 03.02.22 Amend to comments. DA issue.

C 28.06.22 Amend to DA Condition 1. Remove path. \$4.55 issue

12 Clermont Ave, Ryde NSW


Younes Property Pty Ltd

Schedule + Materials

1:1 @ A3

21898



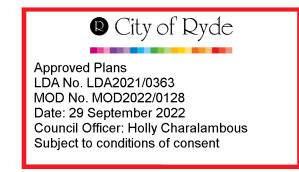

Matthew Higginson Landscape Architecture Pty Ltd po box 353 five dock nsw 2046 t 0414 725 944 e mhla@mhla.com.au _

\$4.55 APPLICATION

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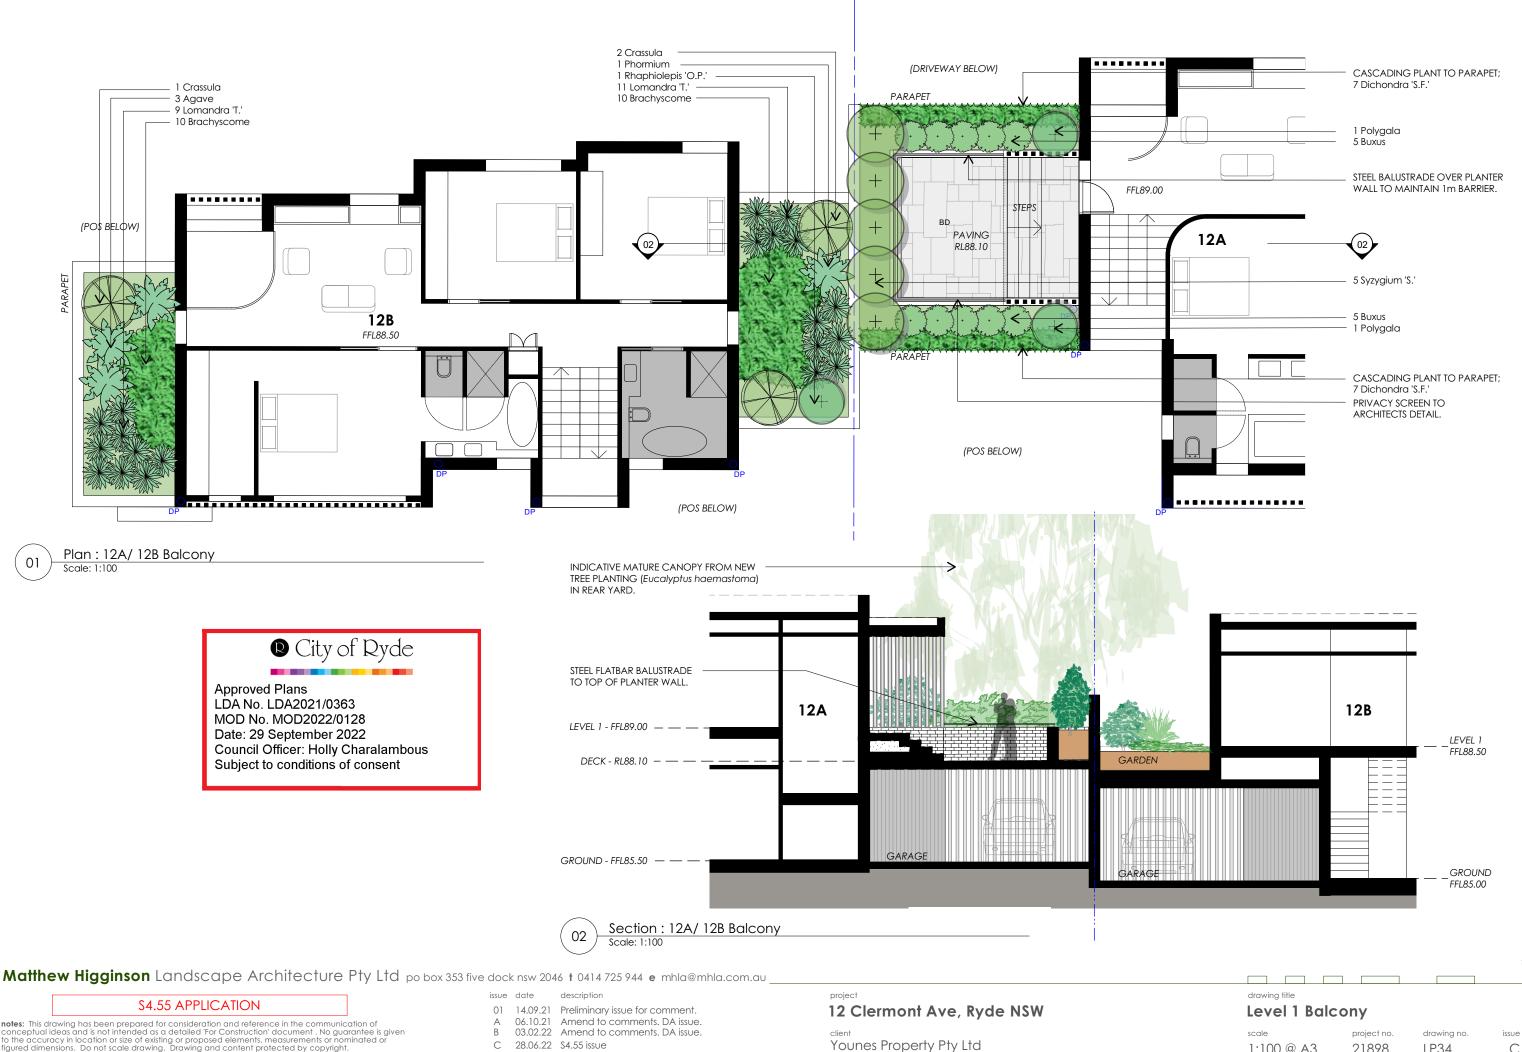
12 Clermont Ave, Ryde NSW

Younes Property Pty Ltd

drawing title **Section A**

1:150 @ A3


21898 LP33



notes: This drawing has been prepared for consideration and reference in the communication of conceptual ideas and is not intended as a detailed 'For Construction' document. No guarantee is given to the accuracy in location or size of existing or proposed elements, measurements or nominated or figured dimensions. Do not scale drawing. Drawing and content protected by copyright.

1:100 @ A3 21898

LP34

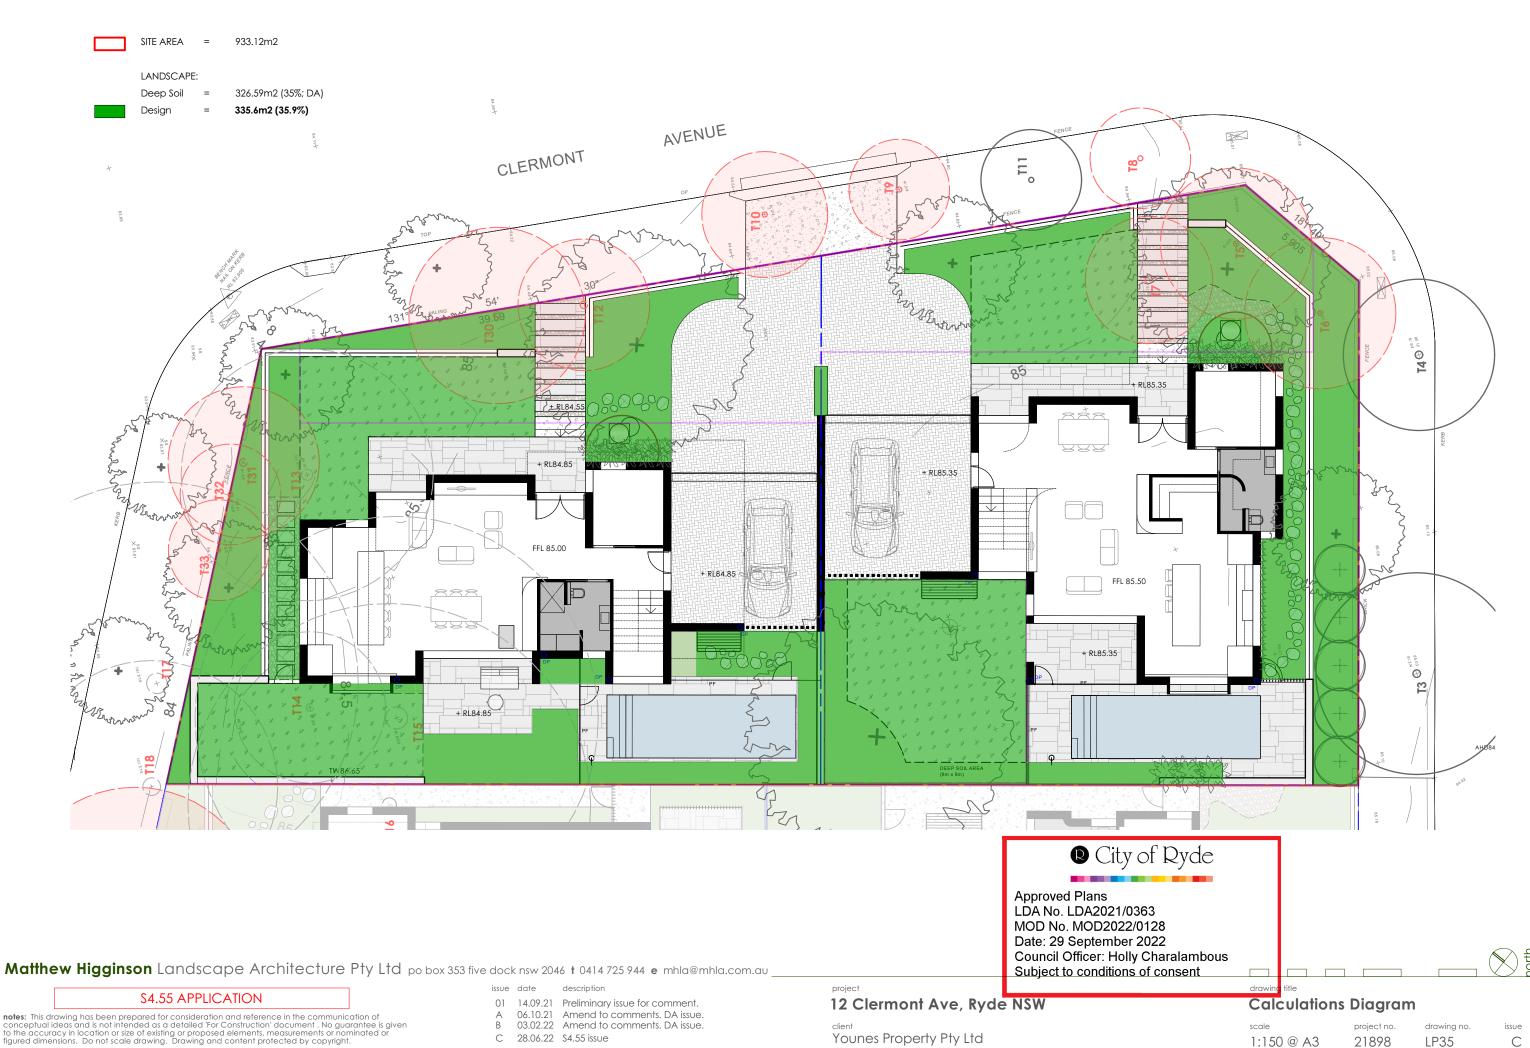

notes: This drawing has been prepared for consideration and reference in the communication of conceptual ideas and is not intended as a detailed 'For Construction' document. No guarantee is given to the accuracy in location or size of existing or proposed elements, measurements or nominated or figured dimensions. Do not scale drawing. Drawing and content protected by copyright.

1:150 @ A3

21898

LP35

Application Number:MOD2022/0128 Council Officer:Emily Lu Date: 09/09/2022

STORMWATER MANAGEMENT PLAN PROPOSED DUAL OCCUPANCY - S4.55 No.12 CLERMONT AVENUE, RYDE

City of Ryde

Approved Plans

LDA No. LDA2021/0363 MOD No. MOD2022/0128 Date: 29 September 2022

Council Officer: Holly Charalambous
Subject to conditions of consent

GENERAL NOTES:

- 1. THESE PLANS REMAIN THE PROPERTY OF NY CIVIL ENGINEERING PTY LTD AND ARE SUBJECT TO COPYRIGHT
- ALL DIMENSIONS IN MILLIMETERS UNLESS OTHERWISE STATED. ALL REDUCED LEVELS (SURFACE LEVELS, INVERT LEVELS) AND CHAINAGES ARE
 IN METERS UNLESS OTHERWISE STATED. DO NOT SCALE OFF THE DRAWINGS, SCALES ARE AS SHOWN, USE FIGURED DIMENSIONS.
- THIS PLAN IS TO BE READ IN JUNCTION WITH LATEST ARCHITECTURAL, STRUCTURAL, UTILITY AND LANDSCAPE PLANS IN ADDITION TO ANY RELEVANT GEOTECHNICAL, SOIL CLASSIFICATION OR REF/ENVIRONMENTAL REPORTS. ENGINEER IS TO BE NOTIFIED OF ANY DISCREPANCIES ONLY TO NOT THE PLAN
- 4. ALL WORKS SHALL BE CARRIED OUT TO LOCAL COUNCIL'S DEVELOPMENT CONTROL PLAN AND SPECIFICATIONS, AS/NZS 3500.3 AND B.C.A.
- 5. ALL LEVELS SHALL RELATE TO THE ESTABLISHED BM, PM AND/OR LM. ALL EXISTING SERVICES ARE TO BE VERIFIED FOR LOCATION AND DEPTH PRIOR TO COMMENCEMENT OF ANY WORK. CONTRACTOR TO NOIFY DESIGNER OF ANY DISCREPANCIES OF SERVICE LEVELS QUOTED ON THIS PLAN. ALL SURVEY INFORMATION, BUILDING AND FINISHED SURFACE LEVELS SHOWN IN THESE DRAWINGS ARE BASED ON LEVELS OBTAINED FROM DRAWINGS BY OTHERS.
- IT IS THE RESPONSIBILITY OF THE CONTRACTOR TO OBTAIN ANY PRIOR APPROVAL REQUIRED FROM COUNCIL WITH RESPECT TO POTENTIAL
 IMPACT ON TREES FOR ANY WORKS SHOWN ON THIS DRAWING PRIOR TO THE COMMENCEMENT OF WORKS. NO TREES SHALL BE REMOVED
 WITHOUT THE WRITTEN PERMISSION OF COLINCIL.
- 7. THE CONTRACTOR SHALL TAKE ALL DUE CARE TO USE THE ABSOLUTE MINIMUM AREA FOR CONSTRUCTION AND THAT NO UNDUE DAMAGE IS
- B. THE CONTRACTOR SHALL COMPLY WITH CONDITIONS, AND SPECIFICATION OF COUNCIL AND ALL ACTS OF THE NSW EPA.
- THE CONTRACTOR SHALL TAKE ALL REASONABLE CARE TO PROTECT EXISTING SERVICES. DAMAGED SERVICES SHALL BE REPAIRED AT THE CONTRACTOR'S EXPENSE.
- 10. ALL NEW WORK IS TO MAKE A SMOOTH JUNCTION WITH EXISTING WORK
- 11. SUITABLE WARNING SIGNS AND BARRICADES ARE TO BE PROVIDED IN ACCORDANCE WITH THE AUSTRALIAN STANDARDS AND AS DIRECTED BY THE RELEVANT AUTHORITY.
- SERVICES SHOWN ARE INDICATIVE ONLY FROM AVAILABLE INFORMATION AND THE TIME OF SITE INVESTIGATION (IF ANY). THE BUILDER IS TO NOTIFY ENGINEER OF ANY DISCREPANCIES QUOTED ON THIS PLAN.
- RESTORE ALL TRAFFIC AREAS TO PRE EXISTING CONDITION. FOR ALL SURFACES OTHER THAN IN TRAFFIC AREAS RESTORE DISTURBED SURFACES TO PRE-EXISTING CONDITION AND COMPACT AS SPECIFIED.
- 14. RESTORE ALL AUTHORITY OWNED AREAS TO COUNCIL AND/OR AUTHORITY STANDARD AND SPECIFICATION
- THE WORK AS CONSTRUCTED WORKS SHALL BE INSPECTED BY THE ENGINEER, MINIMUM 48 HOURS NOTICE SHALL BE PROVIDED FOR ALL INSPECTION REQUESTS.
- 16. THE DESIGN PLANS HEREIN ARE SUBJECT TO COUNCIL APPROVAL PRIOR TO CONSTRUCTION.
- 17. WORK AS CONSTRUCTED DRAWINGS TO BE REQUESTED AND RECEIVED IN CAD/.DWG FILE TYPE AND HARD COPY 'RED LINE' MARKUP FROM CONSTRUCTOR FOR VERIFICATION AND CERTIFICATION.

ROOF STORMWATER DRAINAGE NOTES:

- ALL DOWN PIPES TO BE MINIMUM DN90 OR 100x50MM FOR GUTTERS SLOPE 1:500 AND STEEPER AS PER AS 3500.3 3.7.8
- 2. ALL ROOF GUTTERS TO HAVE OVERFLOW PROVISION IN ACCORDANCE WITH AS 3500.3 AND SECTIONS 3.5.3, 3.7.5 AND APPENDIX G OF AS 3500.3
- 3. ALL DOWNPIPES TO BE FITTED VERTICALLY TO THE SOLE OF EAVES GUTTERS, RAINHEAD AND/OR SUMP.
- ALL DOWNPIPES TO DRAIN INTO RAINWATER TANK AND OR PIT PRIOR TO DISCHARGE OFFSITE UNLESS PRIOR APPROVAL IS OBTAINED FROM COUNCIL IN WRITING OR NOTED OTHERWISE ON THIS PLAN.
- ALL FAVES GUTTERS TO BE SIZED FOR ARI 20 AS PER AS 3500.3 3.5 AND APPENDIX H.
- 6. ROOF DRAINAGE INSTALLATION TO BE IN ACCORDANCE TO AS 3500.3 SECTION 4.

STORMWATER DRAINAGE NOTES:

PIPE SIZE:

- THE MINIMUM PIPE SIZE SHALL BE:
- 1.1. DN90 FOR ALL DOWNPIPES:
- 1.2. DN100 WHERE THE LINE ONLY RECEIVES ROOF STORMWATER RUNOFF, OR;
- 1.3. DN100 WHERE THE LINE RECEIVES RUNOFF FROM PAVED OR UNPAVED AREAS

PIPE GRADE:

- THE MINIMUM PIPE GRADE SHALL BE:
- 1.1. FOR DN100 DN150 1.00%
- 1.2. FOR DN225 0.50% 1.3. FOR DN300 - 0.45%
- 1.3. FOR DN300 0.45%

STANDARD COVER

- MINIMUM PIPE COVER FOR PVC PIPES SHALL BE AS PER AS 3500.3 TABLE 6.2.5:
- 1.1. NOT SUBJECT TO VEHICULAR LOADING:
- 1.1.1. WITHOUT PAVEMENT SINGLE DWELLINGS 100mm
- 1.1.2. WITHOUT PAVEMENT OTHER THAN SINGLE DWELLINGS 300mm
- 1.1.3. WITH PAVEMENT (BRICK/PAVERS) AND/OR UNREINFORCED CONCRETE 100mm
- 1.1.3. WITH PAVEMENT (BRICK/PAVERS) AND/OR C 1.2. SUBJECT TO VEHICULAR LOADING:
- 1.2.1 ROADS (SEALED) 600mm
- 1.2.2. ROADS (UNSEALED) 750mm
- 1.2.3. OTHER THAN ROADS (WITH PAVEMENT) 100mm
- 1.2.4. OTHER THAN ROADS (WITHOUT PAVEMENT) 450mm

PIPE INSTALLATION

- 1. PIPES AND FITTINGS FOR STORMWATER DRAINAGE SHALL BE AS FOLLOWS
- 1.1. FOR PIPE SIZES UP TO DN225 PVC WITH SOLVENT WELDED JOINTS (IN GROUN
- 2. FOR PIPE SIZES GREATER THAN DN225 RCP WITH RUBBER RING JOINTS.
- 1.3. FOR LARGER PIPE DEPTHS AS SPECIFIED IN AS 3500.3 RCP WITH RUBBER RING JOINTS.
- FOR PIPES AND FITTINGS FOR SUBSOIL DRAINAGE SHALL BE SLOTTED PVS WITH SOLVENT WELDED JOINTS MINIMUM DN150.
 FOR GRATED DRAINS SHALL BE MINIMUM DN150 IN NON-TRAFFICABLE ZONES AND DN225 IN TRAFFICABLE ZONES.
- 3. LAY AND JOINT ALL PIPES IN ACCORDANCE WITH THE MANUFACTURING RECOMMENDATIONS AND
- 3.1. AS 3725-1989 LOADS ON BURIED CONCRETE PIPES
- 3.2. AS 2566 1988 BURIED FLEXIBLE PIPELINES
- 3.3. AS 1597.2 1996 PRECAST REINFORCED CONCRETE BOX CULVERTS
- 3.4. AS 3500 1990 NATIONAL PLUMBING AND DRAINAGE CODE PART 2 SANITARY PLUMBING AND SANITARY DRAINAGE SYDNEY WATER REQUIREMENTS.
- 4. ALLOW TO TEST ALL PIPES AND PITS TO MANUFACTURERS REQUIREMENTS

CONNECTIONS TO STORMWATER SYSTEMS UNDER BUILDINGS

IN ACCORDANCE WITH AS 3500.3 SECTION 9.

CONNECTIONS TO COUNCIL STORMWATER SYSTEMS:

CONNECTION TO COUNCIL STORMWATER SYSTEM TO BE IN ACCORDANCE TO LOCAL COUNCIL DCP AND STANDARDS. NO CONNECTIONS TO BE MADE UNTIL PROPER PERMIT/APPROVALS ARE OBTAINED FROM LOCAL COUNCIL IN WRITING.

WARNIN

EXISTING SERVICES SHOWN ON THESE PLANS ARE NOT GUARANTEED COMPLETE OR CORRECT AND FURTHER INFORMATION IS REQUIRED FROM THE RELEVANT AUTHORITY AND FIELD INVESTIGATION AND ARE TO BE VERIFIED BY THE CONTRACTOR PRIOR TO CONSTRUCTION.

29.09.2021

22.06.2022

30.08.2022

<u>LEGEND</u>

SURFACE INLET PIT		GRATED TRENCH DRAIN	
SURFACE INLET PIT (WITH ENVIROPED 200 MICRON)		ABSORPTION TRENCH	
ACCESS GRATE		PROPOSED ROOF GUTTER FALL	 ►
(WITH GROSS POLLUTANT TRAP)	00	PROPOSED DOWNPIPE SPREADER	⊢ (\$P)
450 SQUARE INTERVAL	450 X 450	STORMWATER PIPE 100mm DIA. MIN. UNO	
GRATE LEVEL = 75.50	SL 75.50	SUBSOIL PIPE	
INVERT LEVEL = RL 75.20	IL 75.20	EXISTING STORMWATER PIPE	
PROPOSED DOWNPIPE 90mm DIA. OR 100mm x 50mm MIN.	DP 90	INSPECTION RISER	• IR
NATURAL GROUND FINISHED DESIGN LEVEL	× [10.00]	RAINWATER HEAD	RWH

STORMWATER PIT/STRUCTURES NOTES:

PIT SIZES AND DEPTHS:

1. PIT SIZES WILL BE AS FOLLOWS:

DEPTH (mm)	MIN. PIT SIZE (mm)
UP TO 450	350x350
450 - 600	450x450
600 - 900	600x600
900 - 1200	600x900
1200+	900x900 (WITH STEP IRONS)

T DESIGNS:

- TRENCH DRAINS: CONTINUOUS TRENCH DRAINS ARE TO BE MIN. DN150 AND MIN. 100mm DEPTH. THE BARS OF THE GRATE ARE TO BE PARALLEL
 TO THE DIRECTION OF SURFACE FLOW.
- STEP IRONS: PITS BETWEEN 1.2m AND 6m ARE TO HAVE STEP IRONS IN ACCORDANCE WITH AS 1657. FOR PITS GREATER THAN 6m OTHER MEANS
 OF ACCESS MUST BE PROVIDED.
- 3. PLASTIC/PVC PITS: PVC PITS WILL ONLY BE PERMITTED IF THEY ARE MAX. 450x450 AND MAX. 450mm DEPTH AS WELL AS BEING HEAVY DUTY.
- 4. <u>IN-SITU PITS:</u> IN-SITU PITS ARE TO BE CONSTRUCTED ON A CONCRETE BED OF AT LEAST 150mm THICK. THE WALLS ARE TO BE DESIGNED TO MEET THE MINIMUM REQUIREMENTS OF CLAUSE 4.6.3 OF AS 3500.4. PITS DEEPER THAN 1.8m SHALL BE CONSTRUCTED WITH REINFORCED CONCRETE.
- GRATES: GRATES ARE TO BE GALVANIZED STEEL GRID TYPE. GRATES ARE TO BE OF HEAVY-DUTY TYPE IN AREAS WHERE THEY MAY BE SUBJECT TO VEHICLE LOADING.

INSTALLATION NOT

- 1. ALL PIPES INTO PITS TO BE CUT FLUSH WITH PIT WALL
- ALL PITS THAT ARE INSTALLED AT GREATER THAN 600mm DEEP TO BE MIN. 600x600 PIT.
- GRATED COVERS ON PITS GREATER THAN 600mm TO BE HINGE
- BASE OF PIT TO BE SAME LEVEL OF INVERT OF OUTLET
- 5. OUTLET PIPE FROM ANY PIT TO BE 20mm LOWER THAN INLET PIPE/



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UPDATED BASEMENT DRAINAGE

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DETAILS, NOTES & LEGEND

PROJECT TITLE

PROPOSED DUAL OCCUPANCY No.12 CLERMONT AVENUE RYDE SHEET SIZE A3 JOB REFERENCE
E210095

DESIGNED NZ


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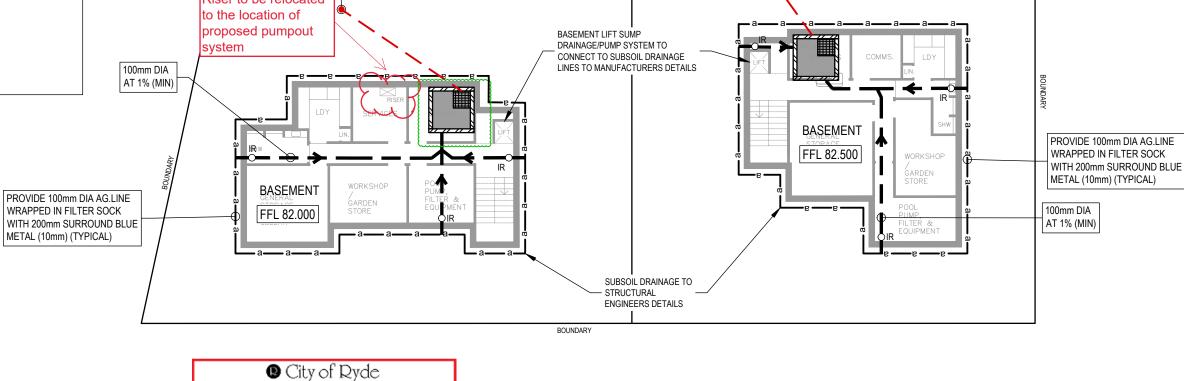
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Approved Plans LDA No. LDA2021/0363 MOD No. MOD2022/0128 Date: 29 September 2022 Council Officer: Holly Charalambous Subject to conditions of consent



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Development Engineering Service Approved Engineering Plans Application Number: MOD2022/0128

Council Officer: Emily Lu


Date: 09/09/2022

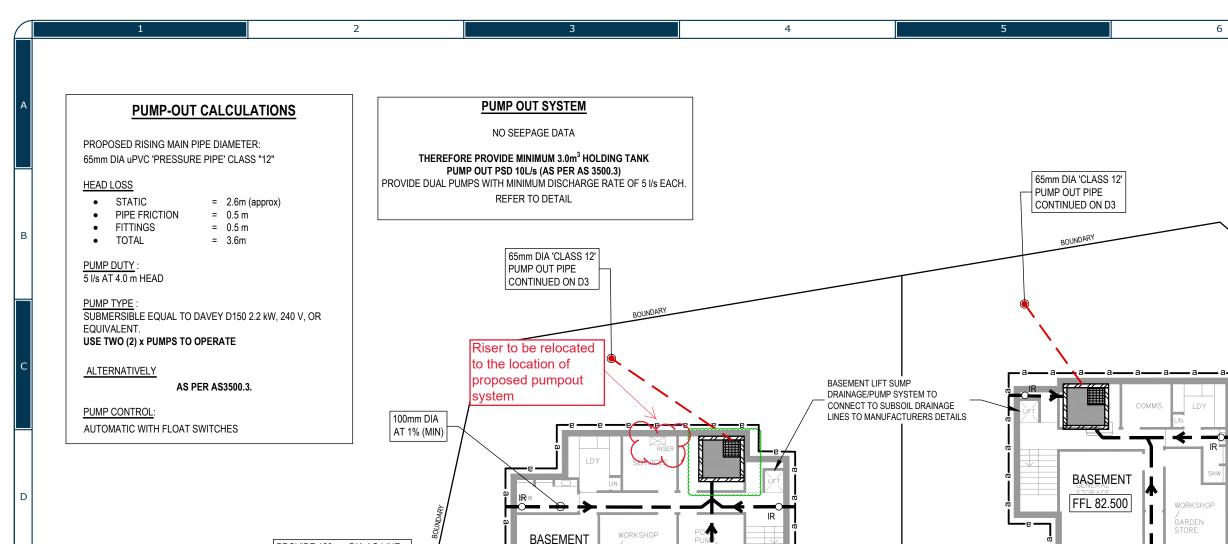
DRAWING TITLE									
STORMWATER MANAGEMENT									
BASEMENT PLAN									

PROJECT TITLE
PROPOSED DUAL OCCUPANCY
No.12 CLERMONT AVENUE
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SHEET SIZE	А3	JOB REFERENCE E210095
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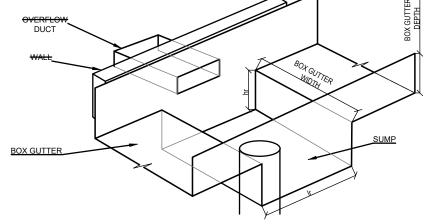
Liquid-applied Bond breaker bridging the transition between outlet (MINIMUM) Finished floor level (External) NOTES: 1.Sub-sill is installed before door. 2.Seal between sill, packer and membrane before drilling fixing holes. NOTE: For falls, see Clause 2.5.2. (a) Overflow through parapet BACLONY MENBRANE TERMINATION - AS4654.2 **BALCONY PARAPET OVERFLOW - AS4654.2** NTS

DIMENSIONS (mm) CATCHMENT AREA TO DOWNPIPE 50m² WIDTH OF BOX GUTTER 300 DEPTH OF BOX GUTTER 1:200 SLOPE OF BOX GUTTER 300 SUMP WIDTH SUMP LENGTH (Ir) 400 SUMP DEPTH (hr 75 200 OVERFLOW WIDTH OVERFLOW DEPTH 67 ROOF DRAINAGE DESIGNED FOR 100 YEAR ARI STORN EVENT (I = 237 mm/hr)

DOWNPIPE TO RWT

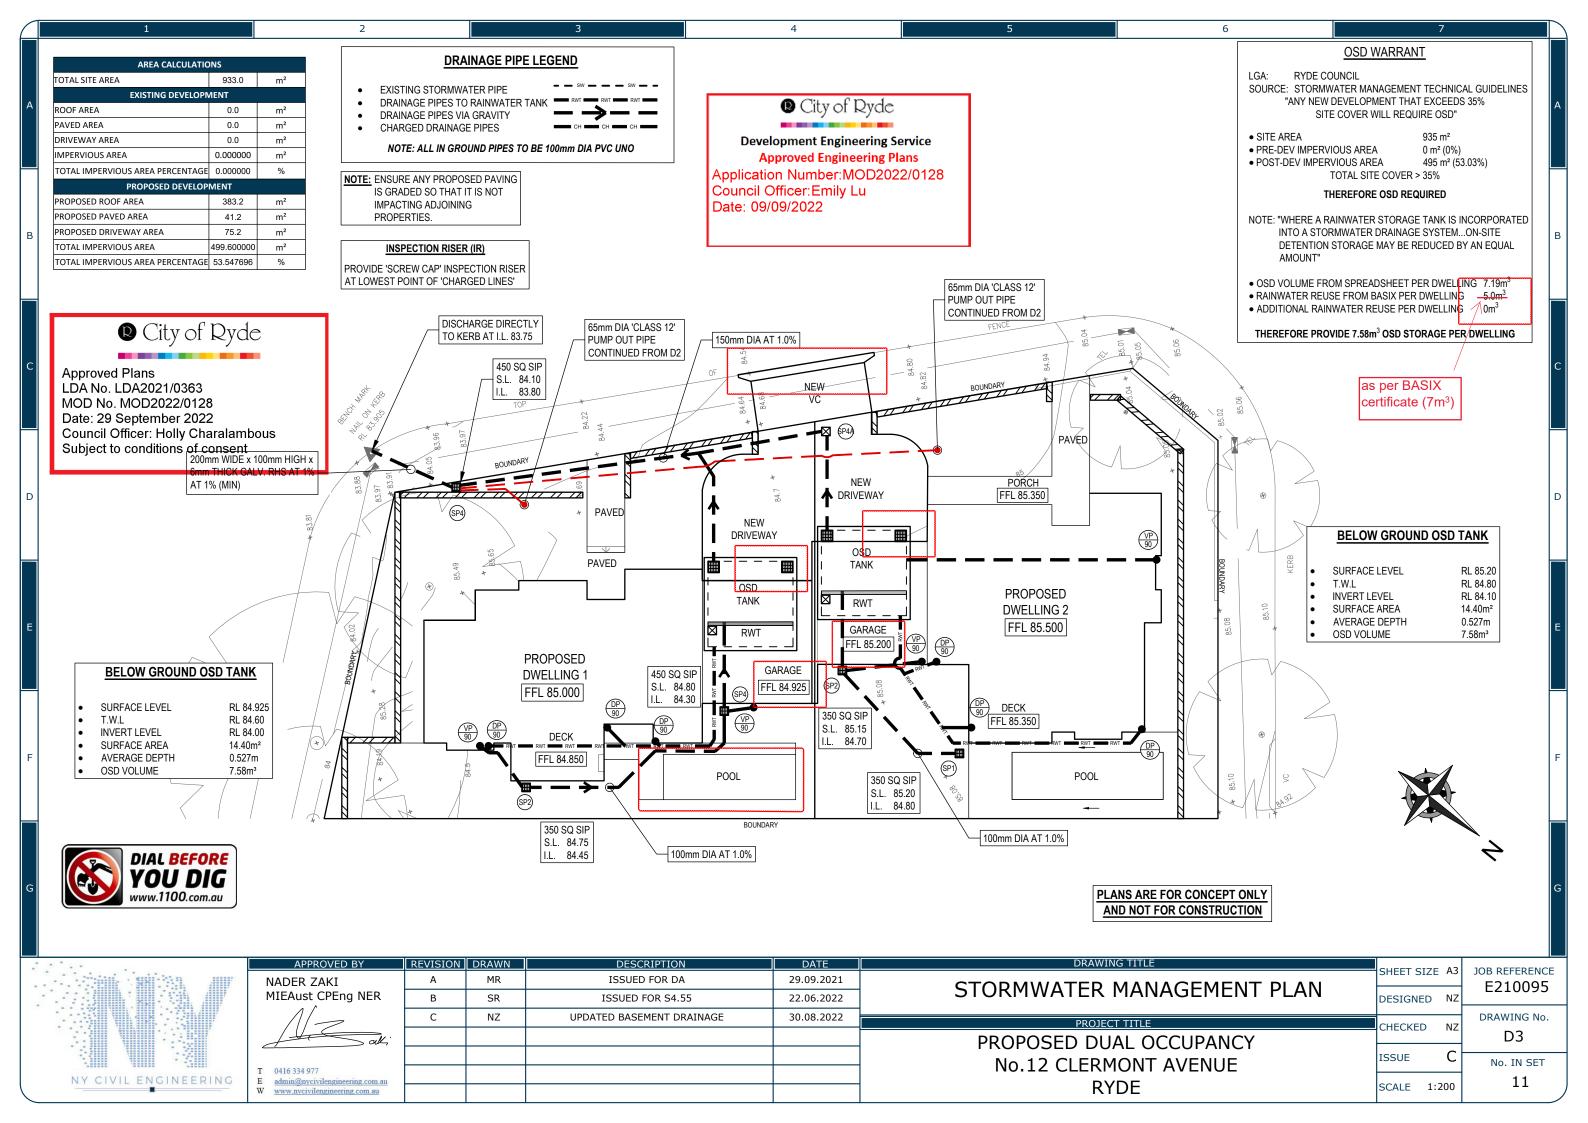VERTICAL PIPE NOT TO RWT

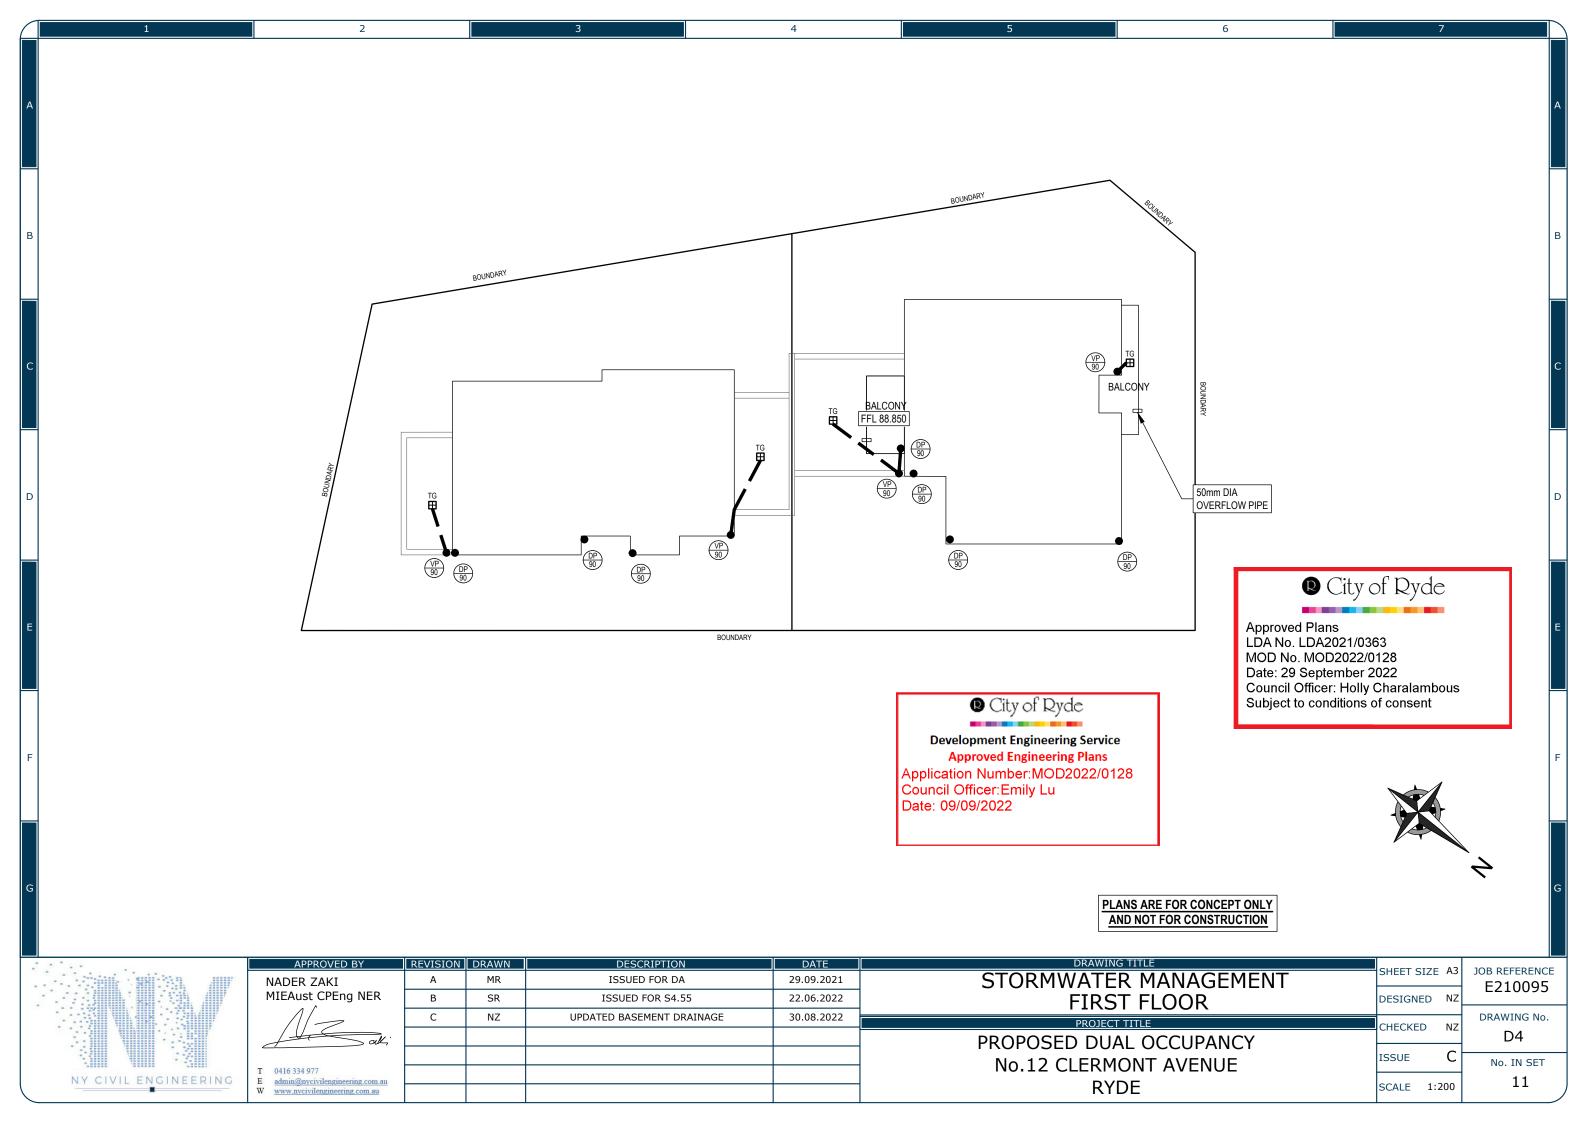HIGH POINT OF GUTTER



SUMP DETAIL

ROOF DRAINAGE

BOX GUTTER 121 DEEP x 300 WIDE GUTTERING

• DOWN PIPES - 90mm DIA PVC OR COLORBOND


NOTE: ROOF DESIGNED TO 1% AEP INTENSITY 237 mm/hr

AS350	0.3:2021 BOX G	SUTTER REQUI	REMENTS			
MATERIALS	BASE METAL	MAXIMUM LEN EXPANSION	MINIMUM EXPANSION			
	THICKNESS (mm)	ONE END FIXED AND ONE END FREE TO MOVE	BOTH ENDS FREE TO MOVE	SPACE (mm)		
ALUMINIUM	0.90	12	24	50		
ALUMINIUM	1.00	12	24	30		
	0.60	9	18			
COPPER	0.80	15	30	50		
	1.00	26	52			
STEEL	0.55	20	40	50		
SIEEL	0.75	25	50	50		
STAINLESS STEEL	0.55	20	40	50		
PVC		10	20	30		
ZINC	0.80	10	20	50		

<u>LAP JOINTS:</u> FOR METAL GUTTERS WITH LAPS BETWEEN 20 mm TO 25 mm THE LAP SHALL BE FULLY SEALED. WIDER LAPS SHALL BE SEALED AND FASTENED AT EACH END OF THE LAP RATHER THAN FILLING THE TOTAL AREA.

GRADIENTS: GRADIENTS SHALL BE NOT FLATTER THAN 1:200 FOR SOLE WIDTHS EQUAL TO OR LESS THAN 600 mm WIDE. DEVIATIONS FROM THESE GRADIENTS SHALL BE SMOOTH AND NOT CAUSE PERMANENT PONDING.

OUTLETS: OUTLETS SHALL DISCHARGE THROUGH EITHER A RAINHEAD OR A SUMP.

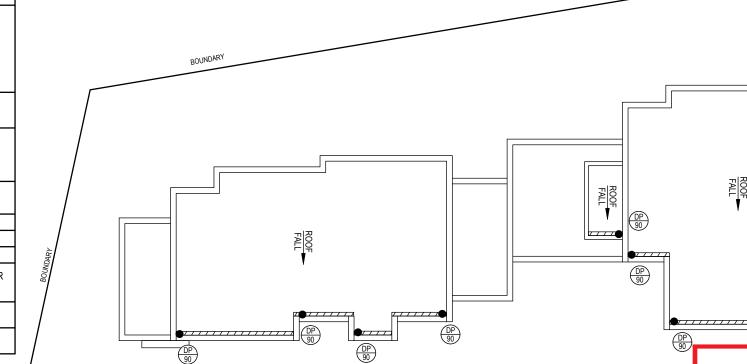

LEGEND:

DP

VP



City of Ryde

Development Engineering Service Approved Engineering Plans pplication Number:MOD2022/0128

Council Officer:Emily Lu Date: 09/09/2022

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STORMWATER MANAGEMENT **ROOF PLAN**

PLANS ARE FOR CONCEPT ONL

AND NOT FOR CONSTRUCTION

BOUNDARY

PROPOSED DUAL OCCUPANCY No.12 CLERMONT AVENUE RYDE

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City of Ryde

Approved Plans

LDA No. LDA2021/0363

MOD No. MOD2022/0128

Date: 29 September 2022

Council Officer: Holly Charalambous Subject to conditions of consent


NY CIVIL ENGINEERING




TYPICAL WARNING SIGN

NTS

EVERY EXTERNAL SUPPLY OUTLET FROM RAINWATER RE-USE TANK TO BE LABELED WITH METALLIC WARNING SIGN

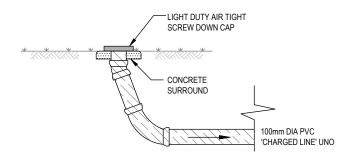

INSPECTION RISER - IR

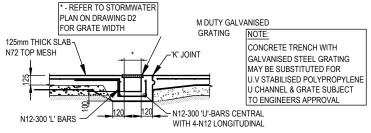


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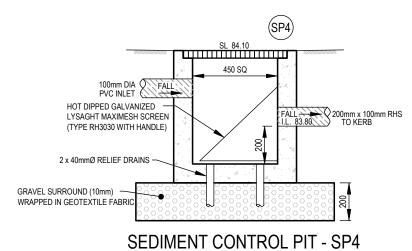
Approved Plans
LDA No. LDA2021/0363
MOD No. MOD2022/0128
Date: 29 September 2022
Council Officer: Holly Char

Council Officer: Holly Charalambous Subject to conditions of consent



TYPICAL PIT (SIP)

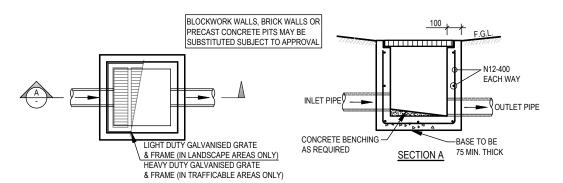NOTE:
ALL PROPOSED SITE PITS ARE TO BE
CONSTRUCTED IN CONCRETE CAST IN SITU,
PLASTIC OR BRICK PITS ARE NOT ACCEPTABLE.
HOWEVER, 'COUNCIL MAY CONSIDER PRE-CAST
UNITS IF THE UNITS ARE PLACED ON A SOLID
BASE OF GRAVEL OR CONCRETE OF 75mm
THICK AND BACKFILL UP TO HALF THE DEPTH
OF THE PIT SURROUND WITH CONCRETE.



1:20

City of Ryde

Development Engineering Service
Approved Engineering Plans

11

SCALE AS NOTED

Application Number:MOD2022/0128
Council Officer:Emily Lu


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0416 334 977 admin@nycivilengineering.com.au www.nycivilengineering.com.au					

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STORMWATER DETAILS	DESIGNED	NZ	E210095
			DRAWING No.
PROJECT TITLE	CHECKED	NZ	
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No.12 CLERMONT AVENUE	15502	\sim $ $	No. IN SET

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PUMP HOLDING TANK (TYPICAL)

NTS

STANDARD PUMP OUT DESIGN NOTES:

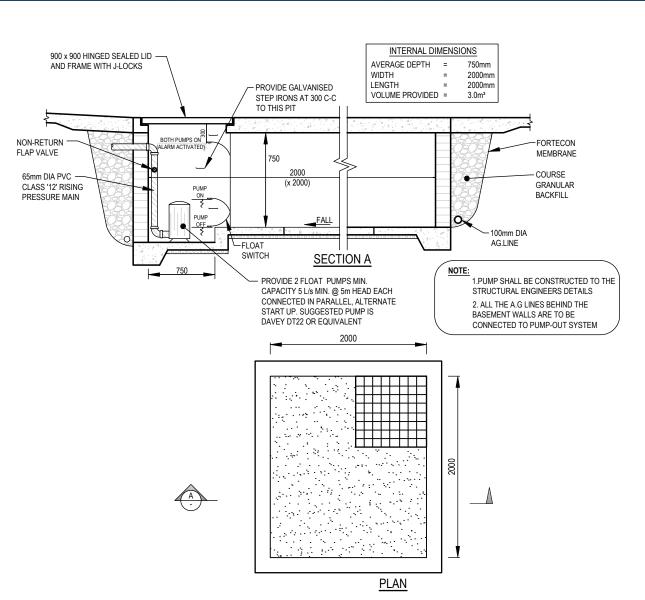THE PUMP OUT SYSTEM SHALL BE DESIGNED TO OPERATE IN THE FOLLOWING MANNER-


- THE PUMPS SHALL BE PROGRAMMED TO WORK ALTERNATELY SO AS TO ALLOW BOTH PUMPS TO HAVE AN EQUAL OPERATION LOAD AND PUMP LIFE.
- A LOW LEVEL FLOAT SHALL BE PROVIDED TO ENSURE THAT THE MINIMUM REQUIRED WATER LEVEL IS MAINTAINED WITHIN THE SUMP AREA OF THE BELOW GROUND TANK. IN THIS REGARD THE FLOAT WILL FUNCTION AS AN OFF SWITCH FOR THE PUMPS.
- A SECOND FLOAT HALL BE PROVIDED AT A HIGHER LEVEL, APPROXIMATELY 300mm ABOVE THE MINIMUM WATER LEVEL, WHEREBY ONE OF THE PUMPS WILL OPERATE AND DRAIN THE TANK TO THE LEVEL OF THE LOW-LEVEL FLOAT.
- A THIRD FLOAT SHALL BE PROVIDED AT A HIGH LEVEL, WHICH IS APPROXIMATELY THE ROOF LEVEL OF THE BELOW GROUND TANK. THIS FLOAT SHOULD START THE OTHER PUMP THAT IS NOT OPERATING AND ACTIVATE THE ALARM.
- AN ALARM SYSTEM SHALL BE PROVIDED WITH A FLASHING STROBE LIGHT AND A PUMP FAILURE WARNING SIGN WHICH ARE TO BE LOCATED AT THE DRIVEWAY ENTRANCE TO THE BASEMENT LEVEL. THE ALARM SYSTEM SHALL BE PROVIDED WITH A BATTERY BACK-UP IN CASE OF POWER FAILURE



Development Engineering Service

Approved Engineering Plans
Application Number: MOD2022/0128

Council Officer:Emily Lu Date: 09/09/2022

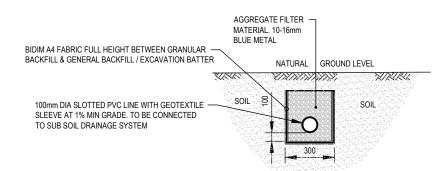




Approved Plans LDA No. LDA2021/0363 MOD No. MOD2022/0128 Date: 29 September 2022


Council Officer: Holly Charalambous Subject to conditions of consent


SUB-SOIL DRAINAGE (AG.LNE)


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	APPROVED BY	REVISION	DRAWN	DESCRIPTION	DATE	DRAWING TITLE	SHEET SIZE A3	JOB REFERENCE
	NADER ZAKI	Α	MR	ISSUED FOR DA	29.09.2021	CTODMINIATED DETAILS	SHEET SIZE AS	E210095
	MIEAust CPEng NER	В	SR	ISSUED FOR S4.55	22.06.2022	STORMWATER DETAILS	DESIGNED NZ	L210033
	Λ	С	N7	UPDATED BASEMENT DRAINAGE	30.08.2022		_	DRAWING No.
			112	0.5/1125 5/1021 12111 5/10/210/102	30.00.2022	PROJECT TITLE	CHECKED NZ	
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	T 0416 334 977					No.12 CLERMONT AVENUE		No. IN SET
NY CIVIL ENGINEERING	E admin@nycivilengineering.com.au					RYDE	SCALE AS NOTED	11
	W www.nycivilengineering.com.au					KIDL	JOCALL AS NOTED	



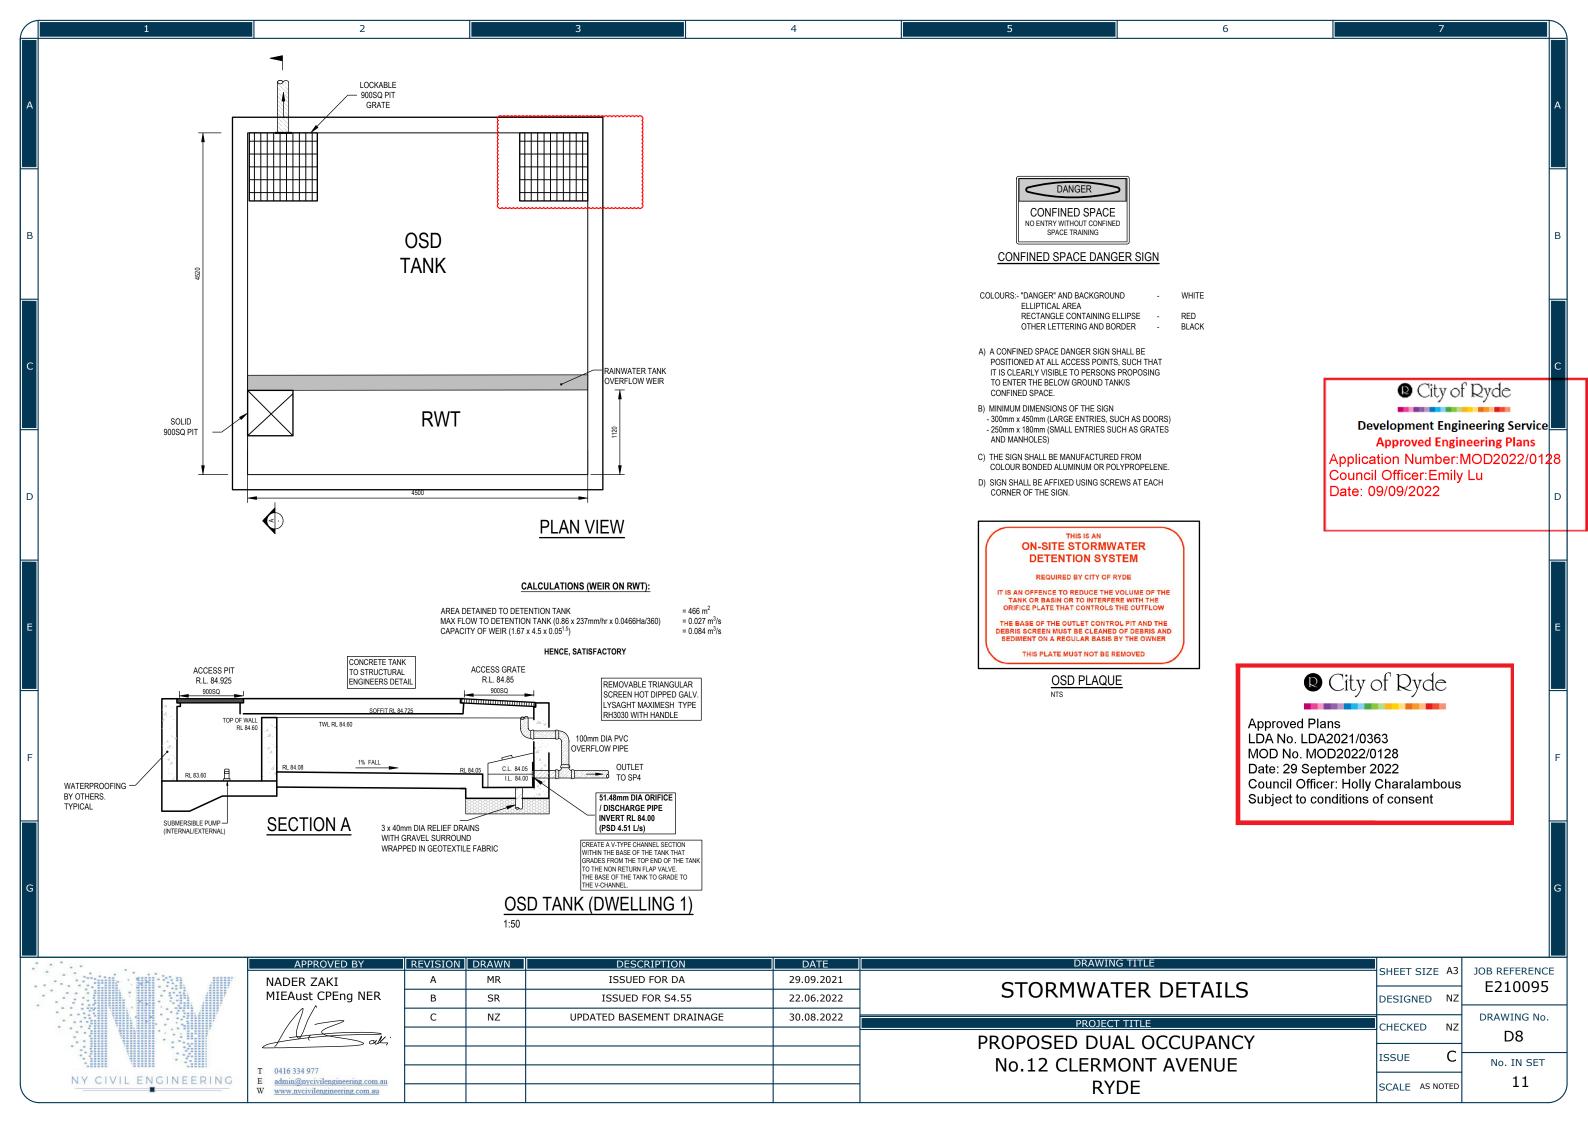

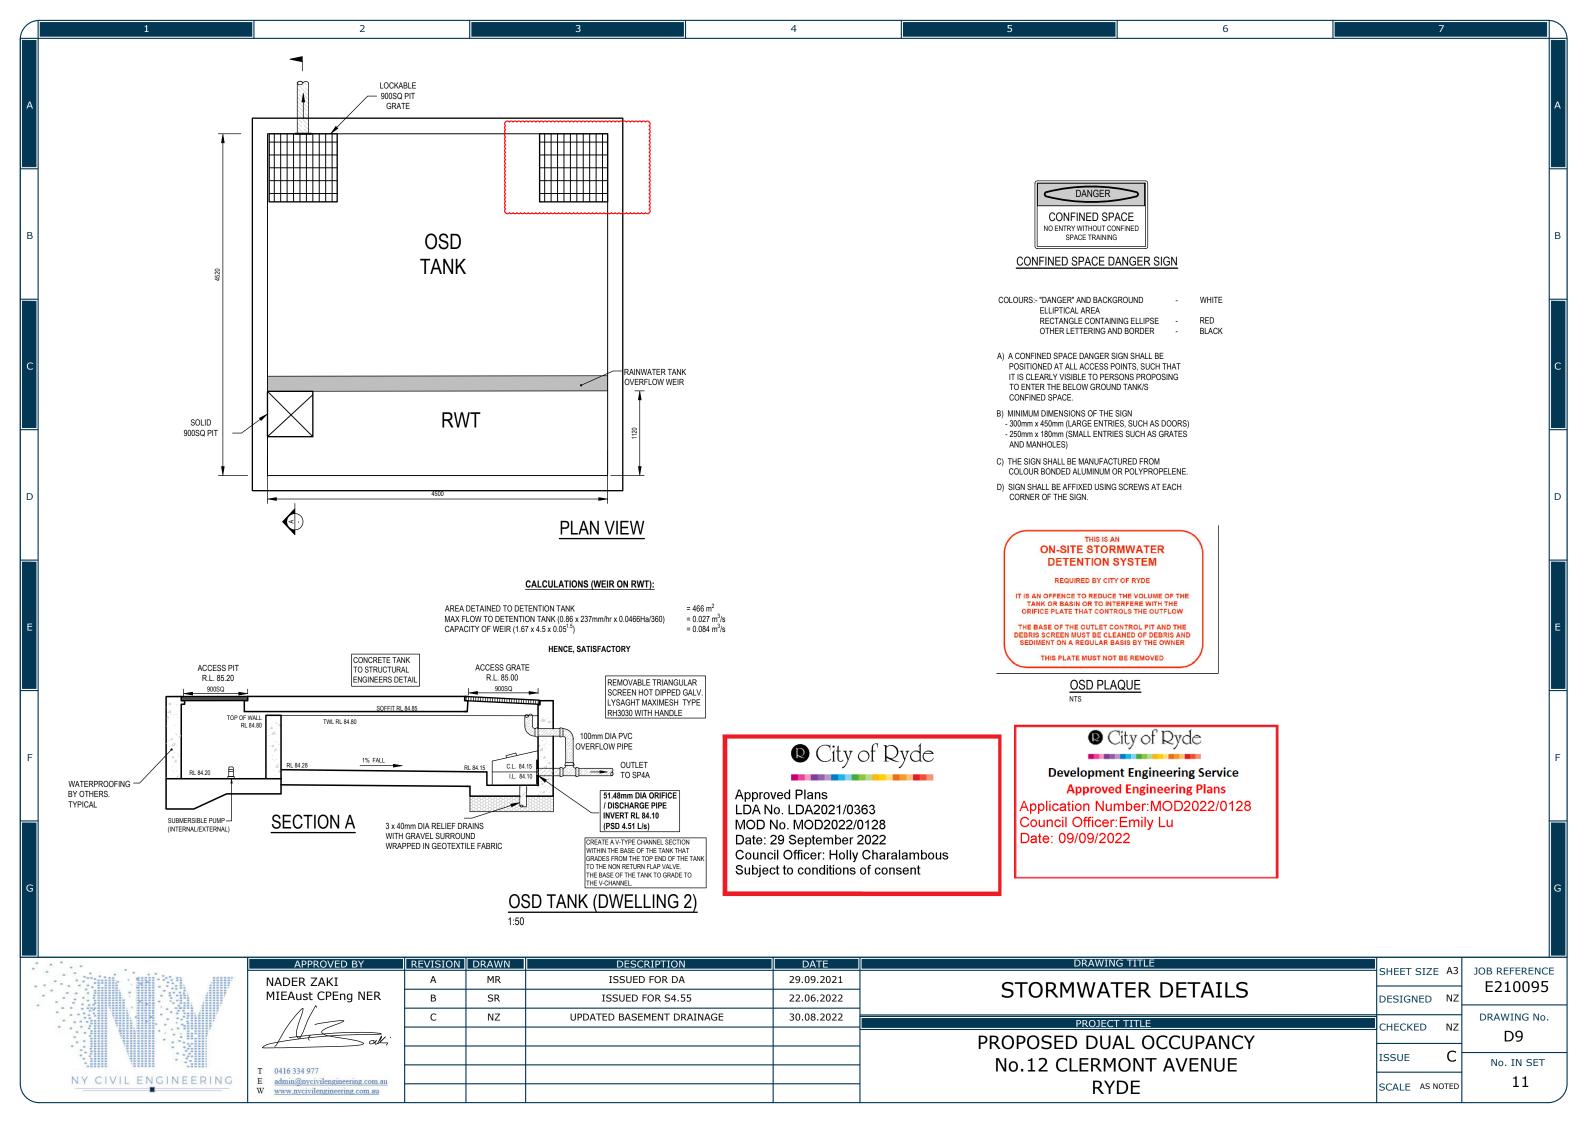

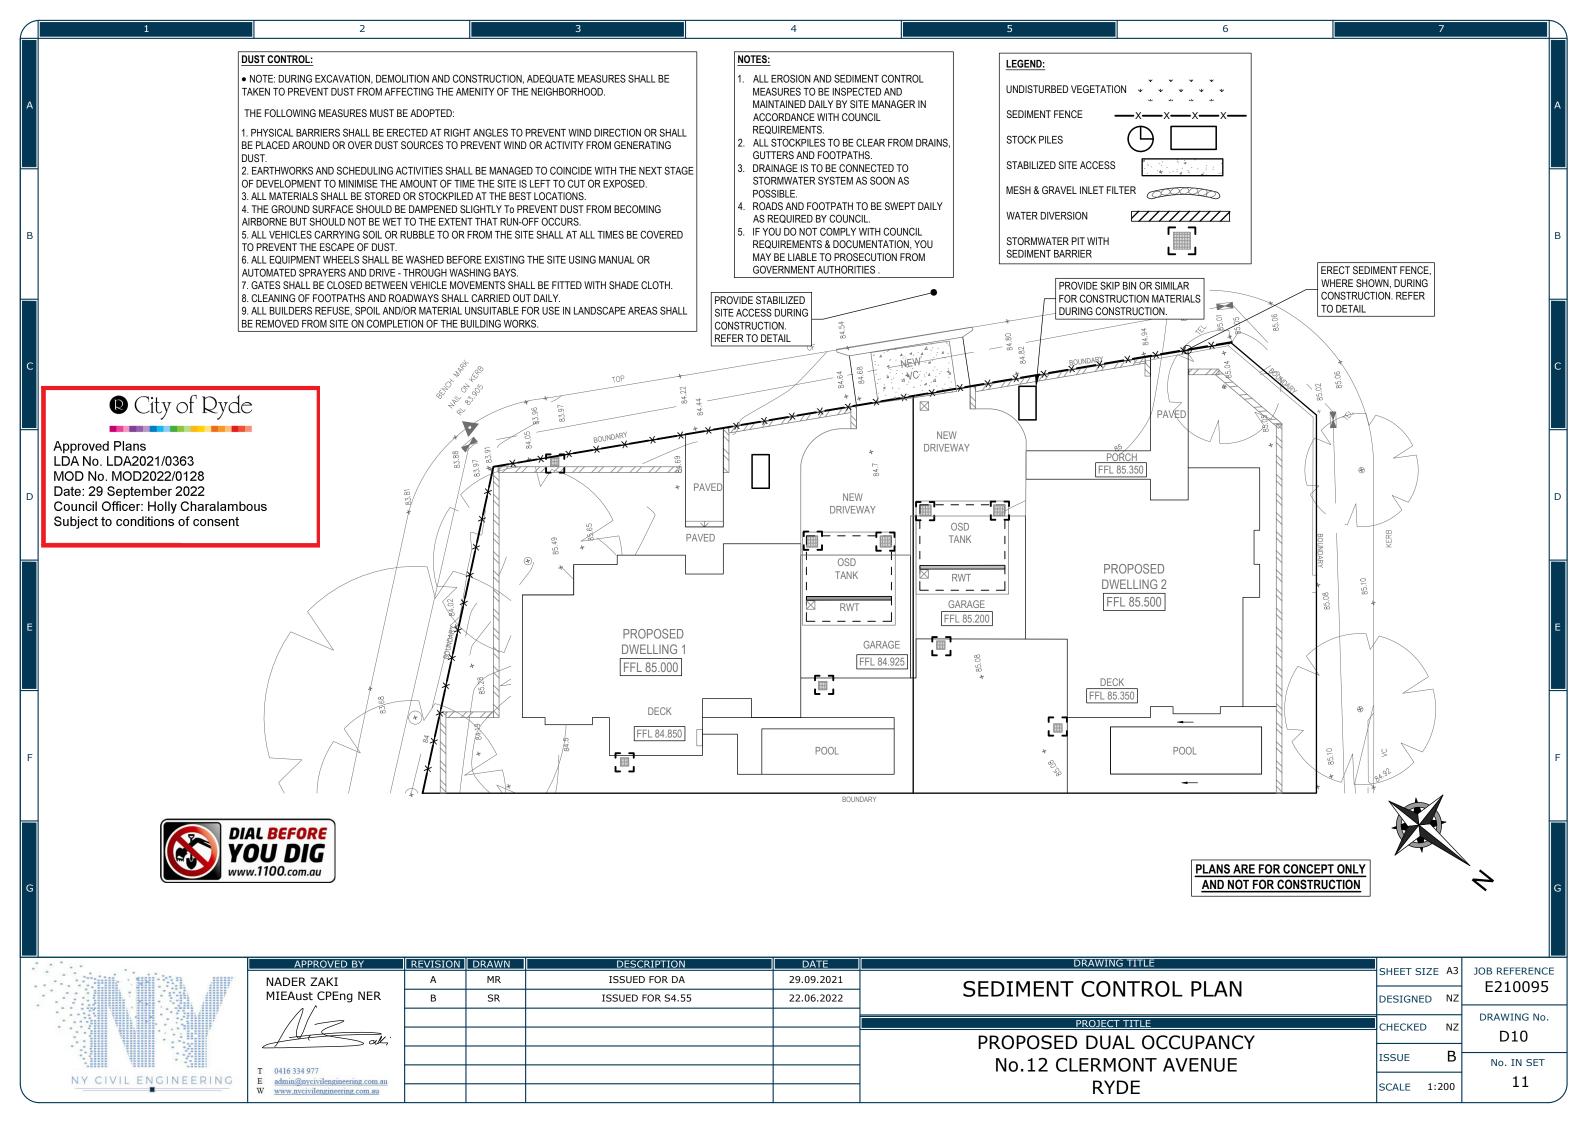

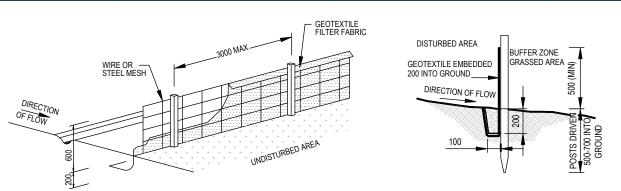SEDIMENT FENCE DETAIL

CONSTRUCTION NOTES:


- CONSTRUCT SEDIMENT FENCES AS CLOSE AS POSSIBLE TO BEING PARALLEL TO THE CONTOURS OF THE SITE, BUT WITH SMALL RETURNS AS SHOWN IN THE DRAWING TO LIMIT THE CATCHMENTS AREA OF ANY ONE SECTION. THE CATCHMENTS AREA SHOULD BE SMALL ENOUGH TO LIMIT WATER FLOW IF CONCENTRATED AT ONE POINT TO 50 LITRES PER SECOND IN THE DESIGN STORM EVENT, USUALLY THE 10 YEAR EVENT
- CUT A 150mm DEEP TRENCH ALONG THE UPSLOPE LINE OF THE FENCE FOR THE BOTTOM OF THE FABRIC TO BE ENTRENCHED.
- DRIVE 1.5m LONG STAR PICKETS INTO GROUND AT 2.5m INTERVALS (MAX) AT THE DOWNSLOPE EDGE OF THE TRENCH. ENSURE ANY STAR PICKETS ARE FITTED WITH SAFETY CAPS.
 FIX SELF-SUPPORTING GEOTEXTILE TO THE UPSLOPE SIDE OF THE POSTS
- ENSURING IT GOES TO THE BASE OF THE TRENCH. FIX THE GEOTEXTILE WITH WIRE TIES OR AS RECOMMENDED BY THE MANUFACTURER. ONLY USE GEOTEXTILE SPECIFICALLY PRODUCED FOR SEDIMENT FENCING. THE USE OF SHADE CLOTH FOR THIS PURPOSE IS NOT SATISFACTORY.
- JOIN SECTIONS OF FABRIC AT A SUPPORT POST WITH 150mm OVERLAP.
- BACKFILL THE TRENCH OVER THE BASE OF THE FABRIC AND COMPACT IT THOROUGHLY OVER THE GEOTEXTILE.



Approved Plans


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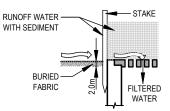


MESH AND GRAVEL FILTER

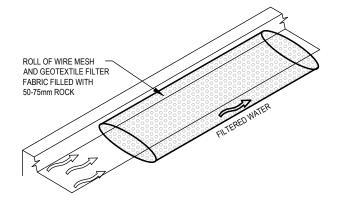- INSTALL FILTERS TO KERB INLETS ONLY AT SAG POINTS
- FABRICATE A SLEEVE MADE FROM GEOTEXTILE OR WIRE MESH LONGER THAN THE LENGTH OF THE INLET PIT AND FILL IT WITH 25mm TO 50mm GRAVEL.
- FORM AN ELLIPTICAL CROSS-SECTION ABOUT 150mm(h) x 400mm(w).
- PLACE THE FILTER AT THE OPENING LEAVING AT LEAST 100mm SPACE BETWEEN IT AND THE KERB INLET. MAINTAIN THE OPENING WITH SPACER BLOCKS.
- FORM A SEAL WITH THE KERB TO PREVENT SEDIMENT BYPASSING THE FILTER.
- SANDBAGS FILLED WITH GRAVEL CAN SUBSTITUTE FOR THE MESH OR GEOTEXTILE PROVIDING THEY ARE PLACED SO THAT THEY FIRMLY ABUT EACH OTHER AND SEDIMENT-LADEN WATERS CANNOT PASS BETWEEN.




- PLACE STOCKPILES MORE THAN 2 (PREFERABLY 5) METERS FROM EXISTING VEGETATION, CONCENTRATED WATER FLOW, ROADS AND HAZARD AREAS.
- CONSTRUCT ON THE CONTOUR AS LOW, FLAT, ELONGATED MOUNDS.
- WHERE THERE IS SUFFICIENT AREA, TOPSOIL STOCKPILES SHALL BE LESS THAN 2 METERS IN HEIGHT
- WHERE THEY ARE TO BE IN PLACE FOR MORE THAN 10 DAYS, STABILIZE FOLLOWING
- THE APPROVED ESCP OR SWMP TO REDUCE THE C-FACTOR TO LESS THAN 0.10. CONSTRUCT EARTH BANKS (LOW FLOW) ON THE UPSLOPE SIDE TO DIVERT WATER AROUND STOCKPILES AND SEDIMENT FENCES 1 TO 2 METERS ON THE DOWNSLOPE

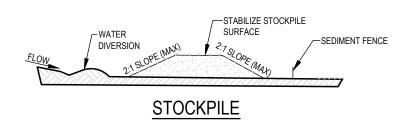

SEDIMENT BARRIER AROUND PIT

- FABRICATE A SEDIMENT BARRIER MADE FROM GEOTEXTILE OR
- FOLLOW STRAW FILTER AND SEDIMENT FENCE FOR INSTALLATION PROCEDURES FOR THE STRAW BALES OR GEOFABRIC. REDUCE THE PICKET SPACING TO 1 METRE CENTRES.
- IN WATERWAYS, ARTIFICIAL SAG POINTS CAN BE CREATED WITH SANDBAGS OR EARTH BANKS AS SHOWN IN THE DRAWING
- DO NOT COVER THE INLET WITH GEOTEXTILE UNLESS THE DESIGN IS ADEQUATE TO ALLOW FOR ALL WATERS TO BYPASS IT

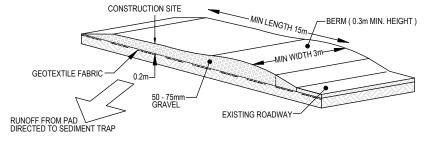

STABILIZED SITE ACCESS

CONSTRUCTION NOTES:

- STRIP THE TOPSOIL, LEVEL THE SITE AND COMPACT THE SUBGRADE
- COVER THE AREA WITH NEEDLE-PUNCHED GEOTEXTILE
- CONSTRUCT A 200mm THICK PAD OVER THE GEOTEXTILE USING ROAD BASED OR 30mm AGGREGATE
- ENSURE THE STRUCTURE IS AT LEAST 15m LONG OR TO BUILD ALIGNMENT AND AT LEAST 3 METERS WIDE
- WHERE A SEDIMENT FENCE JOINS ONTO THE STABILIZED ACCESS, CONSTRUCT A HUMP IN THE STABILIZED ACCESS TO DIVERT WATER TO THE SEDIMENT FENCE.

NY CIVIL ENGINEERING

29.09.2021 ISSUED FOR DA NADER ZAKI MIEAust CPEng NER SR ISSUED FOR S4.55 22.06.2022

SEDIMENT CONTROL DETAILS

PROPOSED DUAL OCCUPANCY No.12 CLERMONT AVENUE RYDE

SHEET SIZE A3 JOB REFERENCE E210095 DESIGNED NZ

DRAWING No. CHECKED ΝZ

ISSUE

В SCALE AS NOTED

No. IN SET 11

D11