

NOTES

1. ALL DIMENSIONS AND FLOOR AREAS TO BE VERIFIED
BUILDER PRIOR TO THE COMMENCEMENT OF ANY
BUILDING WORK.

ANY DISCREPANCIES ARE TO BE CONFIRMED BY THE

TO THE COMMENCEMENT OF ANY BUILDING WORK.

5. WHERE ENGINEERING OR HYDRAULIC DRAWINGS
ARE REQUIRED, SUCH MUST TAKE PREFERENCE TO
THIS DRAWING.

C TORMWATER TO BE CONNECTED AND

ANY DISCREPANCIES ARE TO BE COLL...

DESIGNER.


2. LEVELS SHOWN ARE APPROXIMATE UNLESS
ACCOMPANIED BY REDUCED LEVELS BY A REGISTERED TO AS 3500.3.1990

SURVEYOR.

7. ALL SERVICES TO BE LOCATED AND VERIFIED BY THE BUILDER WITH THE RELEVANT AUTHORITIES PRIOR TO THE COMMENCEMENT OF ANY BUILDING WORK

				PROJECT	PROPOSED TWO STOREY DWELLING 180 North Road EASTWOOD 2122 LOT 3 DP387071
				CLIENT	Mr. GEORGE ELIAS
В	KN	GENERAL REVISION	13.12.2022		
Α	LT	ISSUED FOR DA APPROVAL	03.11.2022	TITLE	STREETSCAPE
REV	BY	AMENDMENT	DATE		

DESIGNS ABN 60 167 981 982 G01/ 2A COOKS AVENUE CANTERBURY, NSW 2193 PHONE: (02)97871595 FAX:97871095

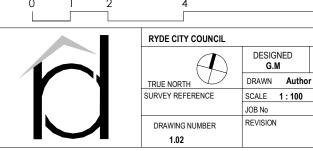



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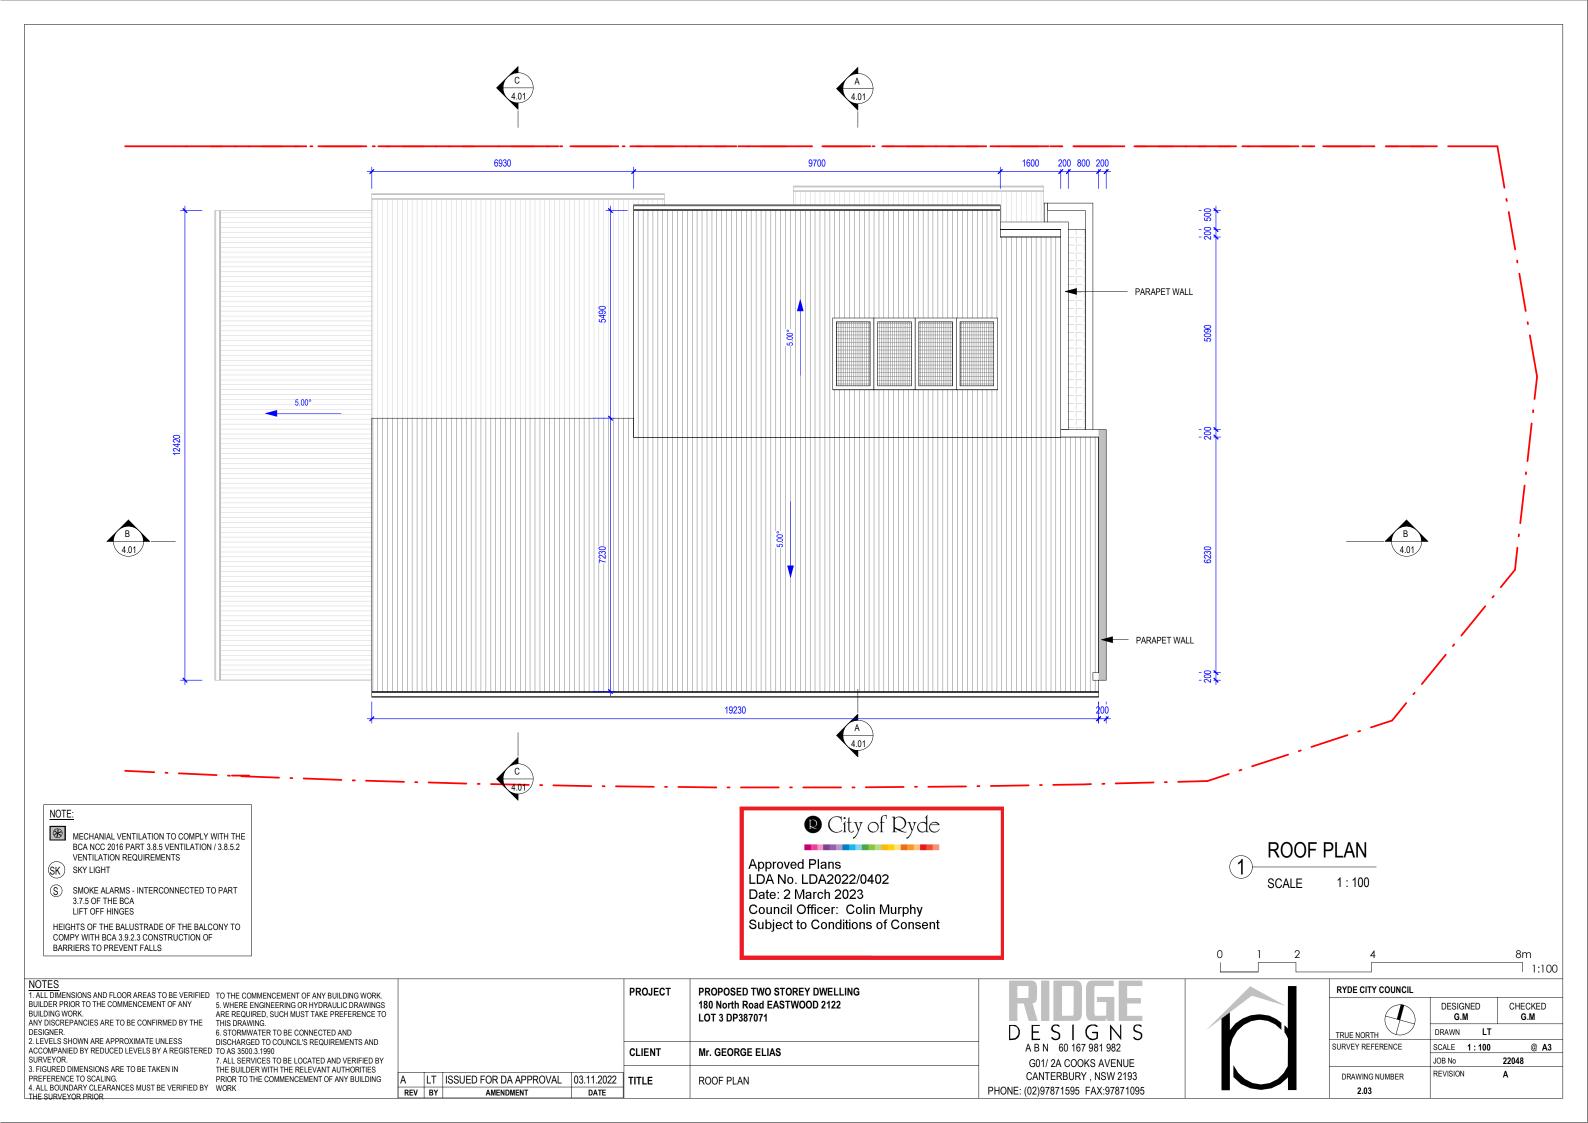
CHECKED G.M


22048


@ A3




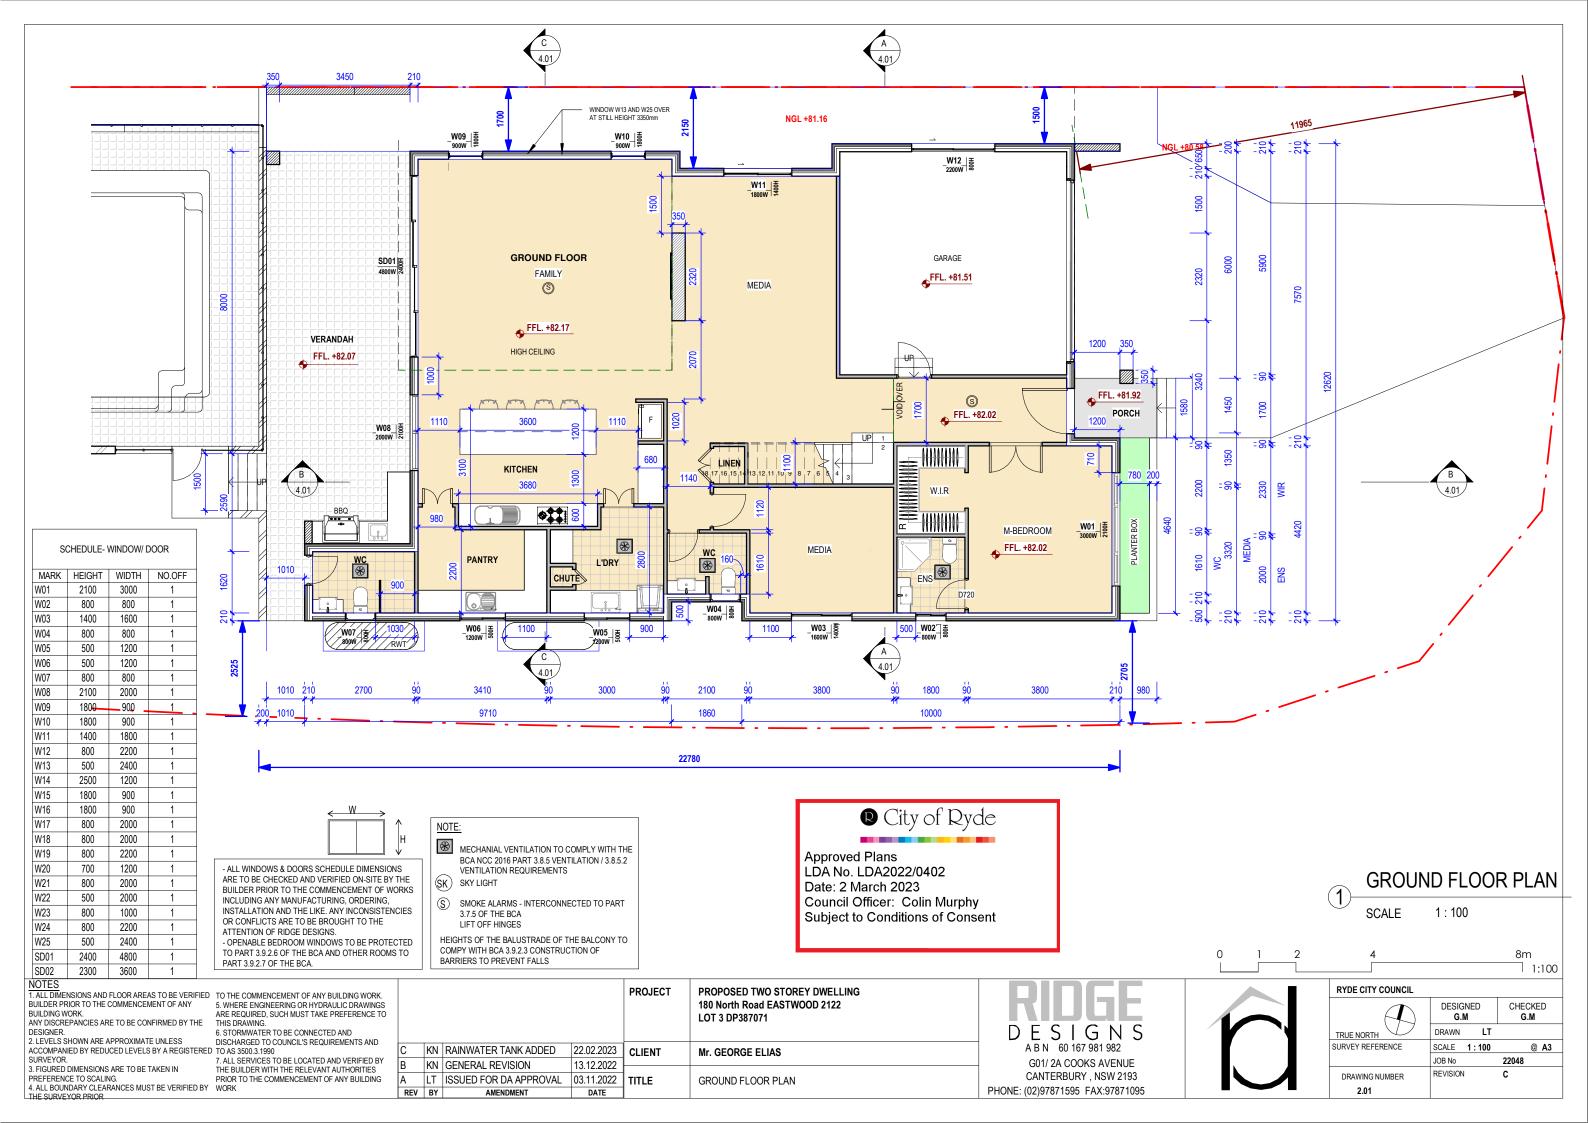


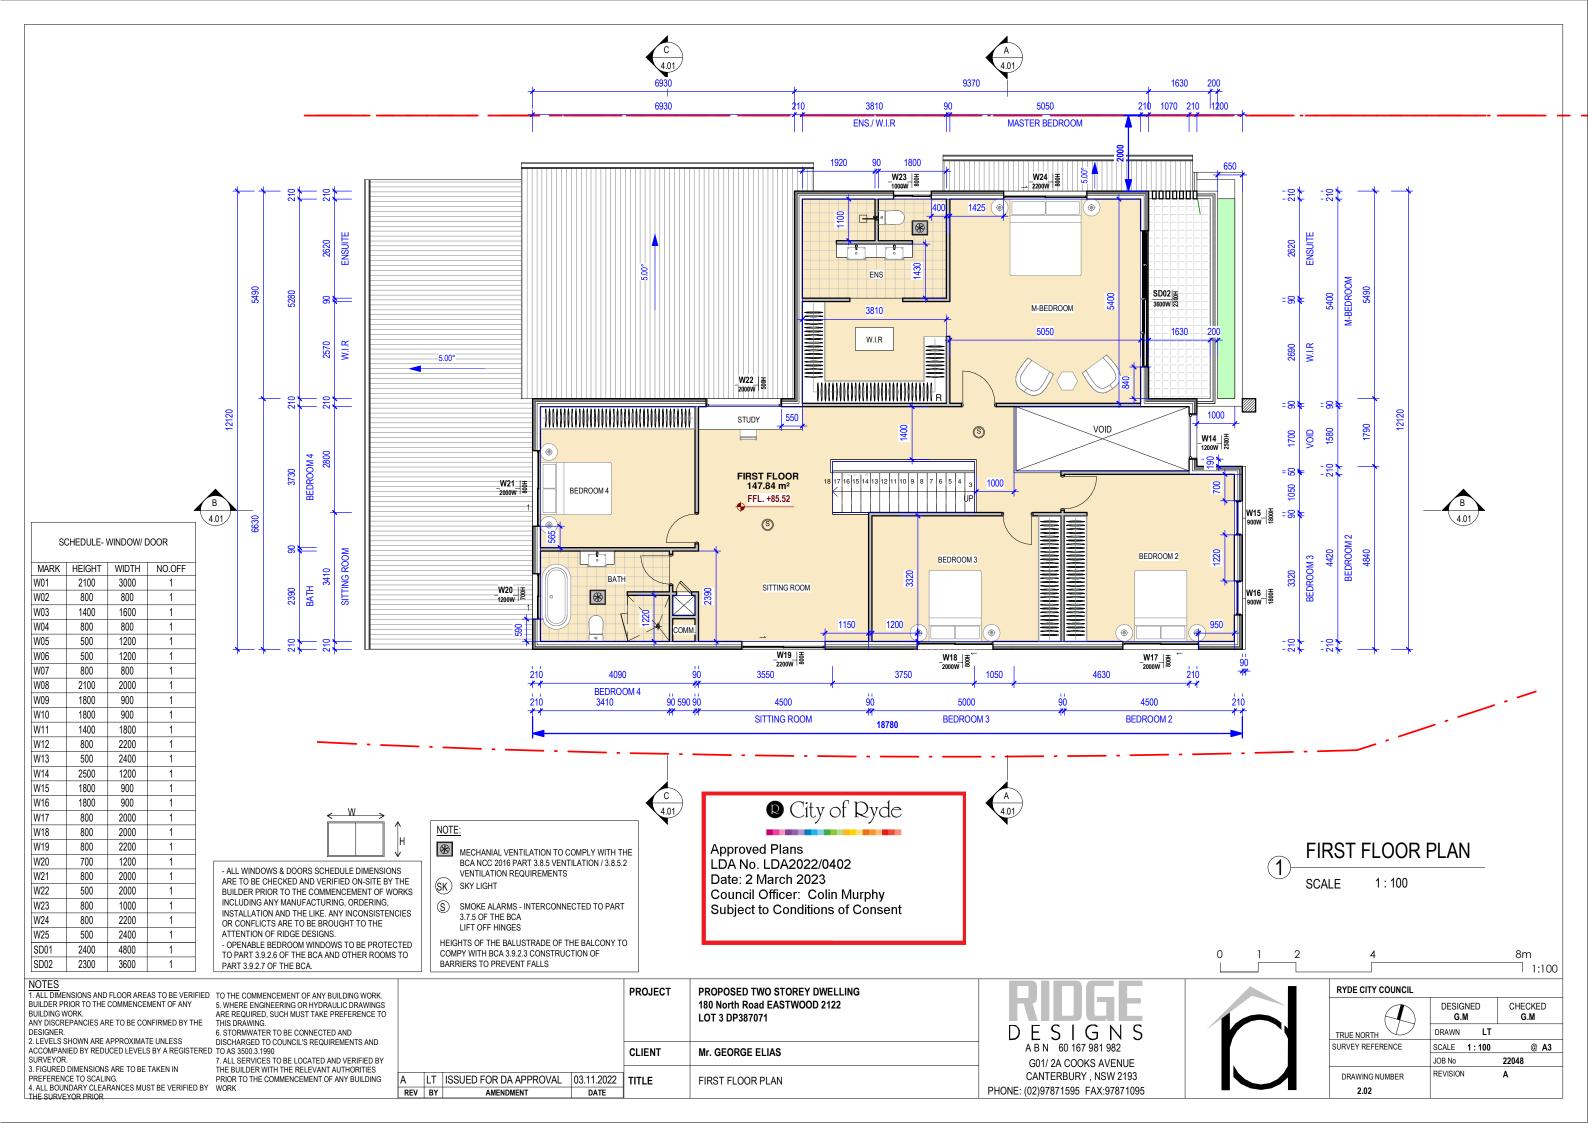


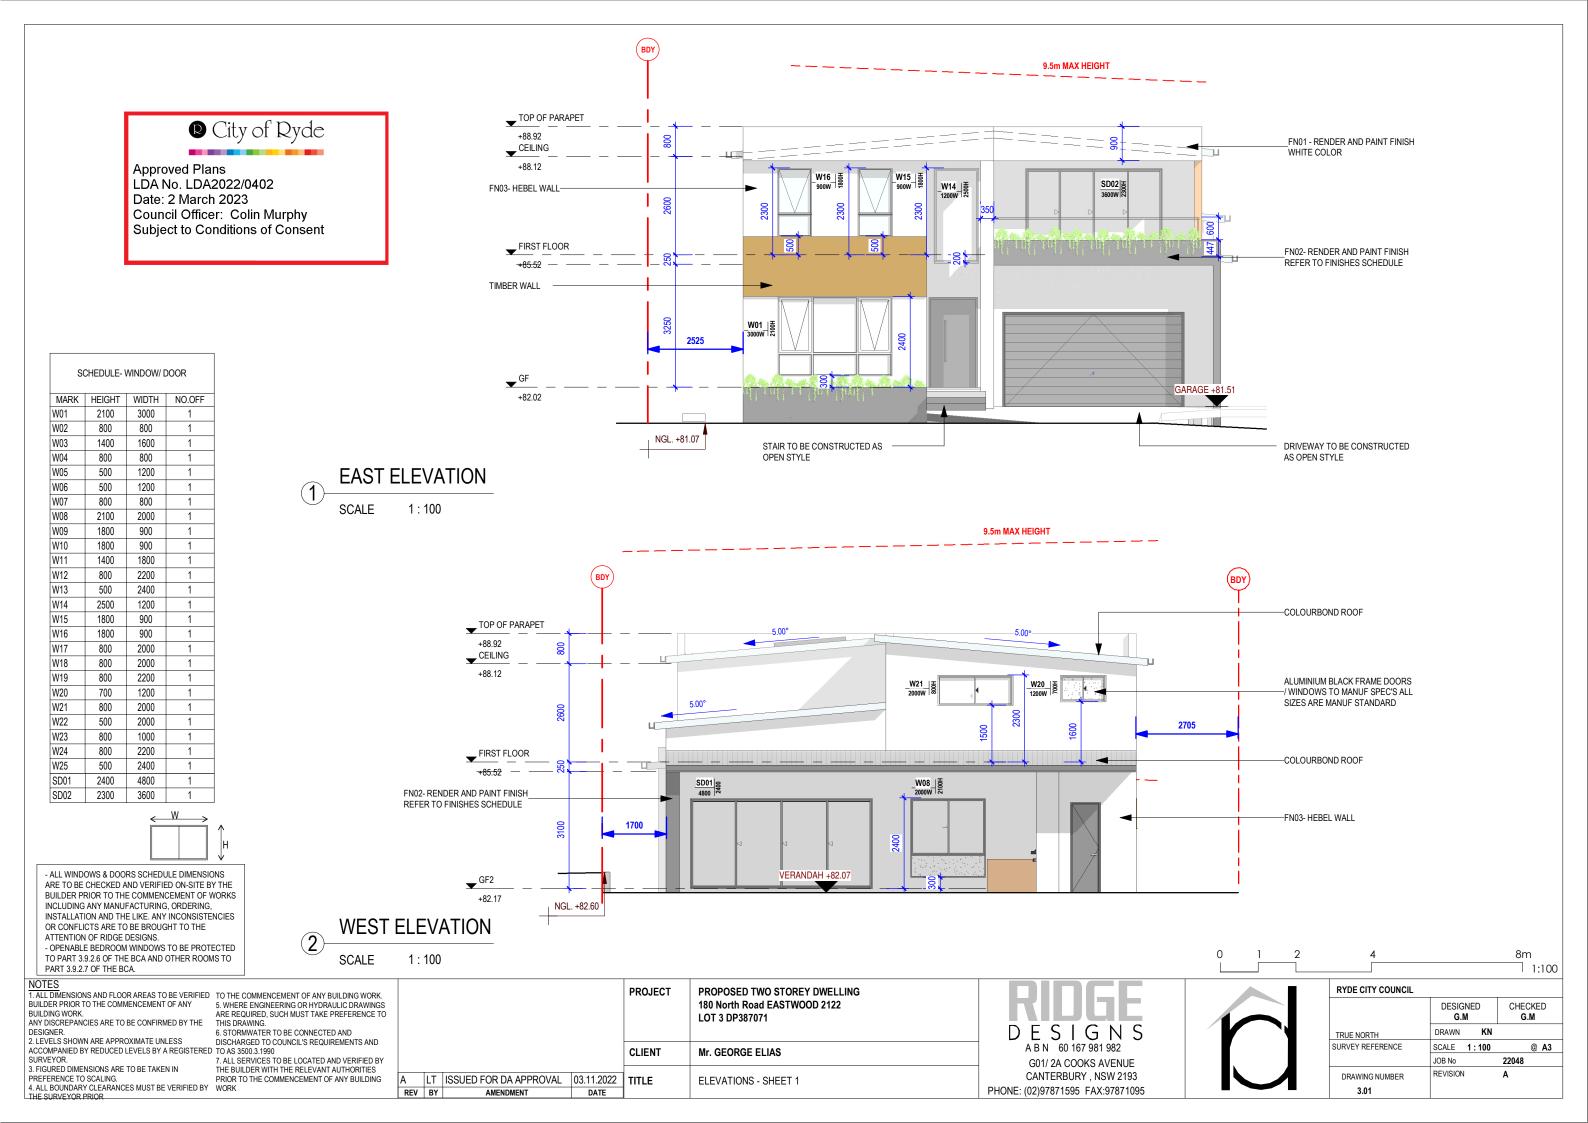

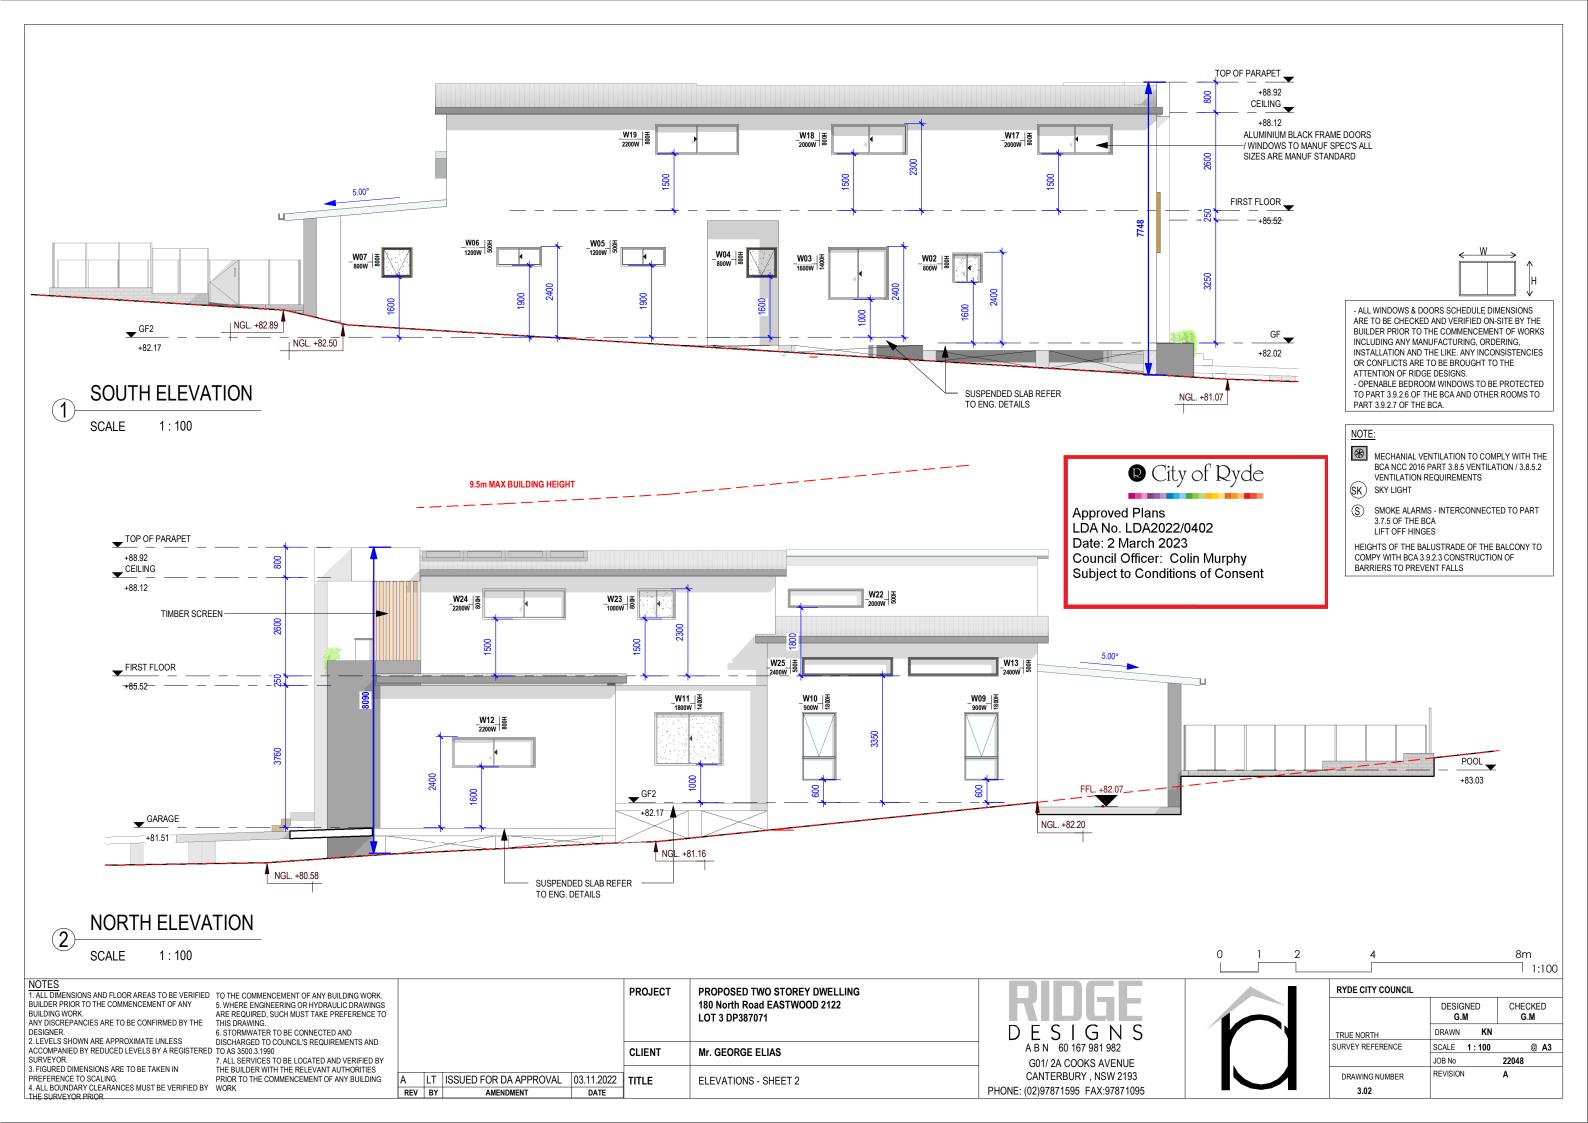

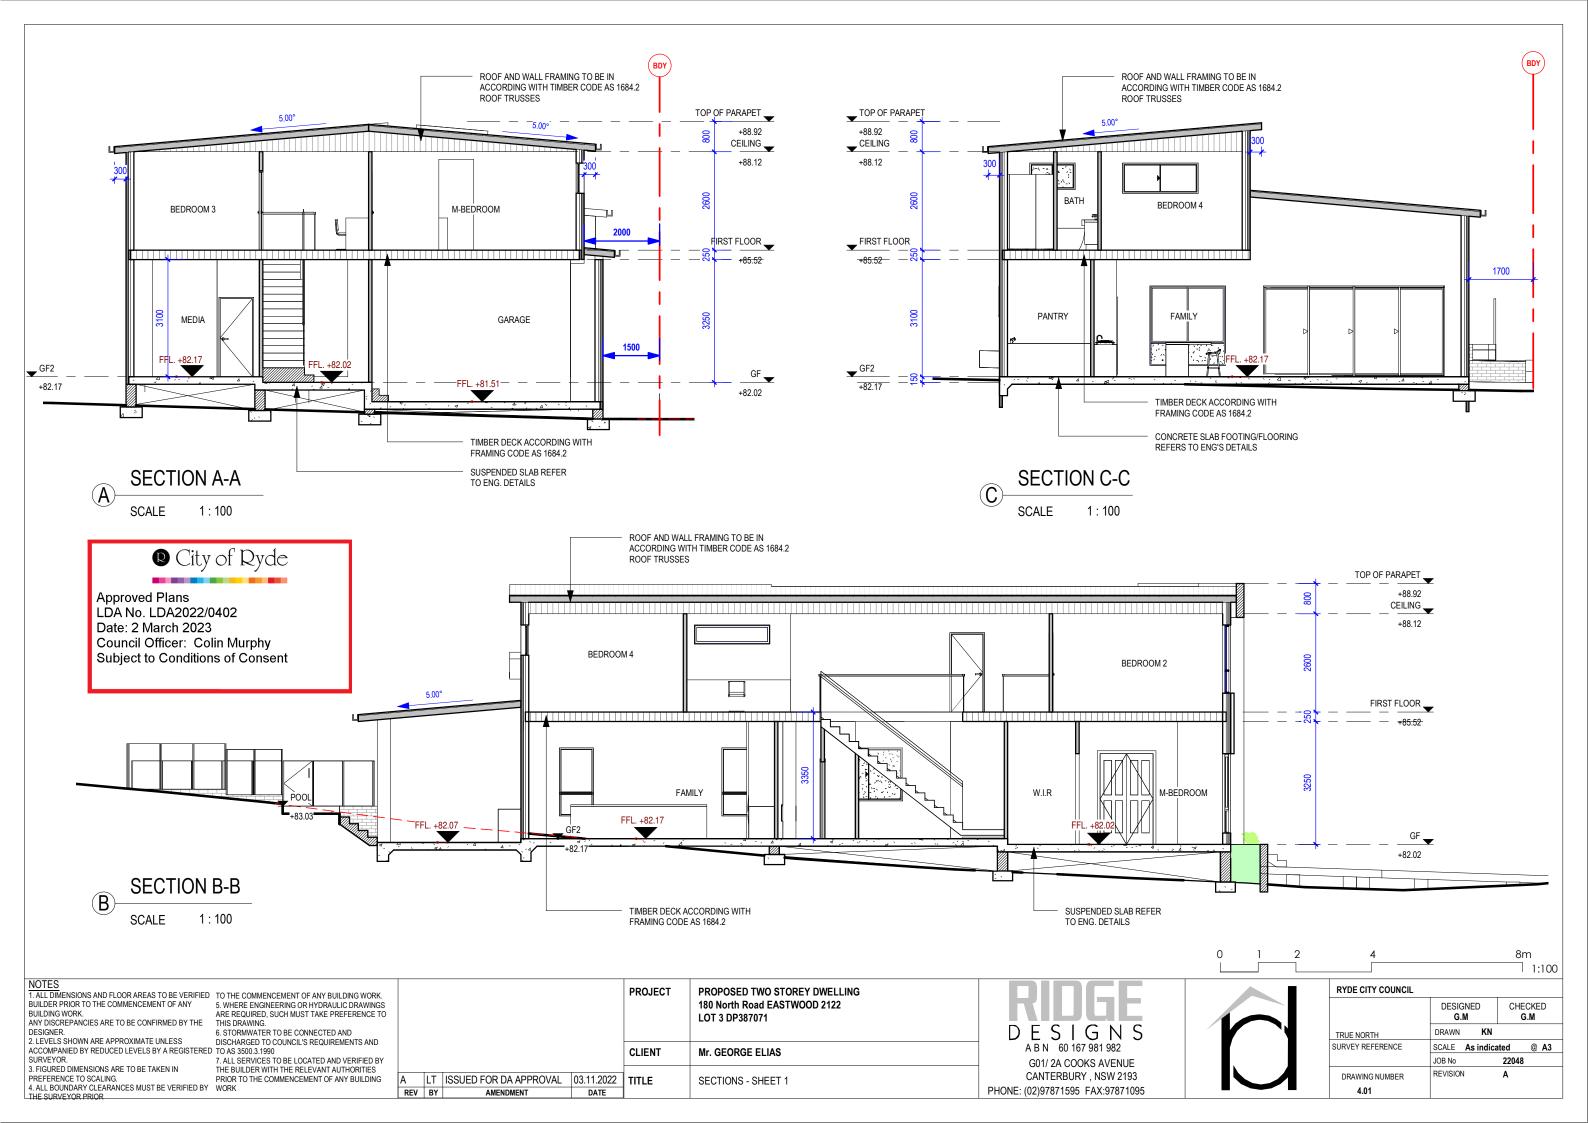

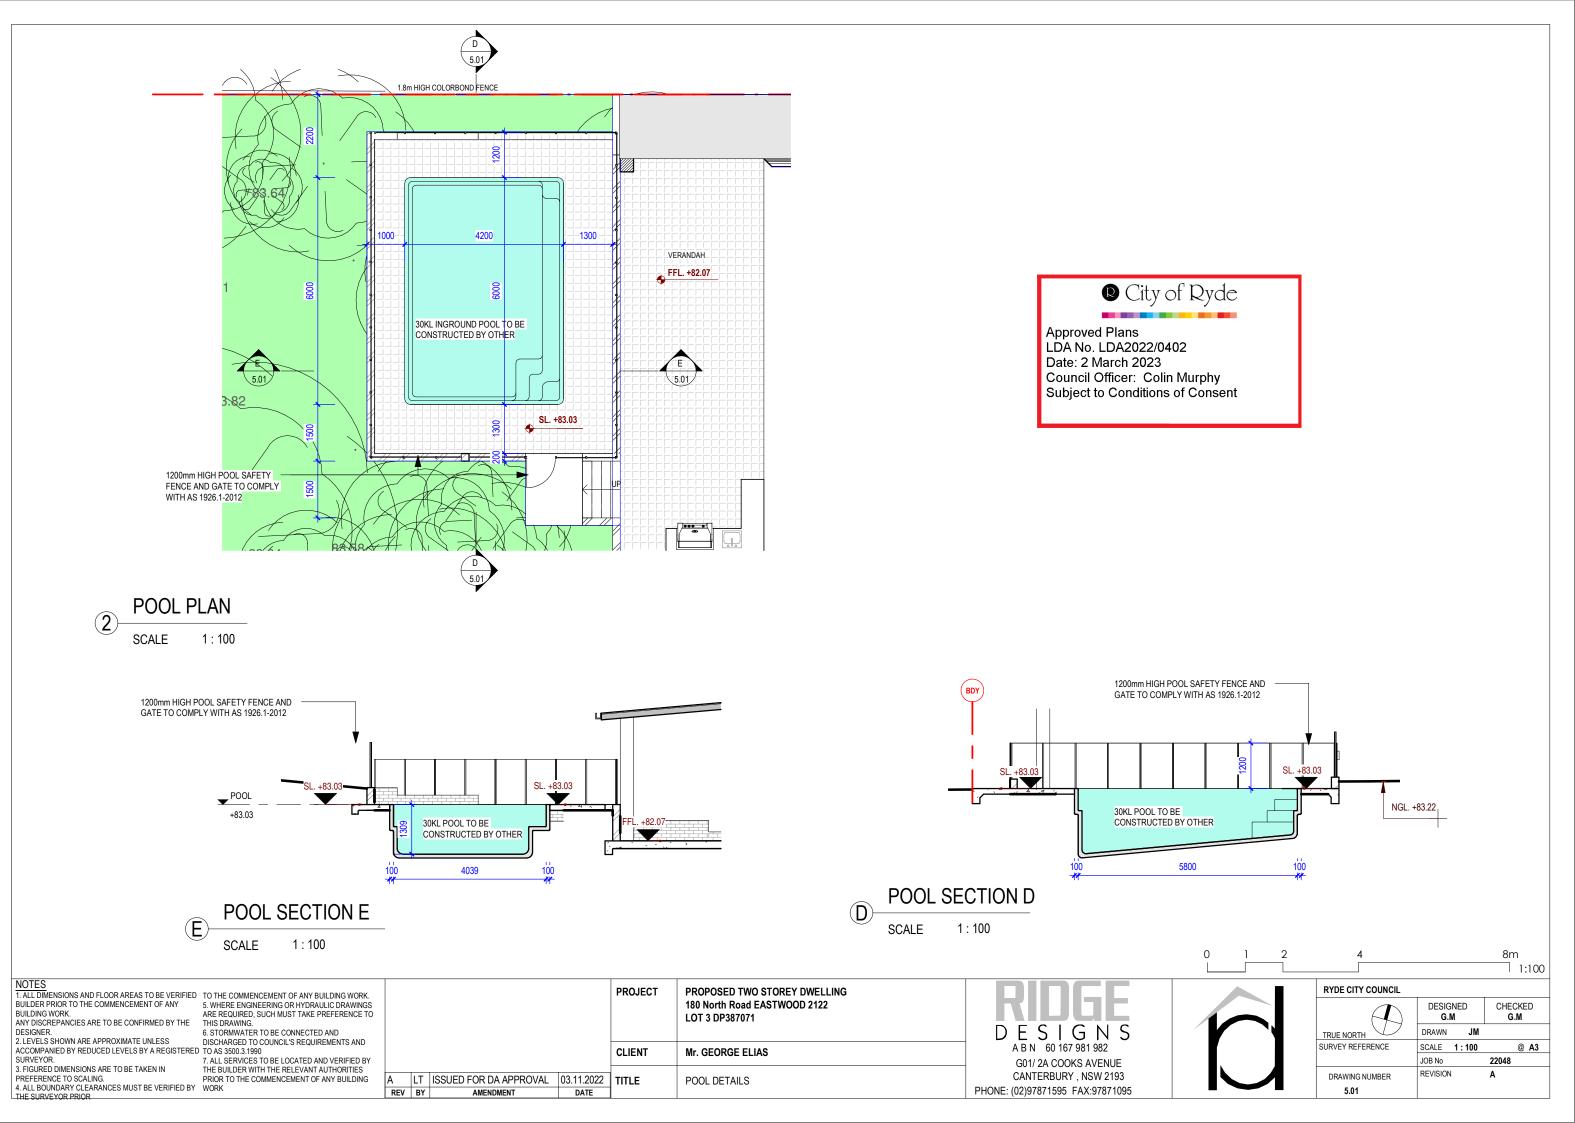

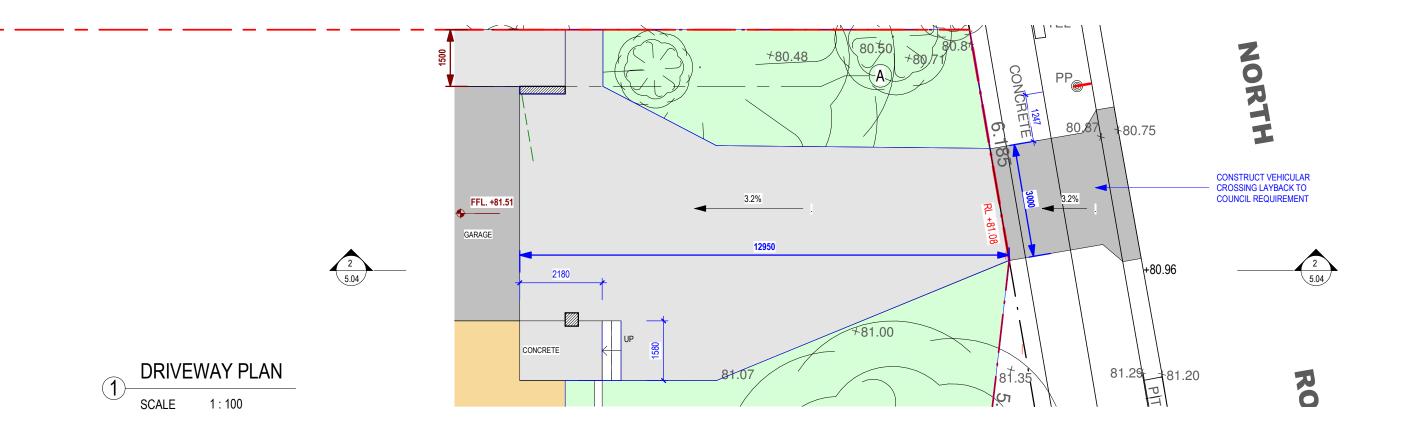



Approved Plans LDA No. LDA2022/0402 Date: 2 March 2023

Council Officer: Colin Murphy Subject to Conditions of Consent


DRIVEWAY NOTE:

THE DRIVEWAY GRADIENT IS LESS THAN 12.5% AND COMPLIES WITH THE REQUIREMENTS OF AS 2890.1

LONG SECTION PROFILE

SCALE

1:100

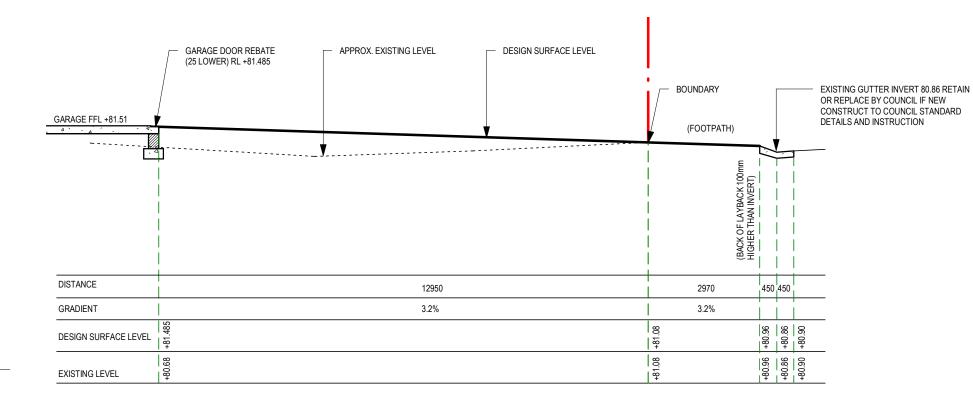

PREFERENCE TO SCALING.

4. ALL BOUNDARY CLEARANCES MUST BE VERIFIED BY WORK

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6. STORMWATER TO BE CONNECTED AND DISCHARGED TO COUNCIL'S REQUIREMENTS AND

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SURVEYOR.

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THE BUILDER WITH THE RELEVANT AUTHORITIES

BY A REGISTERED TO AS 3500.3.1990

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				PROJECT	PROPOSED TWO STOREY DWELLING 180 North Road EASTWOOD 2122 LOT 3 DP387071
				CLIENT	Mr. GEORGE ELIAS
A REV	LT BY	ISSUED FOR DA APPROVAL AMENDMENT	03.11.2022 DATE	TITLE	DRIVEWAY SECTION

RIDGE	
D E S I G N S	
G01/ 2A COOKS AVENUE	
CANTERBURY , NSW 2193	

1	

RYDE CITY COUNCIL				
	DESIGNED G.M		CHECKED G.M	
TRUE NORTH	DRAWN	LT		
SURVEY REFERENCE	SCALE	As indica	ated	@ A3
	JOB No		22048	
DRAWING NUMBER	REVISION	N	Α	
5.04				

BASIX NOTE

CERTIFICATE NUMBER: 1342855S

SINGLE DWELLING

<u>Fixtures</u>

The applicant must install showerheads with a minimum rating of 4 star (> 4.5 but <= 6 L/min plus spray force and/or coverage tests) in all showers in the development.

The applicant must install a toilet flushing system with a minimum rating of 5 star in each toilet in the development.

The applicant must install taps with a minimum rating of 5 star in the kitchen in the development.

The applicant must install basin taps with a minimum rating of 5 star in each bathroom in the development.

Alternative water Rainwater tank

The applicant must install a rainwater tank of at least 2800 litres on the site. This rainwater tank must meet, and be installed in accordance with, the requirements of all applicable regulatory authorities.

The applicant must configure the rainwater tank to collect rain runoff from at least 170 square metres of the roof area of the development (excluding the area of the roof which drains to any stormwater tank or private dam).

- · all toilets in the development
- at least one outdoor tap in the development (Note: NSW Health does not recommend that rainwater be used for human consumption in areas with potable water supply.)
- a tap that is located within 10 metres of the swimming pool in the development.

Swimming pool

The swimming pool must not have a volume greater than 30 kilolitres

The swimming pool must be outdoors.

THERMAL COMFORT COMMITMENTS

General features

The dwelling must not have more than 2 storeys.

The conditioned floor area of the dwelling must not exceed 300 square metres.

The dwelling must not contain open mezzanine area exceeding 25 square metres.

The dwelling must not contain third level habitable attic room.

Floor, walls and ceiling/roof

The applicant must conatruct the floor(s), walls, and ceiling/roof of the dwelling in accordance with the specifications listed in the table below.

Construction	Additional insulation required (R-Value)	Other specifications
floor - concrete slab on ground	nil	
external wall - AAC external, brick internal (AAC: 75 mm)	2.37 (or 3.4 including construction)	
internal wall shared with garage - plasterboard	nil	
ceiling and roof - flat ceiling / flat roof, framed	ceiling: 4.5 (up), roof: foil/sarking	framed; medium (solar absorptance 0.475 - 0.70)

Windows, glazed doors and skylights

The applicant must install the windows, glazed doors and shading devices described in the table below, in accordance with the specifications listed in the table. Relevant overshadowing specifications must be satisfied for each window and glazed door.

The dwelling may have 1 skylight (<0.7 square metres) which is not listed in the table.

The following requirements must also be satisfied in relation to each window and glazed door:

- For the following glass and frame types, the certifier check can be performed by visual inspection. - Aluminium single clear
- Aluminium double (air) clear
- Timber/uPVC/fibreglass single clear
- Timber/uPVC/fibreglass double (air) clear
- Overshadowing buildings/vegetation must be of the height and distance from the centre and the base of the window and glazed door, as specified in the 'overshadowing' column.

Window/glazed door no.	Maximum height (mm)	Maximum width (mm)	Туре	Shading Device (Dimension within 10%)	Overshadowing
North facing					
W09	1800	900	aluminium, single, clear	none	2-4m high, 2-5m away
W10	1800	900	aluminium, single, clear	none	2-4m high, 2-5m away
W11	1400	1800	aluminium, single, clear	none	2-4m high, 2-5m away
W13	500	2400	aluminium, single, clear	eave 450mm, 400mm above head of window or glazed door	not overshadowed
W25	500	2400	aluminium, single, clear	eave 450mm, 400mm above head of window or glazed door	not overshadowed
W23	800	1000	aluminium, single, clear	eave 450mm, 400mm above head of window or glazed door	not overshadowed
W24	800	2200	aluminium, single, clear	eave 450mm, 400mm above head of window or glazed door	not overshadowed
W22	500	2000	aluminium, single, clear	eave 450mm, 400mm above head of window or glazed door	not overshadowed

Window/glazed door no.	Maximum height (mm)	Maximum width (mm)	Туре	Shading Device (Dimension within 10%)	Overshadowing
East facing					
W01	2100	3000	aluminium, single, clear	none	not overshadowed
W14	2500	1200	aluminium, single, clear	eave 1200mm, 200mm above head of window or glazed door	not overshadowed
W15	1800	900	aluminium, single, clear	eave 250mm, 200mm above head of window or glazed door	not overshadowed
W16	1800	900	aluminium, single, clear	eave 1600mm, 300mm above head of window or glazed door	not overshadowed
SD02	2300	3600	aluminium, single, clear	eave 1600mm, 300mm above head of window or glazed door	not overshadowed
South facing			1	1	1
W02	800	800	aluminium, single, clear	none	not overshadowed
W03	1400	1600	aluminium, single, clear	none	not overshadowed
W04	800	800	aluminium, single, clear	solid overhang 500mm, 500mm above head of window or glazed door	not overshadowed
W05	500	1200	aluminium, single, clear	none	not overshadowed
W06	500	1200	aluminium, single, clear	none	not overshadowed
W07	800	800	aluminium, single, clear	eave 450mm, 400mm above head of window or glazed door	not overshadowed
W17	800	2000	aluminium, single, clear	eave 450mm, 400mm above head of window or glazed door	not overshadowed
W18	800	2000	aluminium, single, clear	eave 450mm, 400mm above head of window or glazed door	not overshadowed
W19	800	2200	aluminium, single, clear	eave 450mm, 400mm above head of window or glazed door	not overshadowed
West facing					
SD01	2400	4800	aluminium, single, clear	verandah 4000mm, 2400mm above base of window or glazed door	not overshadowed
W08	2100	2000	aluminium, single, clear	verandah 4000mm, 2400mm above base of window or glazed door	not overshadowed
W20	700	1200	aluminium, single, clear	eave 450mm, 700mm above head of window or glazed door	not overshadowed
W21	800	2000	aluminium, single, clear	eave 450mm, 700mm above head of window or glazed door	not overshadowed

Energy Commitments

Hot water

The applicant must install the following hot water system in the development, or a system with a higher energy rating: gas instantaneous with a performance of 5 stars. Cooling system

The applicant must install the following cooling system, or a system with a higher energy rating, in at least 1 living area: airconditioning ducting only; Energy rating: n/a The applicant must install the following cooling system, or a system with a higher energy rating, in at least 1 bedroom: airconditioning ducting only; Energy rating: n/a

The applicant must install the following heating system, or a system with a higher energy rating; in at least 1 living area: airconditioning ducting only; Energy rating: n/a The applicant must install the following heating system, or a system with a higher energy rating, in at least 1 bedroom: airconditioning ducting only; Energy rating: n/a

The applicant must install the following exhaust systems in the development:

At least 1 Bathroom: no mechanical ventilation (ie. natural); Operation control: n/a

Kitchen: no mechanical ventilation (ie. natural): Operation control: n/a Laundry: natural ventilation only, or no laundry; Operation control: n/a

Artificial lighting

The applicant must ensure that the "primary type of artificial lighting" is fluorescent or light emitting diode (LED) lighting in each of the following rooms, and where the word "dedicated" appears, the fittings for

those lights must only be capable of accepting fluorescent or light emitting diode (LED) lamps:

- at least 5 of the bedrooms / study; dedicated
- at least 3 of the living / dining rooms; dedicated
- · the kitchen; dedicated
- all bathrooms/toilets: dedicated
- the laundry; dedicated · all hallways: dedicated
- Natural lighting

The applicant must install a window and/or skylight in the kitchen of the dwelling for natural lighting.

The applicant must install a window and/or skylight in 4 bathroom(s)/toilet(s) in the development for natural lighting.

Swimming pool

The applicant must install the following heating system for the swimming pool in the development (or alternatively must not install any

The applicant must install a timer for the swimming pool pump in the development.

Alternative evergy

The applicant must install a photovoltaic system with the capacity to generate at least 4 peak kilowatts of electricity as part of the development. The applicant must connect this system to the development's electrical system

PROPOSED TWO STOREY DWELLING

180 North Road EASTWOOD 2122

LOT 3 DP387071

The applicant must install a gas cooktop & electric oven in the kitchen of the dwelling.

The applicant must install a fixed outdoor clothes drying line as part of the development.

RIDGE	
DESIGNS	/
ABN 60 167 981 982	
G01/ 2A COOKS AVENUE	
CANTERBURY, NSW 2193	
PHONE: (02)97871595 FAX:97871095	

RYDE CITY COUNCIL			
	DESIGNED G.M	CHECKED G.M	
TRUE NORTH	DRAWN KN		
SURVEY REFERENCE	SCALE 1:100	@ A3	
	JOB No	22048	
DRAWING NUMBER	REVISION	Α	
6.01			

P City of Ryde

Approved Plans

Date: 2 March 2023

LDA No. LDA2022/0402

Council Officer: Colin Murphy

Subject to Conditions of Consent

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LT ISSUED FOR DA APPROVAL 03.11.2022 TITLE AMENDMENT

CLIENT Mr. GEORGE ELIAS **BASIX NOTE**

PROJECT

DECORATIVE GRAVEL /
CONCRETE PATH AS SELECTED


DRAINAGE - REFER TO
HYDRAULICS DRAWING

TREE PROPOSED TO BE REMOVED - DASHED
TREE TO BE RETAINED - SOLID
REFER TO TREE REPORT BY REDGUM
HORTICULTURAL - DATED 14.09.22

75-100MM SELECTED ORGANIC MULCH
BENEATH EXISTING TREES


REFER TO HYDRAULICS ENGINEERS PLAN FOR OSD / DWARF WALL DETAILS - MULCH OSD WITH NON FLOATABLE DECORATIVE GRAVEL. ALL FINISHED GROUND LEVELS AS PER HYDRAULICS ENGINEERS DETAILS.

ALL FENCING SURROUNDING THE POOL IS TO COMPLY WITH THE SWIMMING POOLS ACT 1992 AND AS.1926.1-2012 - PARTICULARLY NCZ 4 FOR ALL BARRIERS LESS THAN 1800mm.

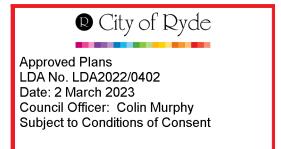


PLANT SCHEDULE						
BOTANIC NAME	KEY	QTY	POT SIZE	HT (M)		
TREES						
ULMIS PARVIFOLIA	UP	01	45LTR	10+		
WATERHOUSIA FLORIBUNDA*	WF	01	45LTR	10+		
SHRUBS / GROUNDCOVERS						
ACMENA 'SUBLIME'*	AS	10	200MM	3		
GARDENIA 'FLORIDA'	GF	5	200MM	1.5		
SYZYGIUM 'CULTIVAR'*	SC	10	200MM	TO 3M		
WESTRINGIA 'MUNDI'*	WM	16	150MM	1.2		

^{*}NATIVE SPECIES

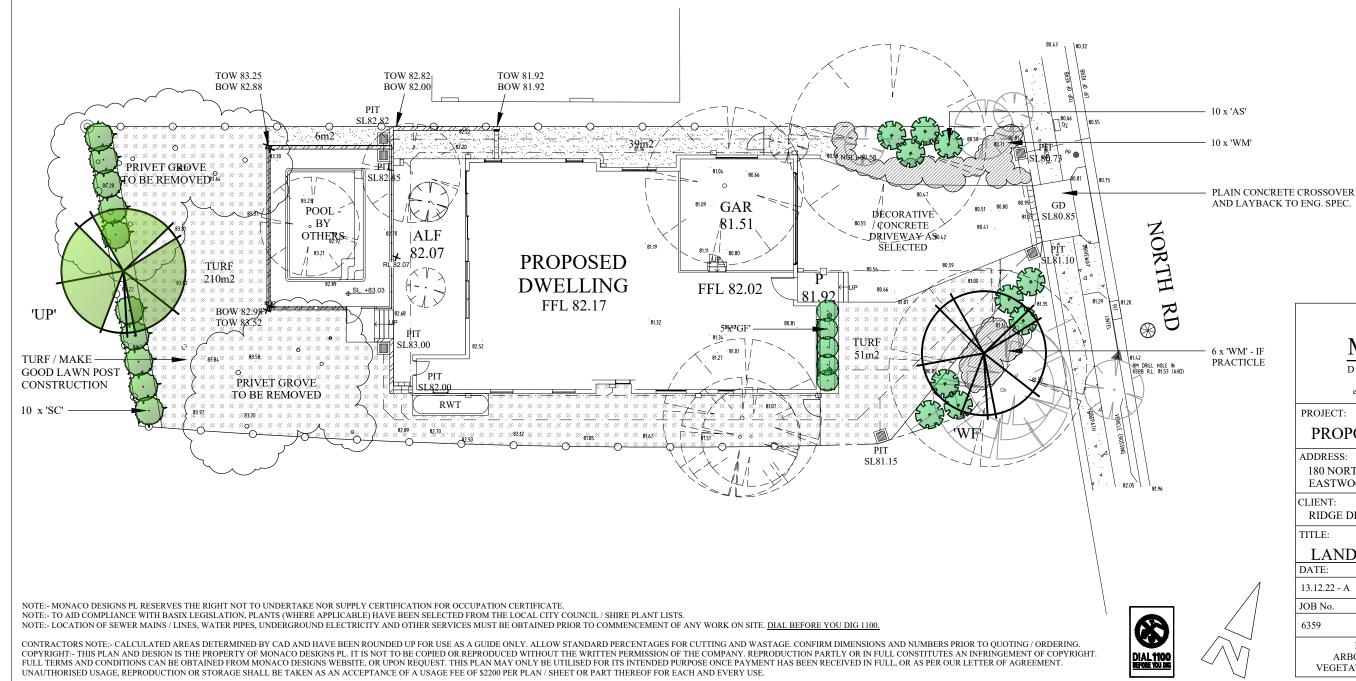

email: paul@monaco.net.au PROJECT: PROPOSED DWELLING ADDRESS: 180 NORTH ROAD, EASTWOOD CLIENT: RIDGE DESIGNS DA LANDSCAPE CONCEPT SCALE: SHEET No: DATE: 13.12.22 - A 1:200 - A3 OF JOB No. DRAWN:

LANDSCAPE PLANS
ARBORICULTURAL REPORTS
VEGETATION MANAGEMENT PLANS

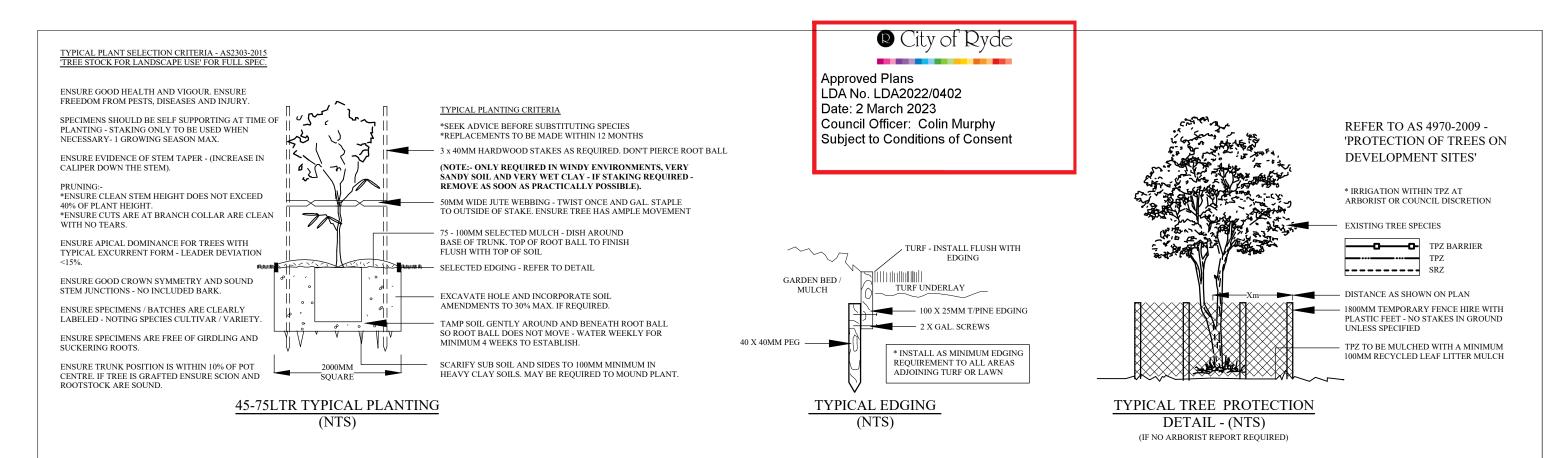

GENERAL NOTES:-

- * LANDSCAPE CONTRACTOR TO CHECK DA CONDITIONS AND STAMPED LANDSCAPE PLAN
- BEFORE COMMENCING WORKS TO ENSURE NO ADDITIONS / AMENDMENTS TO PLAN.
 * GARDEN BEDS IN OSD BASIN TO CONSIST OF NON FLOATABLE DECORATIVE GRAVEL.
- * REFER TO HYDRAULICS ENGINEERS PLAN FOR OSD DETAILS / FINAL LEVELS. * MULCHED PLANTING BEDS TO BE A MINIMUM DEPTH OF 75MM AS SELECTED
- * CONTRACTORS RESPONSIBILITY TO CHECK AND ADJUST SOIL pH AS REQUIRED
- * PROVIDE TIMBER EDGE AS A MINIMUM BENEATH FENCING / GATES TO DEFINE TURE AND GARDEN BEDS / PATHWAYS. EDGING TO BE PROVIDED TO ALL AREAS WHERE DIFFERING MATERIALS MEET, ie TURF / GARDEN, TURF / GRAVEL PATH ETC.

 * WEED MAT BENEATH GRAVEL PATHWAYS REQUIRED TO LIMIT MUD TRACKING.

- * PREMIUM ORGANIC GARDEN MIX TO BE USED.
 * ALL PLANTS TO BE HEALTHY AND VIGOROUS.
- * CONTRACTOR TO MAKE GOOD TURF ON NATURE STRIP POST CONSTRUCTION. * DO NOT SCALE ARCHITECTURAL SETOUT FROM LANDSCAPE DRAWING.
- * EXISTING TREE SPREAD APPROXIMATE ONLY. REFER TO TREE REPORT WHEN APPLICABLE.
- * SITE SURVEY PROVIDED BY OTHERS.
- * BUFFALO TURF PREFERRED OVER KIKUYU.

PLANTING AND MAINTENANCE NOTES:-

- $\hbox{* GLAZED OR POLISHED PLANTING HOLES, PARTICULARLY IN CLAY SOILS SHOULD BE AVOIDED. PLANTS}$
- TO BE MOUNDED WITHIN THESE SOIL TYPES.

 * PLANTS SHOULD BE PLANTED STRAIGHT, WITH THE TOP OF THE ROOT BALL LEVEL WITH OR SLIGHTLY
- LOWER THAN THE SOIL SURFACE

- LOWER THAN THE SOIL SURFACE.

 * PLANTS SHOULD BE WATERED AS SOON AS POSSIBLE AFTER PLANTING.

 * PLANTING SHOULD BE AVOIDED AT THE HEIGHT OF SUMMER (DECEMBER JANUARY)

 * PLANTS SHOULD BE WATERED AT LEAST WEEKLY FOR SIX WEEKS TO AID ESTABLISHMENT. WATER

 CRYSTALS MAY BE USED TO REDUCE THE AMOUNT OF WATER REQUIRED.

 *IF A FERTILISER IS TO BE APPLIED, A SLOW RELEASE 8 9 MONTH PLANT FOOD PREFERRED.

 * ONLY SPECIES WITHIN THE LANDSCAPE PLAN SHOULD BE PLANTED. PERMISSION SHOULD BE SOUGHT

 BEFORE ALTERING THE PLANT SPECIES LIST (ON MOST OCCASIONS NURSERIES CAN SUBSTITUTE).


 * STOCK SHOULD BE FREE OF PESTS, DISEASE AND WEEDS AND NOT POT BOUND.

 * REPLACEMENT PLANTS SHOULD BE MADE AVAILABLE FOR ANY LOSSES OF PLANT STOCK THAT MAY

 OCCULE FOR A MINIMUM 12 MONTH PERIOD

- OCCUR FOR A MINIMUM 12 MONTH PERIOD
- * WEEDS SHOULD BE REMOVED ON A FORTNIGHTLY BASIS.

 * PEST OR DISEASE SAMPLES TO THE LOCAL NURSERY FOR IDENTIFICATION AND APPROPRIATE REMEDY.

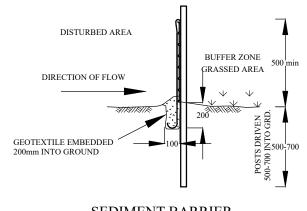

SEDIMENT BARRIER

(PROVIDE ON ALL DOWN HILL SLOPES - UNLESS STATED OTHERWISE)

BUFFALO PREFERRED SPECIES 100MM DEPTH OF TOP SOIL PAVING OR EDGING BRICK / PAVER CULTIVATE SUB TURF PREPERATION DETAIL

GARDEN

& MULCH

TURE AS SELECTED INSTALL -

BRICK / PAVER


CONCRETE HAUNCH

NOTE:- MONACO DESIGNS PL RESERVES THE RIGHT NOT TO UNDERTAKE NOR SUPPLY CERTIFICATION FOR OCCUPATION CERTIFICATE

NOTE:- TO AID COMPLIANCE WITH BASIX LEGISLATION, PLANTS (WHERE APPLICABLE) HAVE BEEN SELECTED FROM THE LOCAL CITY COUNCIL / SHIRE PLANT LISTS.

NOTE:- LOCATION OF SEWER MAINS / LINES, WATER PIPES, UNDERGROUND ELECTRICITY AND OTHER SERVICES MUST BE OBTAINED PRIOR TO COMMENCEMENT OF ANY WORK ON SITE. DIAL BEFORE YOU DIG 1100.

CONTRACTORS NOTE:- CALCULATED AREAS DETERMINED BY CAD AND HAVE BEEN ROUNDED UP FOR USE AS A GUIDE ONLY. ALLOW STANDARD PERCENTAGES FOR CUTTING AND WASTAGE. CONFIRM DIMENSIONS AND NUMBERS PRIOR TO QUOTING / ORDERING. COPYRIGHT:- THIS PLAN AND DESIGN IS THE PROPERTY OF MONACO DESIGNS PL. IT IS NOT TO BE COPIED OR REPRODUCED WITHOUT THE WRITTEN PERMISSION OF THE COMPANY. REPRODUCTION PARTLY OR IN FULL CONSTITUTES AN INFRINGEMENT OF COPYRIGHT. FULL TERMS AND CONDITIONS CAN BE OBTAINED FROM MONACO DESIGNS WEBSITE, OR UPON REQUEST. THIS PLAN MAY ONLY BE UTILISED FOR ITS INTENDED PURPOSE ONCE PAYMENT HAS BEEN RECEIVED IN FULL, OR AS PER OUR LETTER OF AGREEMENT. UNAUTHORISED USAGE, REPRODUCTION OR STORAGE SHALL BE TAKEN AS AN ACCEPTANCE OF A USAGE FEE OF \$2200 PER PLAN / SHEET OR PART THEREOF FOR EACH AND EVERY USE

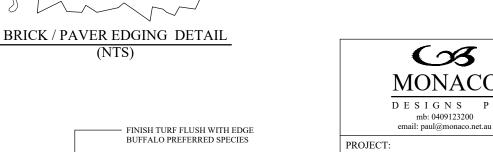

TURE

UNDERLAY

PROPOSED DWELLING

ADDRESS:

180 NORTH ROAD, EASTWOOD

CLIENT:

RIDGE DESIGNS

LANDSCAPE DETAILS

DATE: SCALE: SHEET No: 13.12.22 - A 1:200 - A3 OF JOB No. DRAWN: 6359 P MONACO

LANDSCAPE PLANS ARBORICULTURAL REPORTS VEGETATION MANAGEMENT PLANS

180 NORTH ROAD, EASTWOOD PROPOSED TWO STOREY DWELLING

STORMWATER MANAGEMENT PLANS



P City of Ryde

Approved Plans
LDA No. LDA2022/0402
Date: 2 March 2023
Council Officer: Colin Murphy
Subject to Conditions of Consent

LOCALITY PLAN

DRAWING INDEX

Drawing No. DESCRIPTION

000 COVER SHEET PLAN

101 STORMWATER LAYOUT PLAN


102 STORMWATER CATCHMENT PLAN

103 COMBINED OSD/BASIX TANK DETAILS

104 SEDIMENT & EROSION CONTROL PLANS MISCELLANEOUS DETAILS

Development Engineering Service
Approved Engineering Plans
Application Number: LDA2022/402
Council Officer: HJ
Date: 28/2/23

					Co B.
D	COUNCIL COMMENTS	21/02/2023	GGH	JSF	Ci
С	COUNCIL COMMENTS	13/12/2022	GGH	JSF	
В	ARCHITECTURAL AMENDMENTS	25/11/2022	GGH	JSF	
Α	ISSUE FOR COMPLYING DEVELOPMENT CERTIFICATE	20/09/2022	GGH	JSF	
sue	Description	Date	Design	Checked	
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Architect
Ridge Design

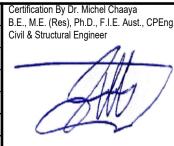G01/ 2A Cooks Avenue
Canterbury, NSW 2193
Email: info@ridgedesigns.com.au
PHONE: (02) 9787 1595

City of
Ryde Council

TELFORDCIVIL

DESIGN & CONSTRUCTION EXCELLENCE

Level 14, 32 Smith Street,
Parramatta NSW 2150

Phone: 02 7809 4931

PO BOX 3579 Parramatta 2124 Company: Telford Consulting Pty Lt


180 NORTH ROAD, EASTWOOD
PROPOSED TWO STOREY DWELLING
STORMWATER MANAGEMENT PLANS
COMPLYING DEVELOPMENT CERTIFICATE
Scale
N.T.S.

COVER SHEET PLAN

Scale A3 | Project No. | Dwg. No.

2021185

000

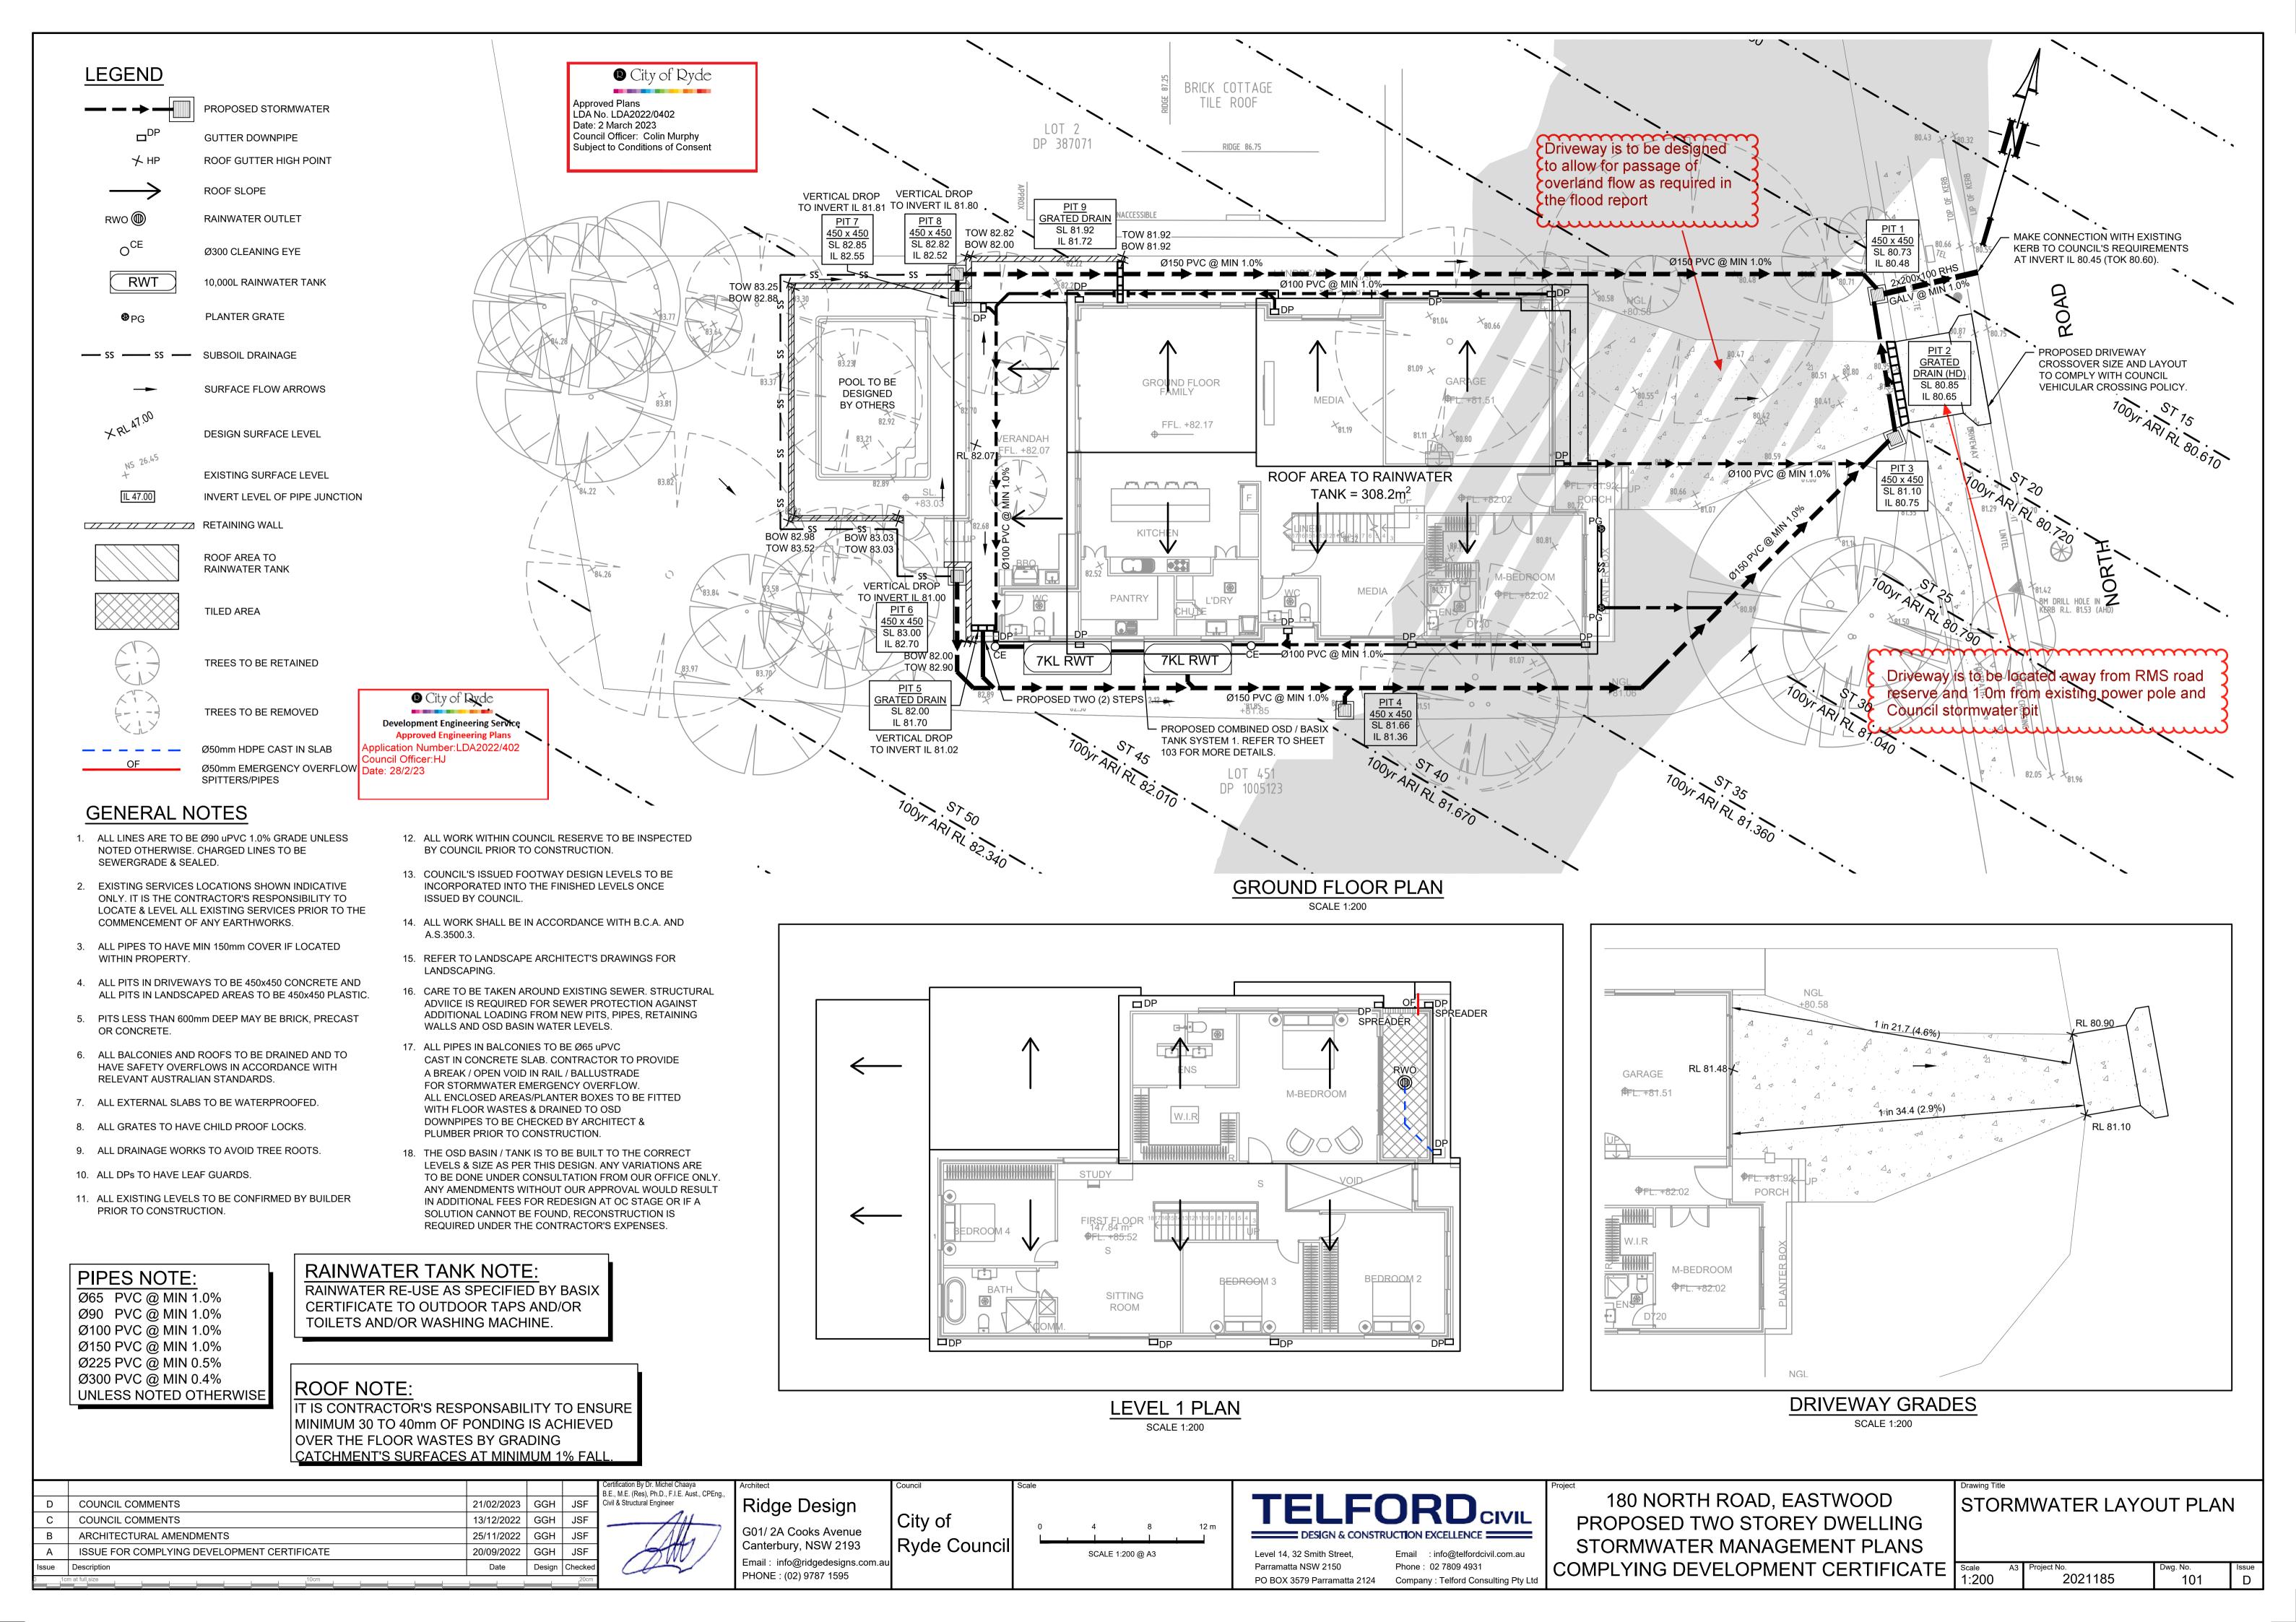

CATCHMENT LEGEND


ROOF CATCHMENT = 308.5m²

IMPERVIOUS GROUND CATCHMENT = 74.5m²

+ + + +

PERVIOUS CATCHMENT = 413.7m²

TOTAL SITE AREA = 796.7m²

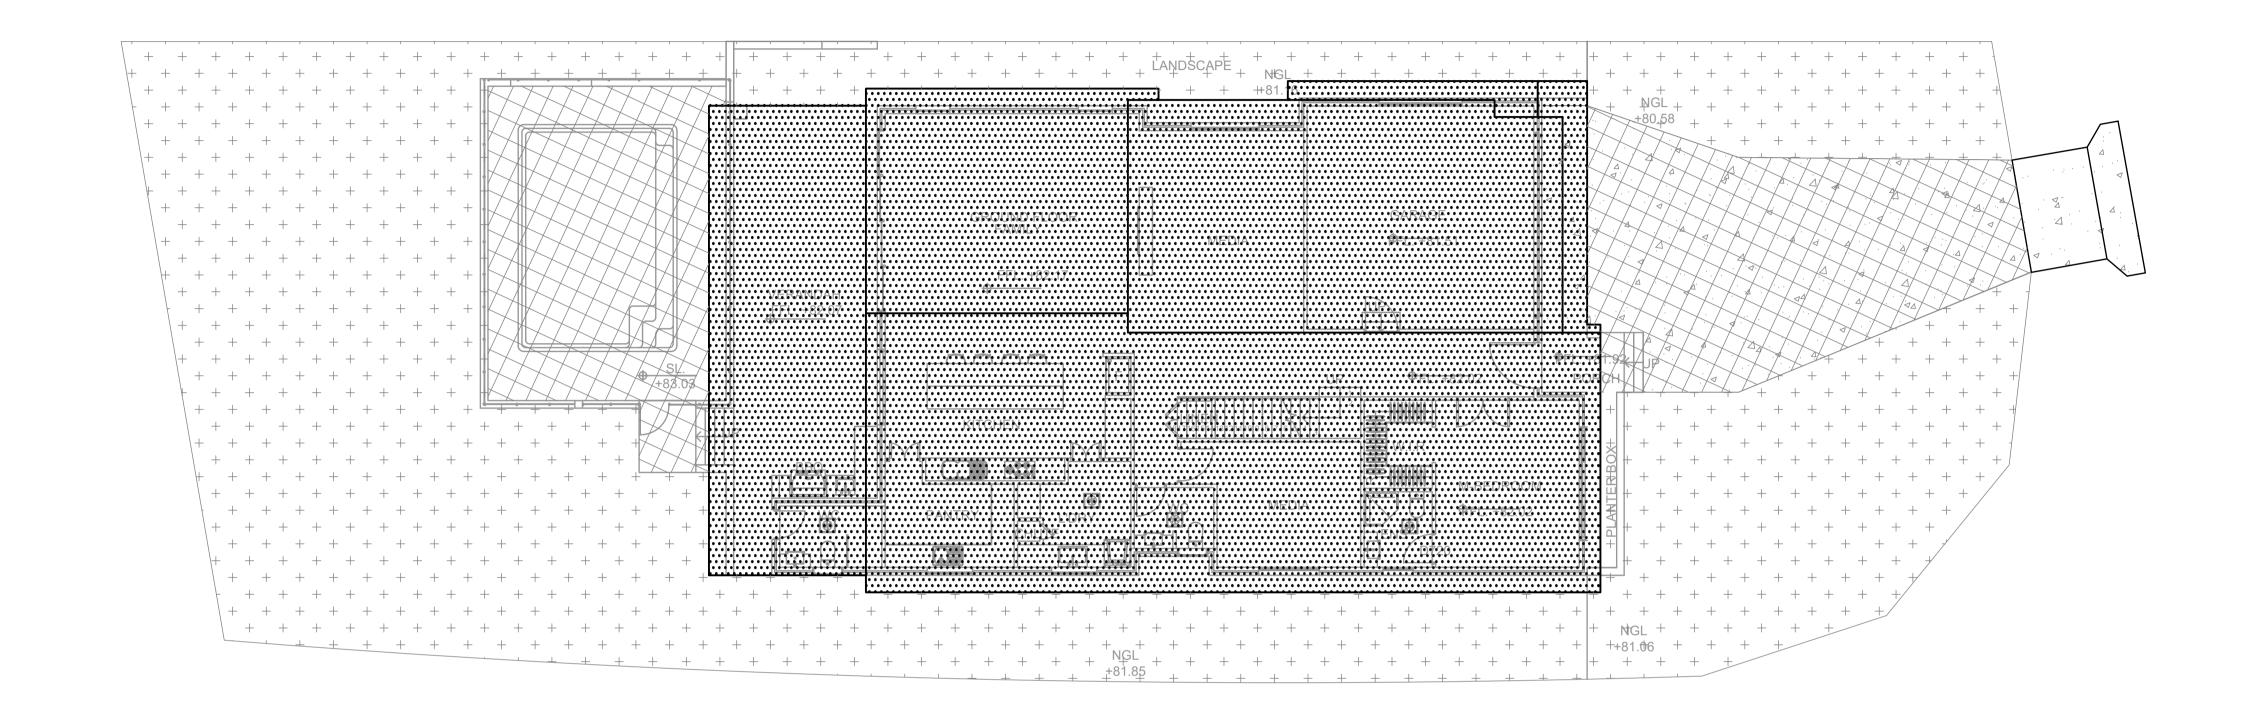

CATCHMENT PLAN
SCALE 1:200

Approved Plans
LDA No. LDA2022/0402
Date: 2 March 2023
Council Officer: Colin Murphy
Subject to Conditions of Consent


Development Engineering Service
Approved Engineering Plans
Application Number:LDA2022/402
Council Officer:HJ
Date: 28/2/23

					Certif B.E.,
D	COUNCIL COMMENTS	21/02/2023	GGH	JSF	Civil
С	COUNCIL COMMENTS	13/12/2022	GGH	JSF	_
В	ARCHITECTURAL AMENDMENTS	25/11/2022	GGH	JSF	
Α	ISSUE FOR COMPLYING DEVELOPMENT CERTIFICATE	20/09/2022	GGH	JSF	
Issue	Description	Date	Design	Checked	
0 1cr	n at full size 10cm			20cm	i

Certification By Dr. Michel Chaaya
B.E., M.E. (Res), Ph.D., F.I.E. Aust., CPEng.,
Civil & Structural Engineer

Architect
Ridge Design
G01/ 2A Cooks Avenue
Canterbury, NSW 2193
Email: info@ridgedesigns.com.au
PHONE: (02) 9787 1595

City of
Ryde Council

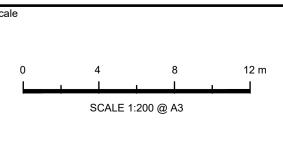




PO BOX 3579 Parramatta 2124 Company : Telford Consulting Pty Ltd

180 NORTH ROAD, EASTWOOD
PROPOSED TWO STOREY DWELLING
STORMWATER MANAGEMENT PLANS
COMPLYING DEVELOPMENT CERTIFICATE

STORMWATER CATCHMENT PLAN

Scale A3 Project No.	Dwg. No.	Issue
1:200 2021185	102	D

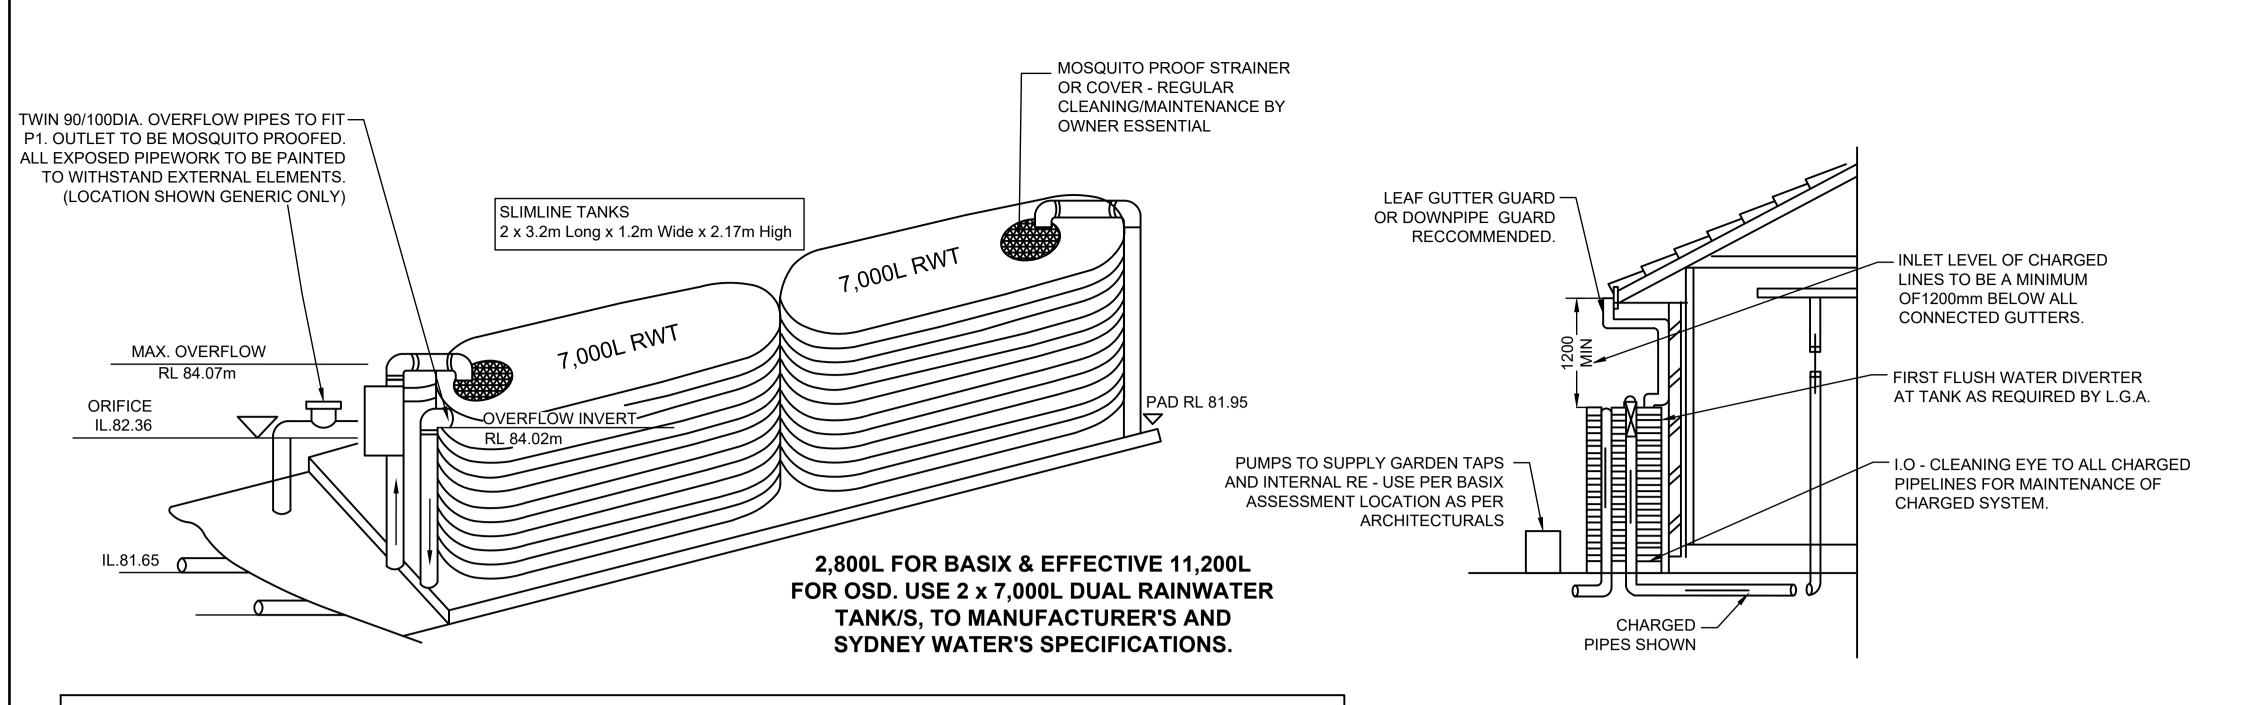

RAINWATER TANKS

COUNCIL COMMENTS

COUNCIL COMMENTS

Issue Description

ARCHITECTURAL AMENDMENTS

ISSUE FOR COMPLYING DEVELOPMENT CERTIFICATE

TANK DETAILS SHOWN ARE A SUGGESTED CONFIGURATION ONLY. ANY MODIFICATION TO TANK VOLUME OR INLET AND OUTLET LEVELS MUST BE APPROVED BY ENGINEER PRIOR TO COMMENCEMENT OF CONSTRUCTION. TANK SHAPE, & DEVICES SHOWN ARE DIAGRAMMATIC ONLY. MINIMUM OF 450 CLEARANCE (UNLESS L.G.A. REQUIRES LARGER SETBACK) TO SIDE BOUNDARIES MUST BE MAINTAINED. CLIENT IS RESPONSIBLE TO ENSURE COMPLIANCE WITH THIS IN THE INSTALLED STATE.

CHARGED STORM WATER LINES FROM ROOF AREAS ONLY TO RAINWATER TANK.

ALL JOINTS TO BE SOLVENT WELDED. ALL EXPOSED PIPEWORK TO BE PAINTED TO WITHSTAND EXTERNAL ELEMENTS.

FIRST FLUSH WATER DIVERTER AT TANK TO COMPLY WITH SYDNEY WATER AND COUNCIL DCP'S. AN APPROVED SWITCH SYSTEM SIMILAR TO 'RAINBANK' TO BE USED VIA MAINS. PUMPS TO MANUF. SPECS.

RAIN TANK TO BE INSTALLED AND MAINTAINTED TO MANUFACTURER'S SPECIFICATIONS AND TO COMPLY WITH ALL SYDNEY WATER GUIDELINES.


CLIENT TO BE RESPONSIBLE FOR MAINTENANCE SYSTEM OF CHARGED PIPELINES. DEBRIS ACCUMULATION SIGNIFICANTLY AFFECT SYSTEMS PERFORMANCE.

MAINTENANCE PROGRAM ESSENTIAL.

STRUCTURAL DETAILS FOR TANK BASE BY MANUFACTURERS OR OTHERS.


COMBINED OSD/BASIX DETAIL

Development Engineering Service
Approved Engineering Plans
Application Number: LDA2022/402
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ON-SITE DETENTION NOTE:

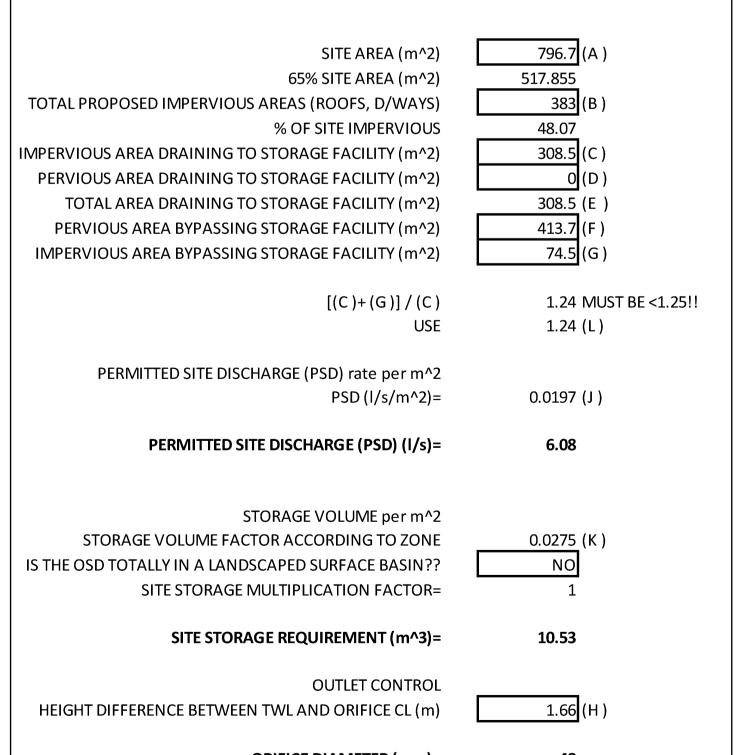THE OSD BASIN / TANK IS TO BE BUILT TO THE CORRECT LEVELS & SIZE AS PER THIS DESIGN. ANY VARIATIONS ARE TO BE DONE UNDER CONSULTATION FROM OUR OFFICE ONLY. ANY AMENDMENTS WITHOUT OUR APPROVAL WOULD RESULT IN ADDITIONAL FEES FOR REDESIGN AT OC STAGE OR IF A SOLUTION CANNOT BE FOUND, RECONSTRUCTION IS REQUIRED UNDER THE CONTRACTOR'S EXPENSES.



FIRST FLUSH WATER DIVERTER DETAIL

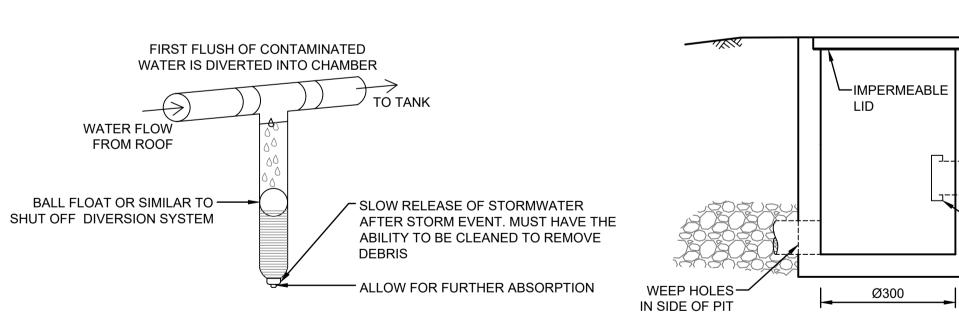N.T.S.

CLEANING EYE DETAIL

Approved Plans
LDA No. LDA2022/0402
Date: 2 March 2023
Council Officer: Colin Murphy
Subject to Conditions of Consent

Email : info@telfordcivil.com.au

Phone: 02 7809 4931

PO BOX 3579 Parramatta 2124 Company: Telford Consulting Pty Ltd

Level 14, 32 Smith Street,

Parramatta NSW 2150

HEIGHT DIFFERENCE BETWEEN TWL AND ORIFICE CL (m)	1.66 (H)	
ORIFICE DIAMETER (mm)=	48	

Design Checked

21/02/2023 | GGH | JSF

13/12/2022 | GGH | JSF

25/11/2022 | GGH | JSF

20/09/2022 | GGH | JSF

Date

B.E., M.E. (Res), Ph.D., F.I.E. Aust., CPEng.,

Architect	Council	Scale
Ridge Design	City of	
G01/2A Cooks Avenue	Ryde Council	
Email : info@ridgedesigns.com.au PHONE : (02) 9787 1595		



Drawing Title
COMBINED OSD/BASIX TANK DETAILS
TANK DETAILS

THIS IS AN ON-SITE STORMWATER

DETENTION SYSTEM

REQUIRED BY RYDE CITY COUNCIL

IT IS AN OFFENSE TO REDUCE THE VOLUME OR TO

INTERFERE WITH THE ORIFICE PLATE THAT

CONTROLS THE OUTFLOW

THE BASE OF THE OUTLET CONTROL. PIT AND DEBRIS

SCREEN MUST BE CLEANED OF DEBRIS AND BEDIMENT

ON A REGULAR BASIS BY THE OWNER.

THIS PLATE MUST NOT BE REMOVED

SIGNANGE TO BE

PROVIDED TO LID OF DCP

SIZE: 110MM X 80MM

NOTE: ORIFICE OUTLET TO BE

LOCATED ON REAR TANK TO

CLEANING EYE AS CLOSE — AS POSSIBLE TO ORIFICE

48 DIA. ORIFICE SHARPLY -

M+F CAF FITTING OR

DRILLED THROUGH SOLID

FABRICATED GAL. PLATE

IL.82.36

Ø100

ALLOW MAINTENANCE.

-Ø150 PVC

OVERFLOW PIPE

OSD=

=BASIX=

TO OUTLET

SCREW CAP

SEALED

Έ	Scale NTS	А3	Project No. 2021185	Dwg. No. 103	Issue
	14.1.0.		2021100	100	

