10 Jennifer St

Proposed Dual Occupancy @ 10 Jennifer St, RYDE NSW 2112

Revised Development Application Issue - 28th January 2022

STUDIO_BD ARCHITECTURE & INTERIORS

CLERMONT

R E S I D E N C E S

BY YOUNES PROPERTY

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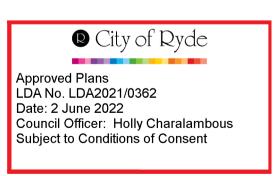
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Revisi	Revisions:			
No	Description	Ву	Date	
В	Draft DA Issue	BD	30/08/21	
С	Draft DA Issue - 2	BD	13/09/21	
D	Development Application Issue	BD	28/09/21	
Е	Revised Development Application Issue	BD	28/01/22	

f Q City of Ryde Approved Plans LDA No. LDA2021/0362 Date: 2 June 2022 Council Officer: Holly Charalambous Subject to Conditions of Consent



STUDIO_BD ARCHITECTURE & INTERIORS Nominated Architect Boris Dragas NSW ARB #7658 t: 0414 866 065 e: boris@studiobd.com.au w: studiobd.com.au abn: 74 219 560 787



Project:	Drawn: BD	Date: 25/01/21
10 JENNIFER ST, RYDE		Scale: NTS
	_ Checked: BD	Sheet Size: A3/A1
Title:	Job No:	Drawing No: Rev:
LOCATION PLAN / SITE ANALYSIS	782DA_A_	02 E



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Nominated Architect Boris Dragas NSW ARB #7658
t: 0414 866 065 e: boris@studiobd.com.au SUE

w: studiobd.com.au abn: 74 219 560 787

SUBDIVISION PLAN

Job No:

782DA_A_

Drawing No:

08

Revisions:

Revised Development Application Issue


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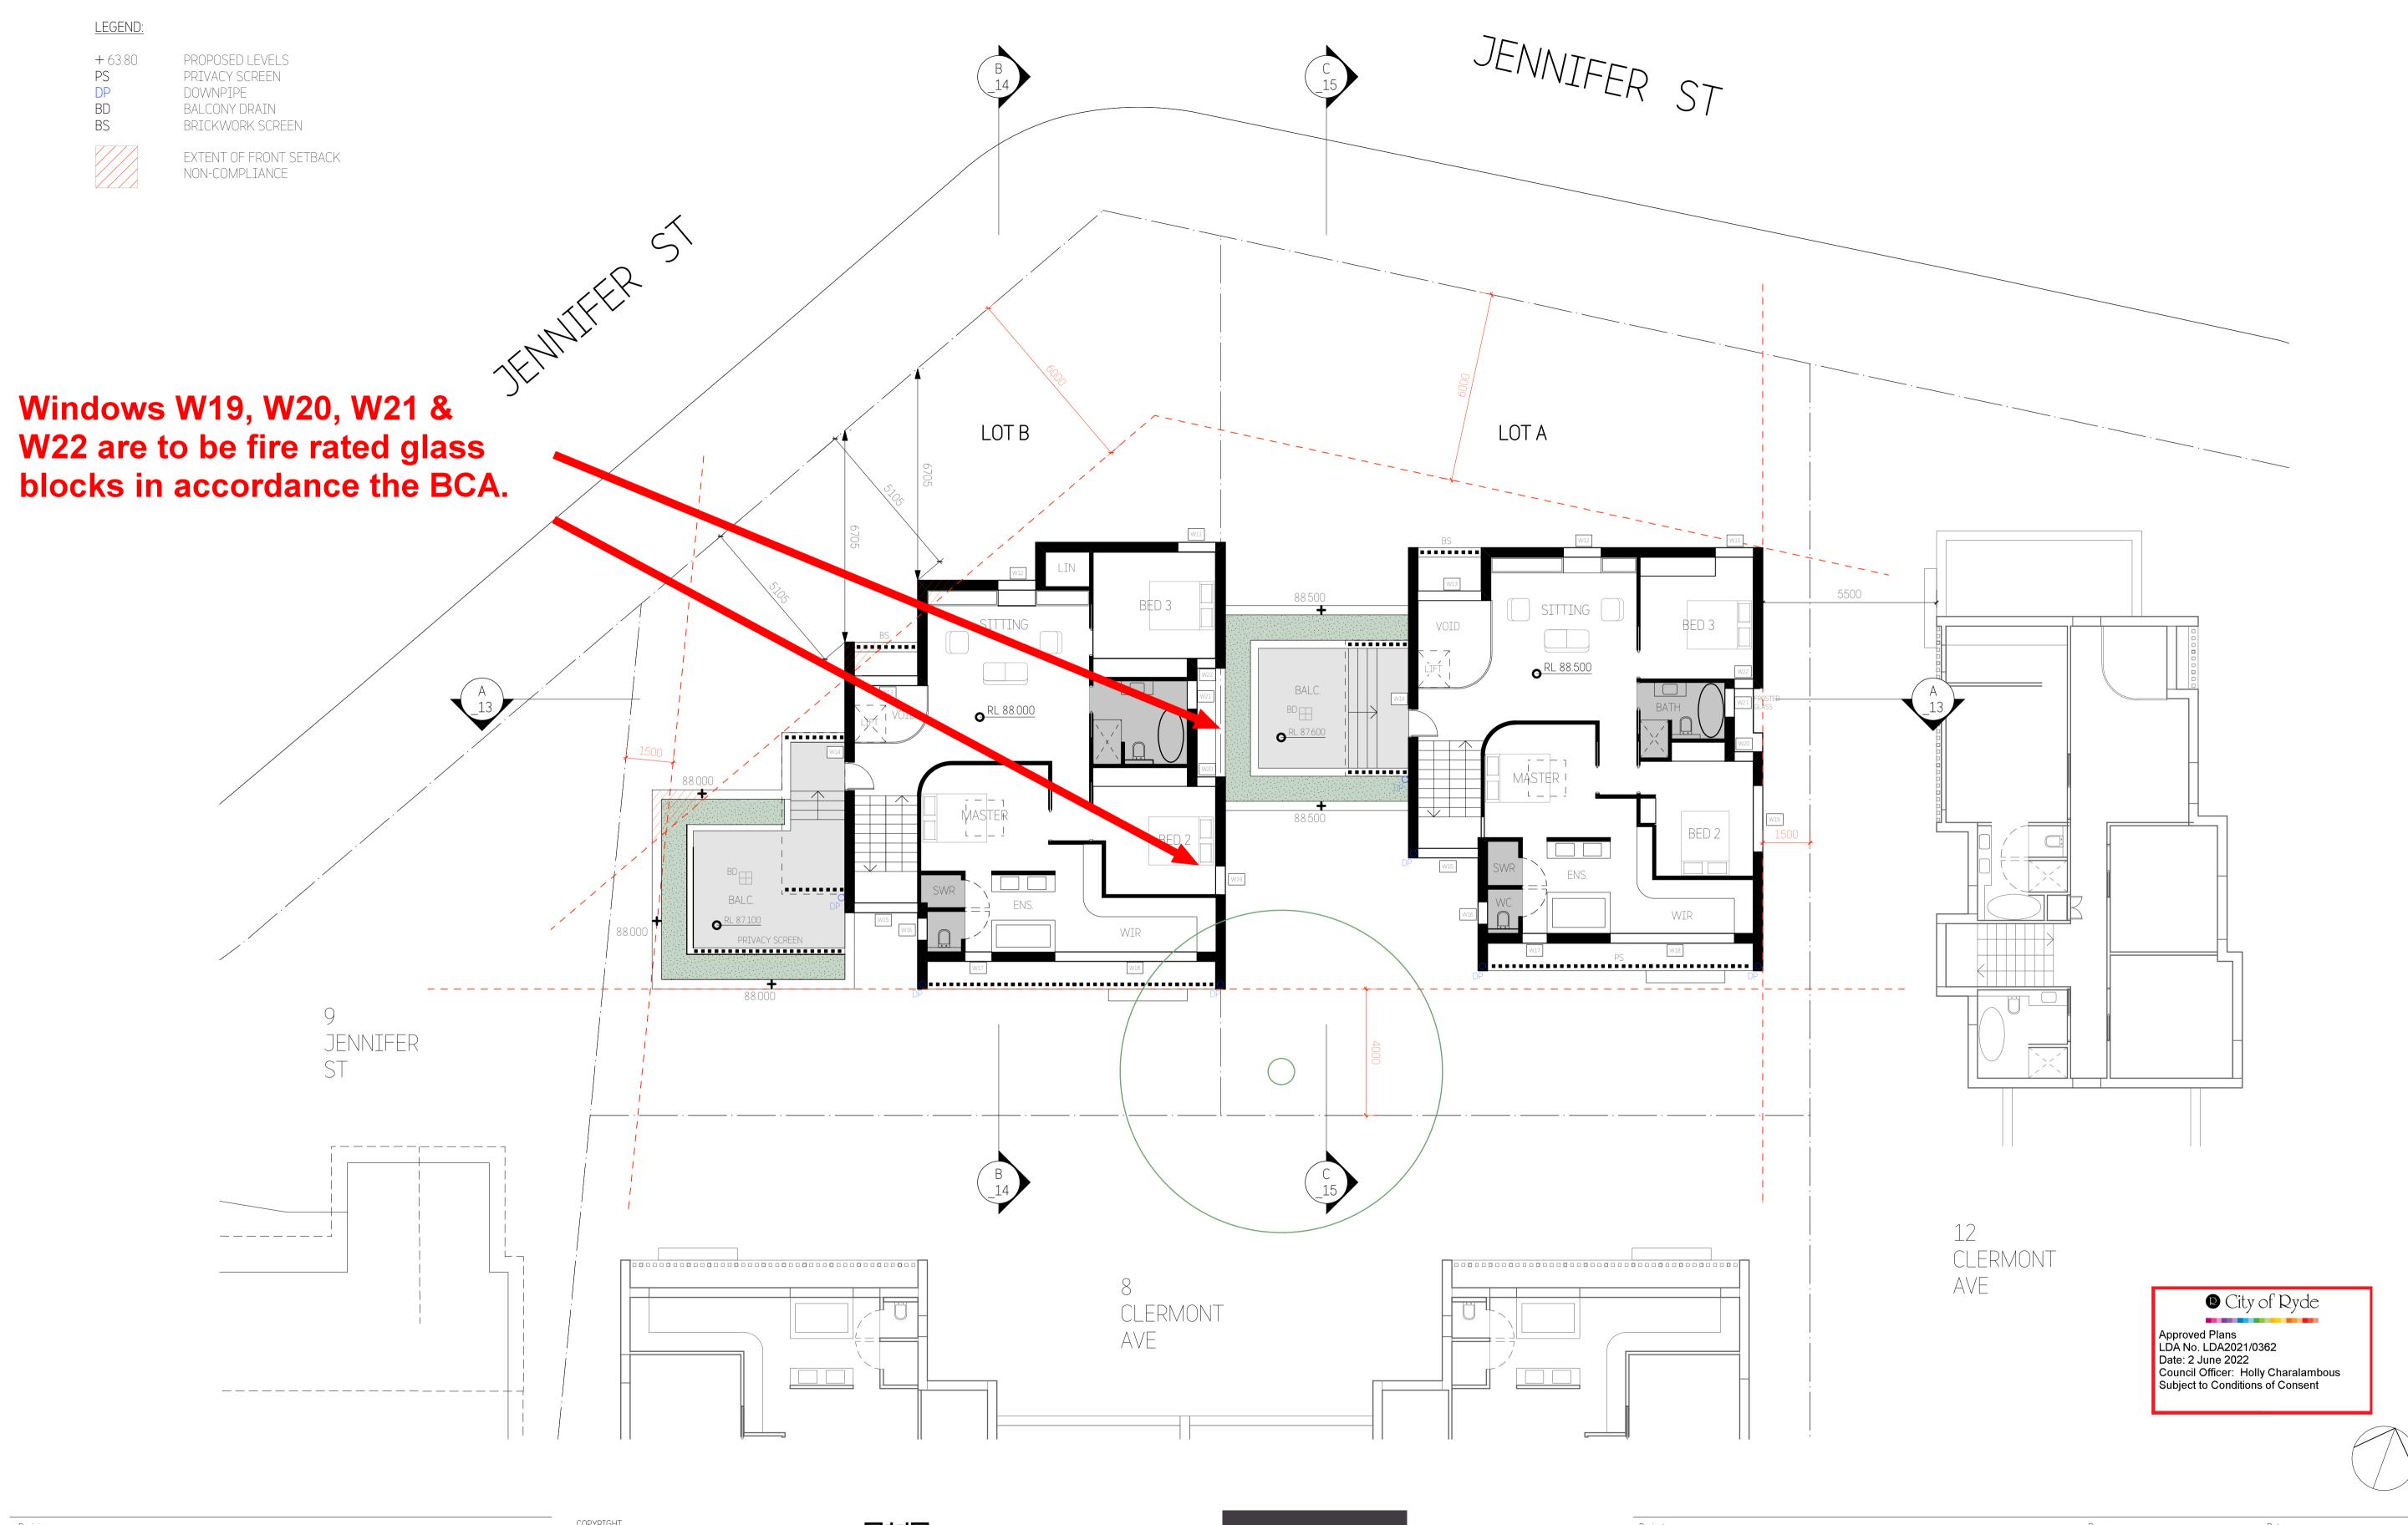
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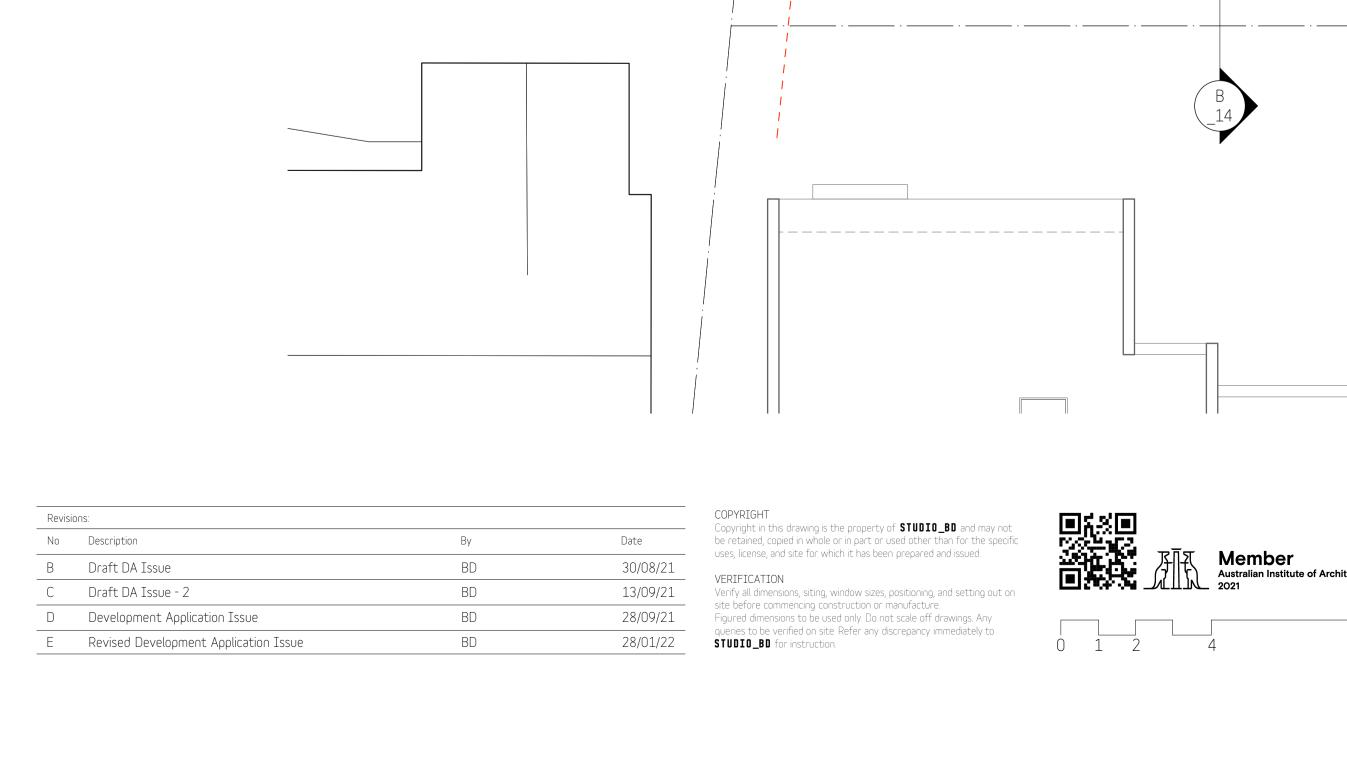
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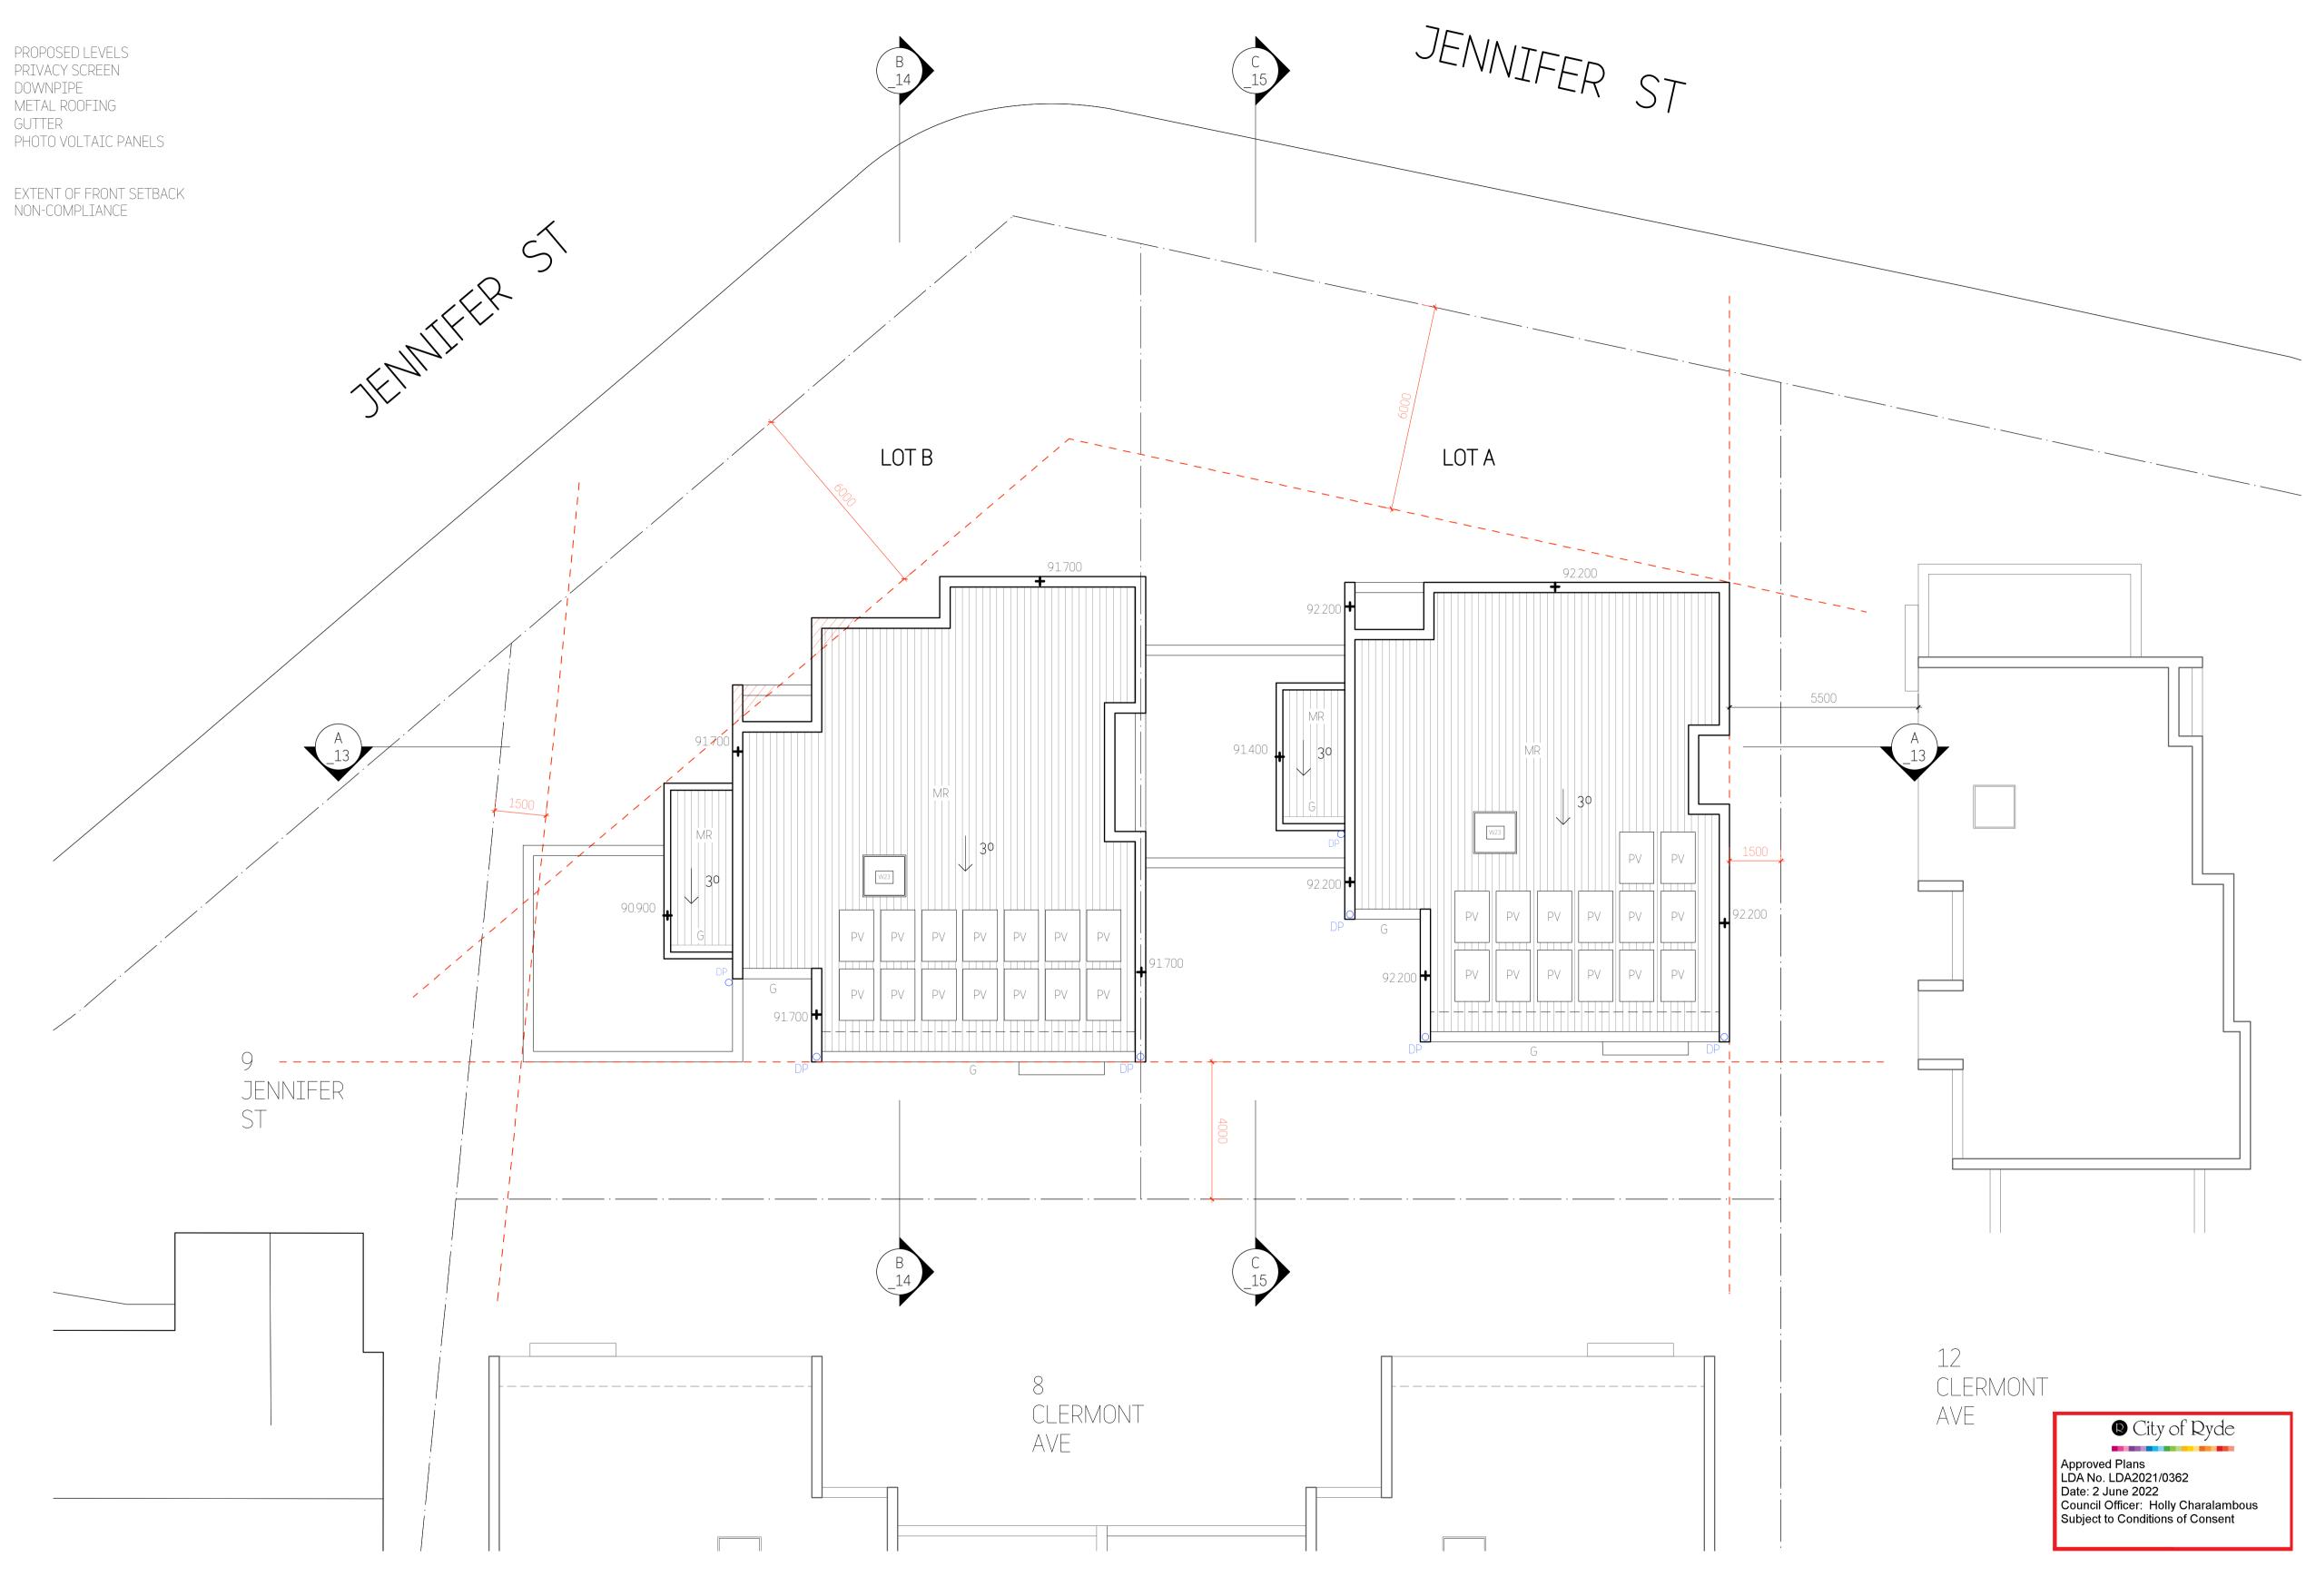



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r: studiobd.com.au an: 74 219 560 78	~

Project:	Drawn: BD	Date: 20/07/21	
10 JENNIFER ST, RYDE		Scale: 1:200@A3 1:100@A1	
	Checked: BD	Sheet Size: A3/A1	
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ROOF PLAN	782DA_A_	07 E	



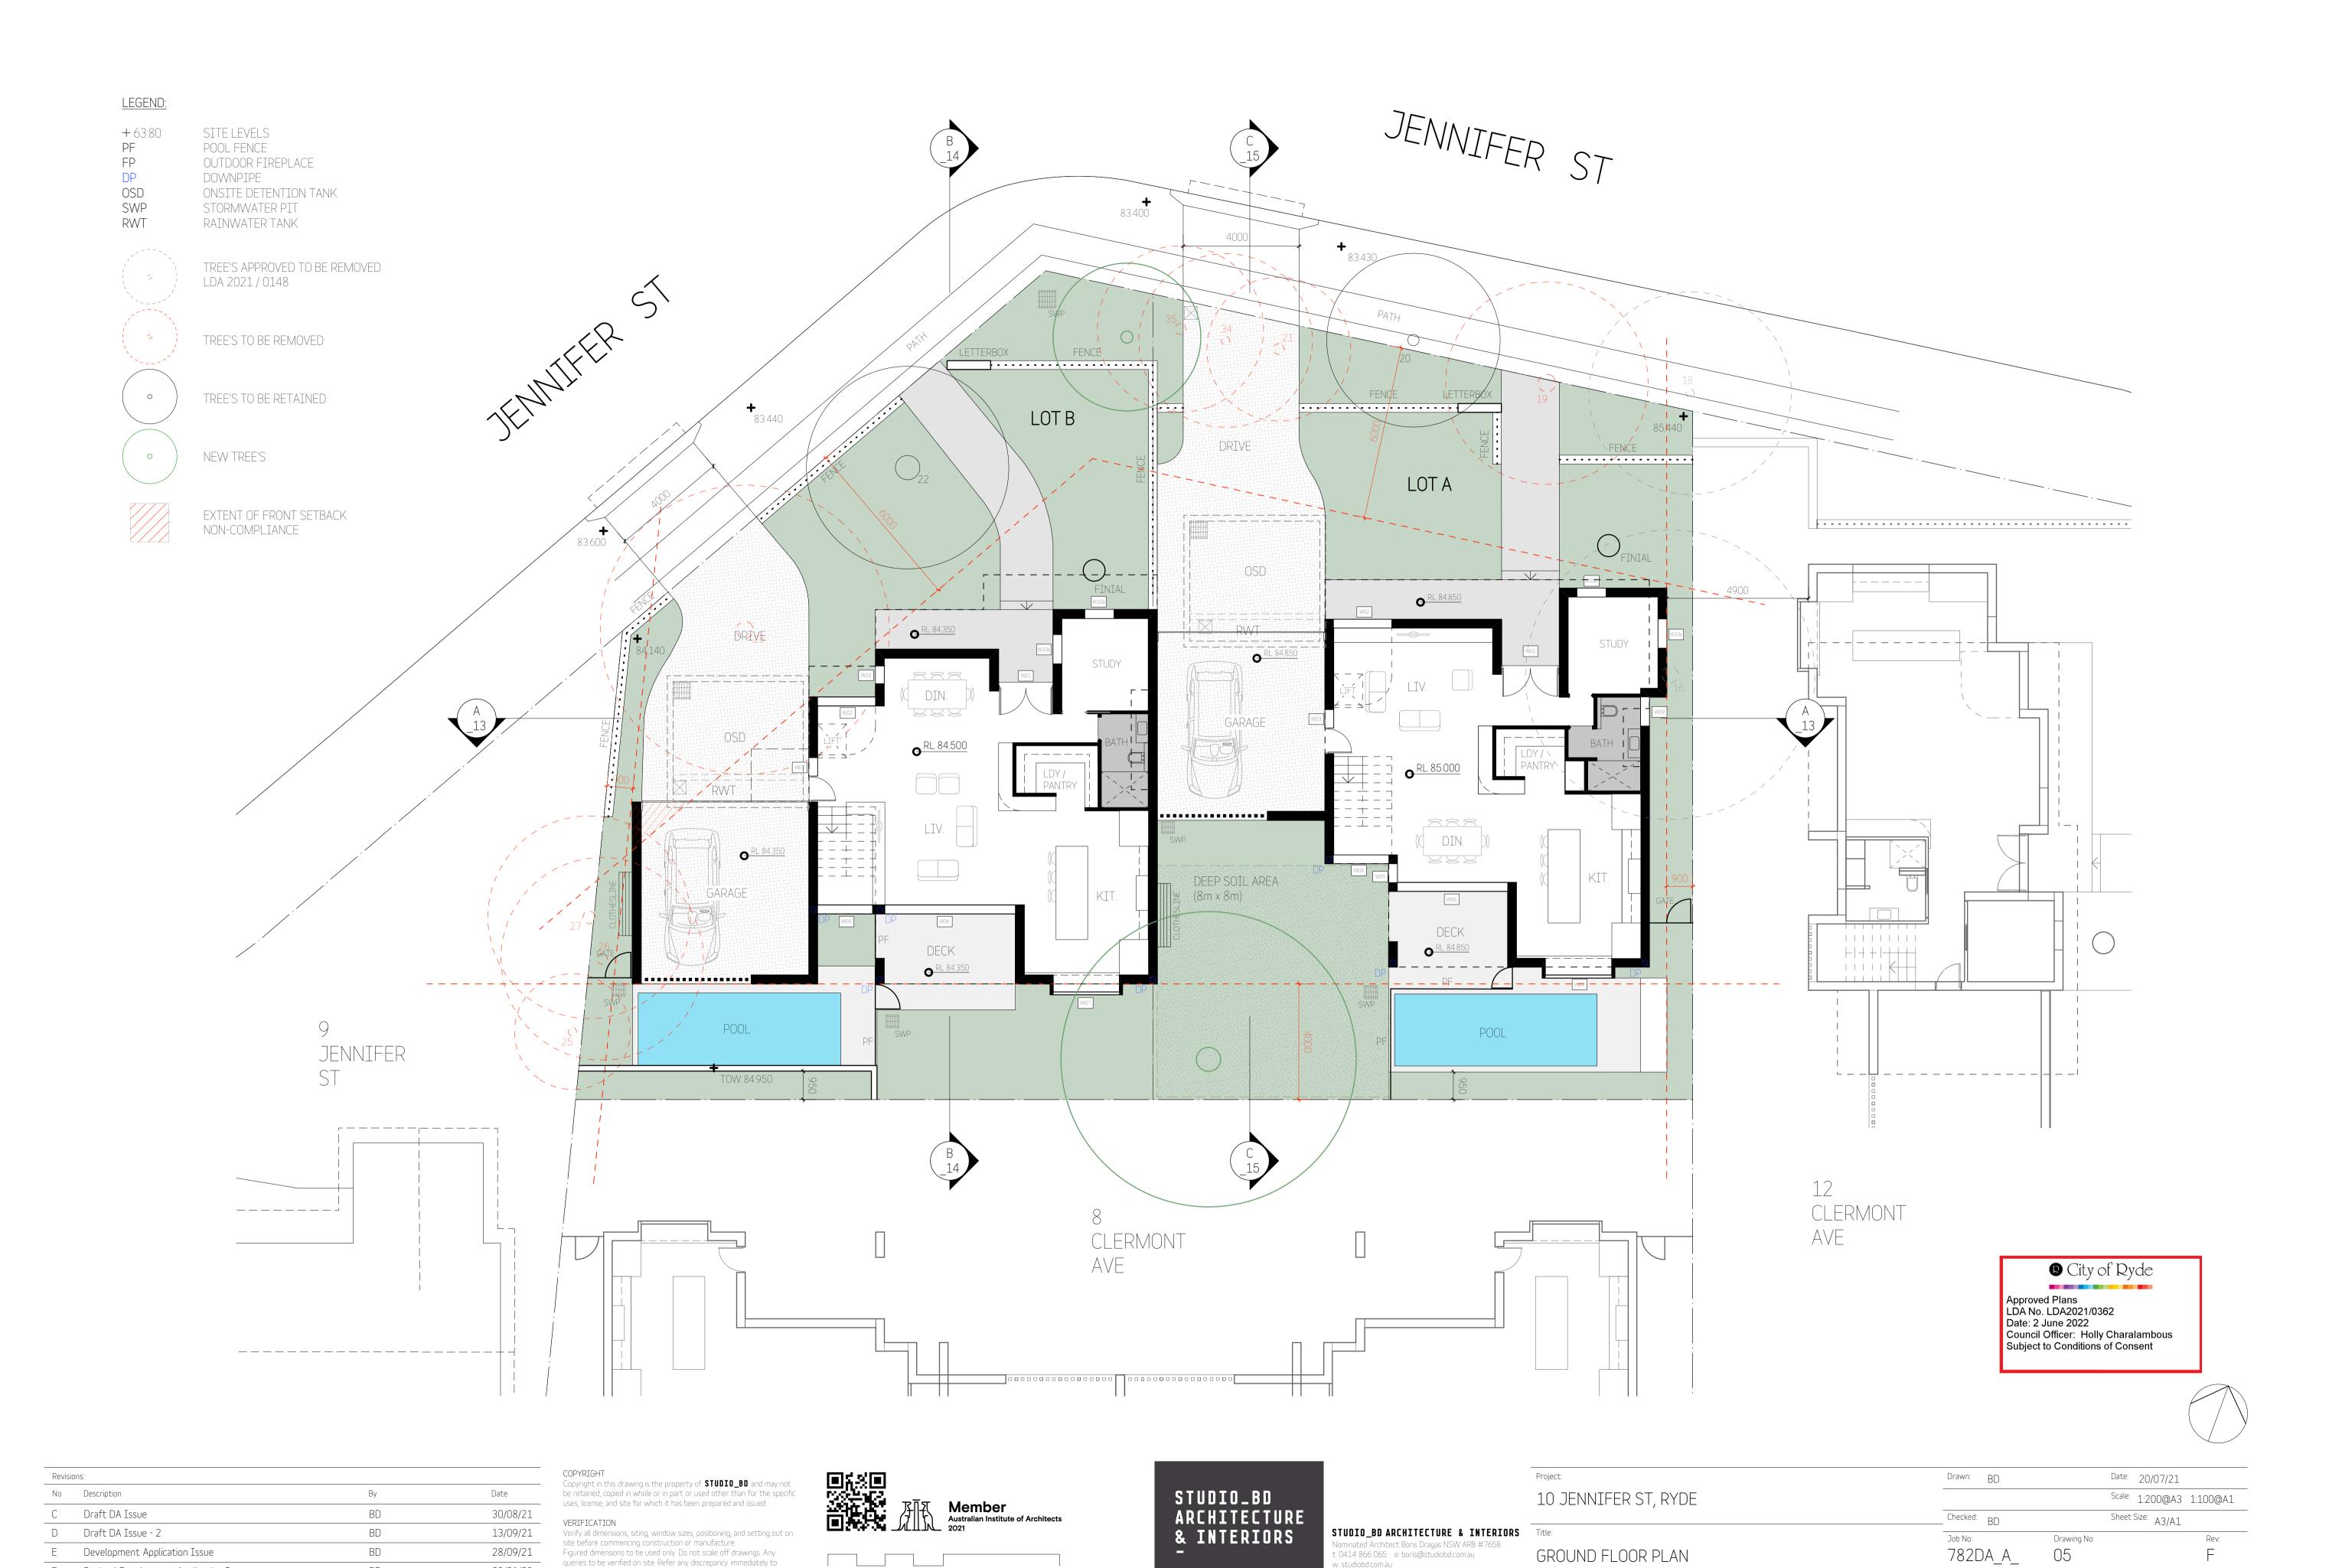

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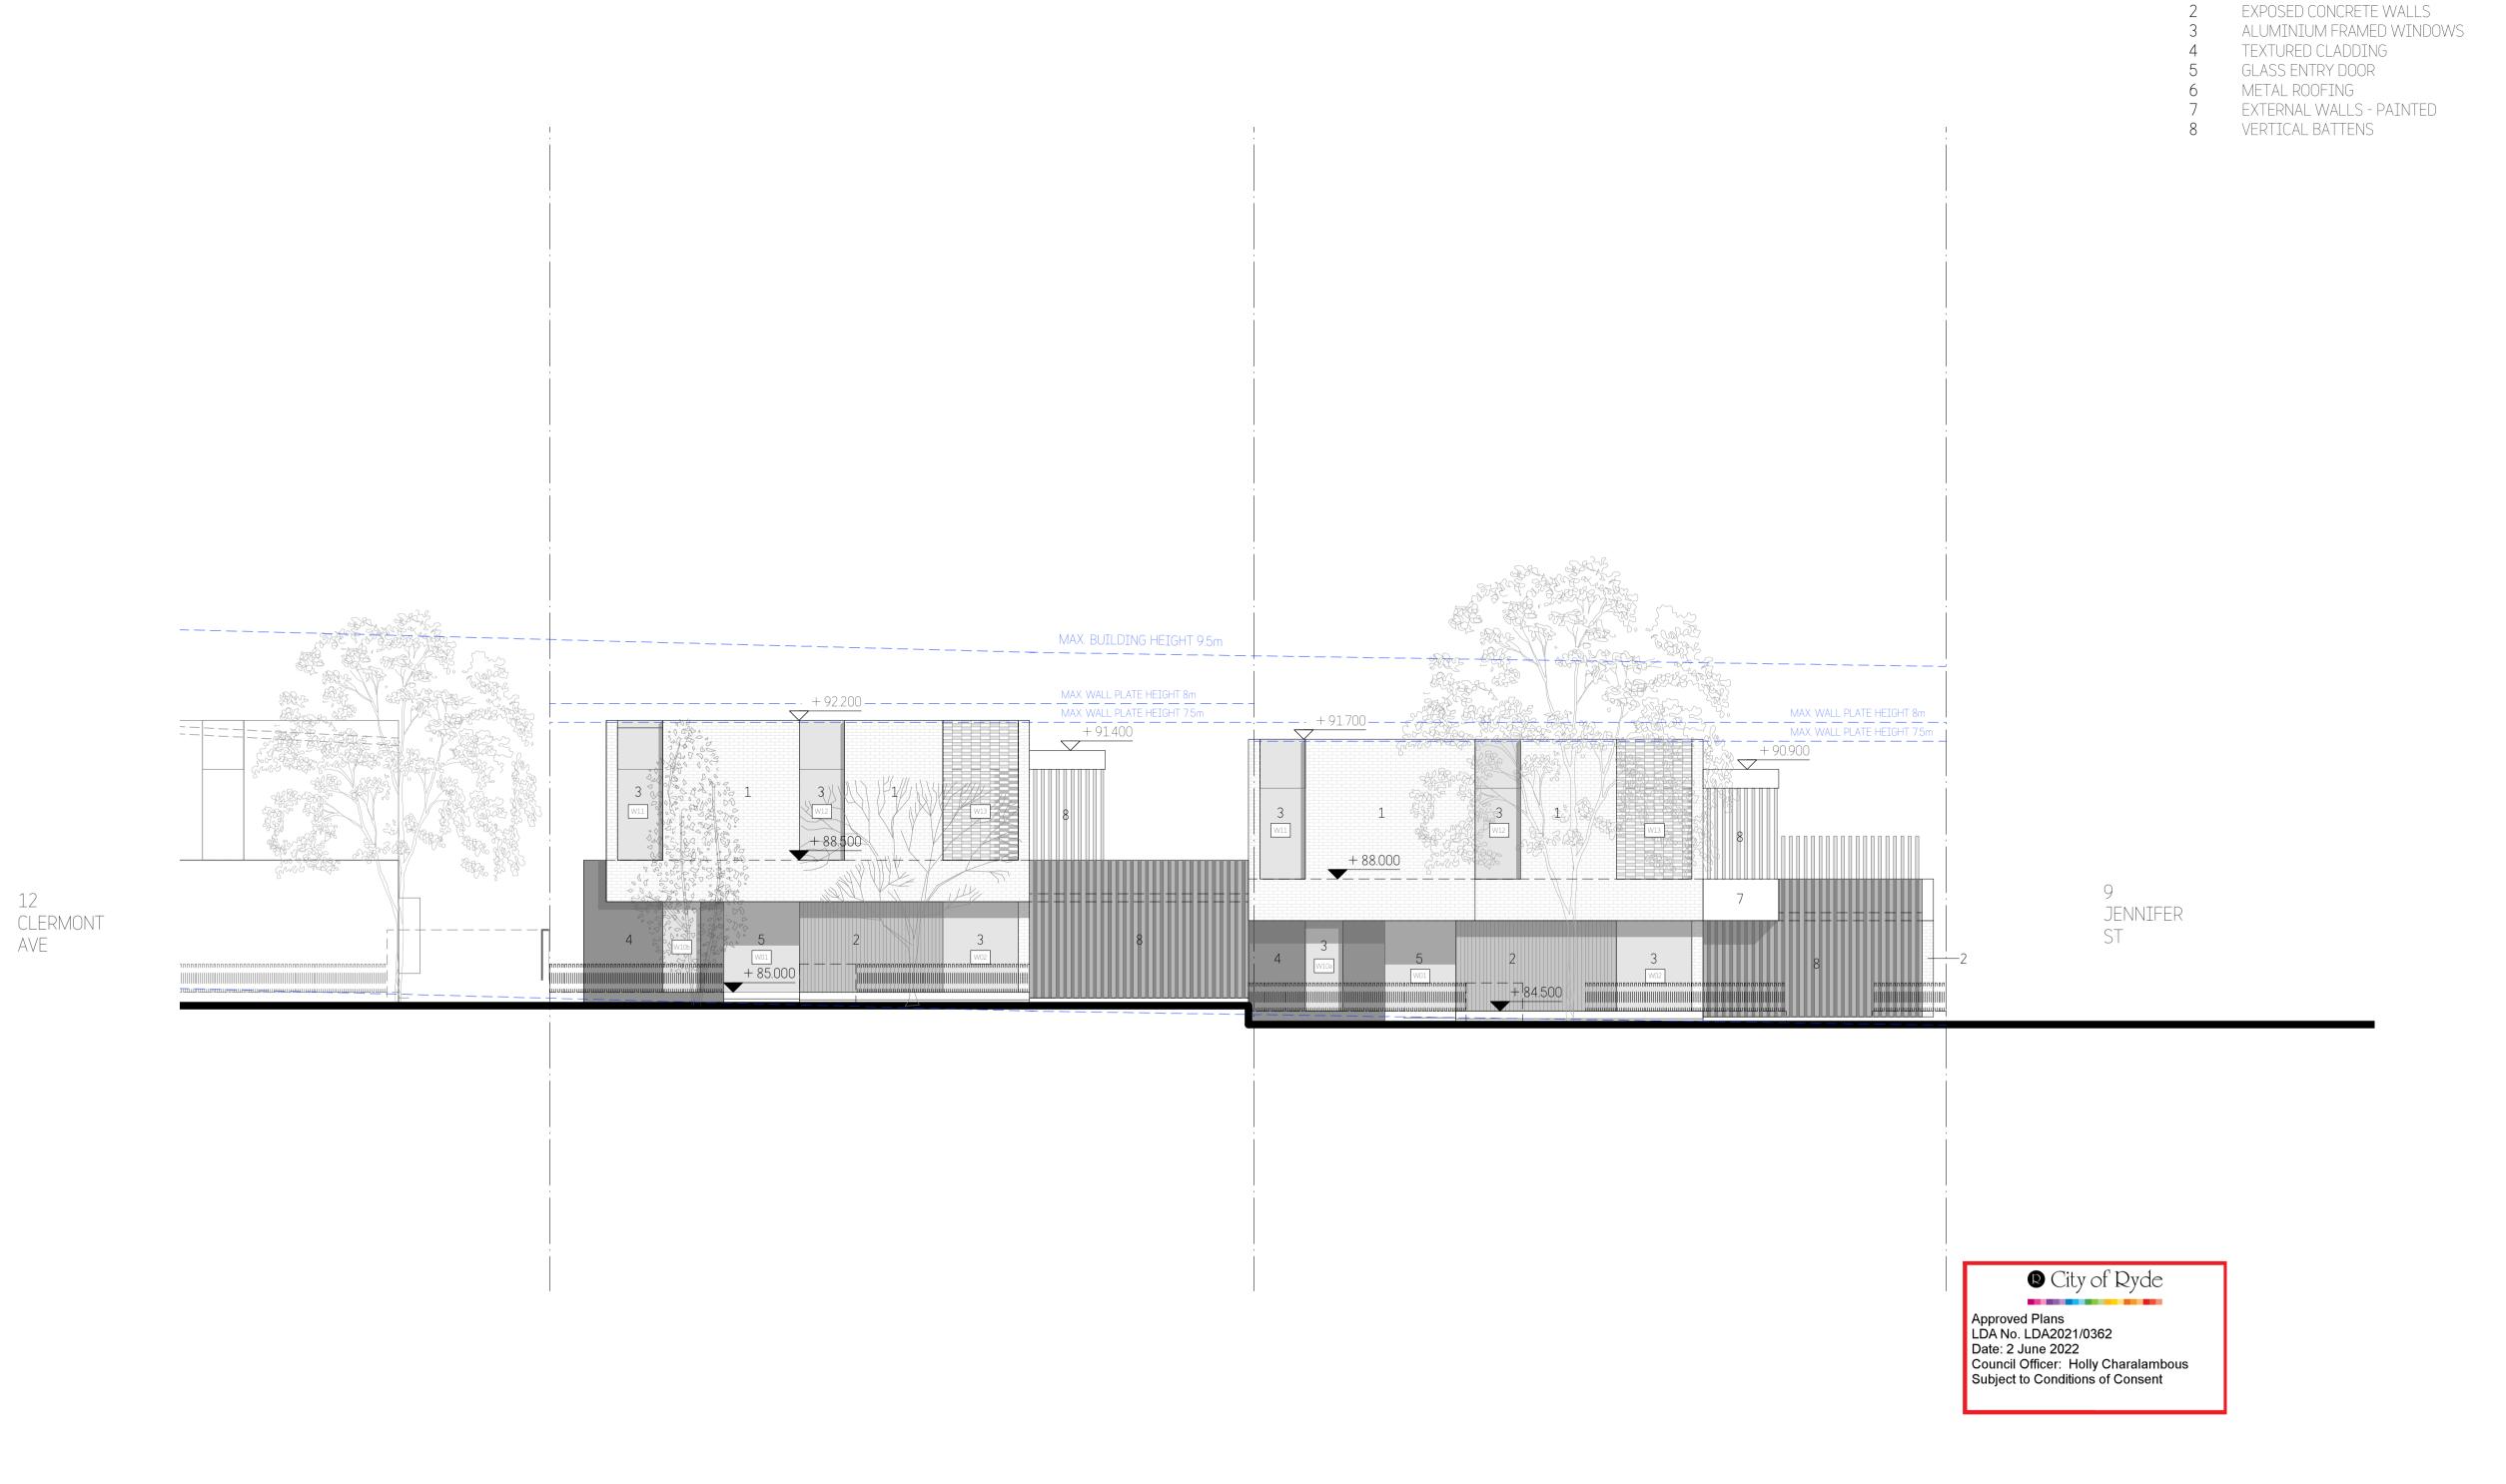
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NORTH ELEVATION	782DA_A_	09	D

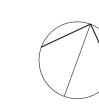MATERIALS LEGEND:

Refer to External Finishes Schedule

1 BRICKWORKS WALLS - PAINTED



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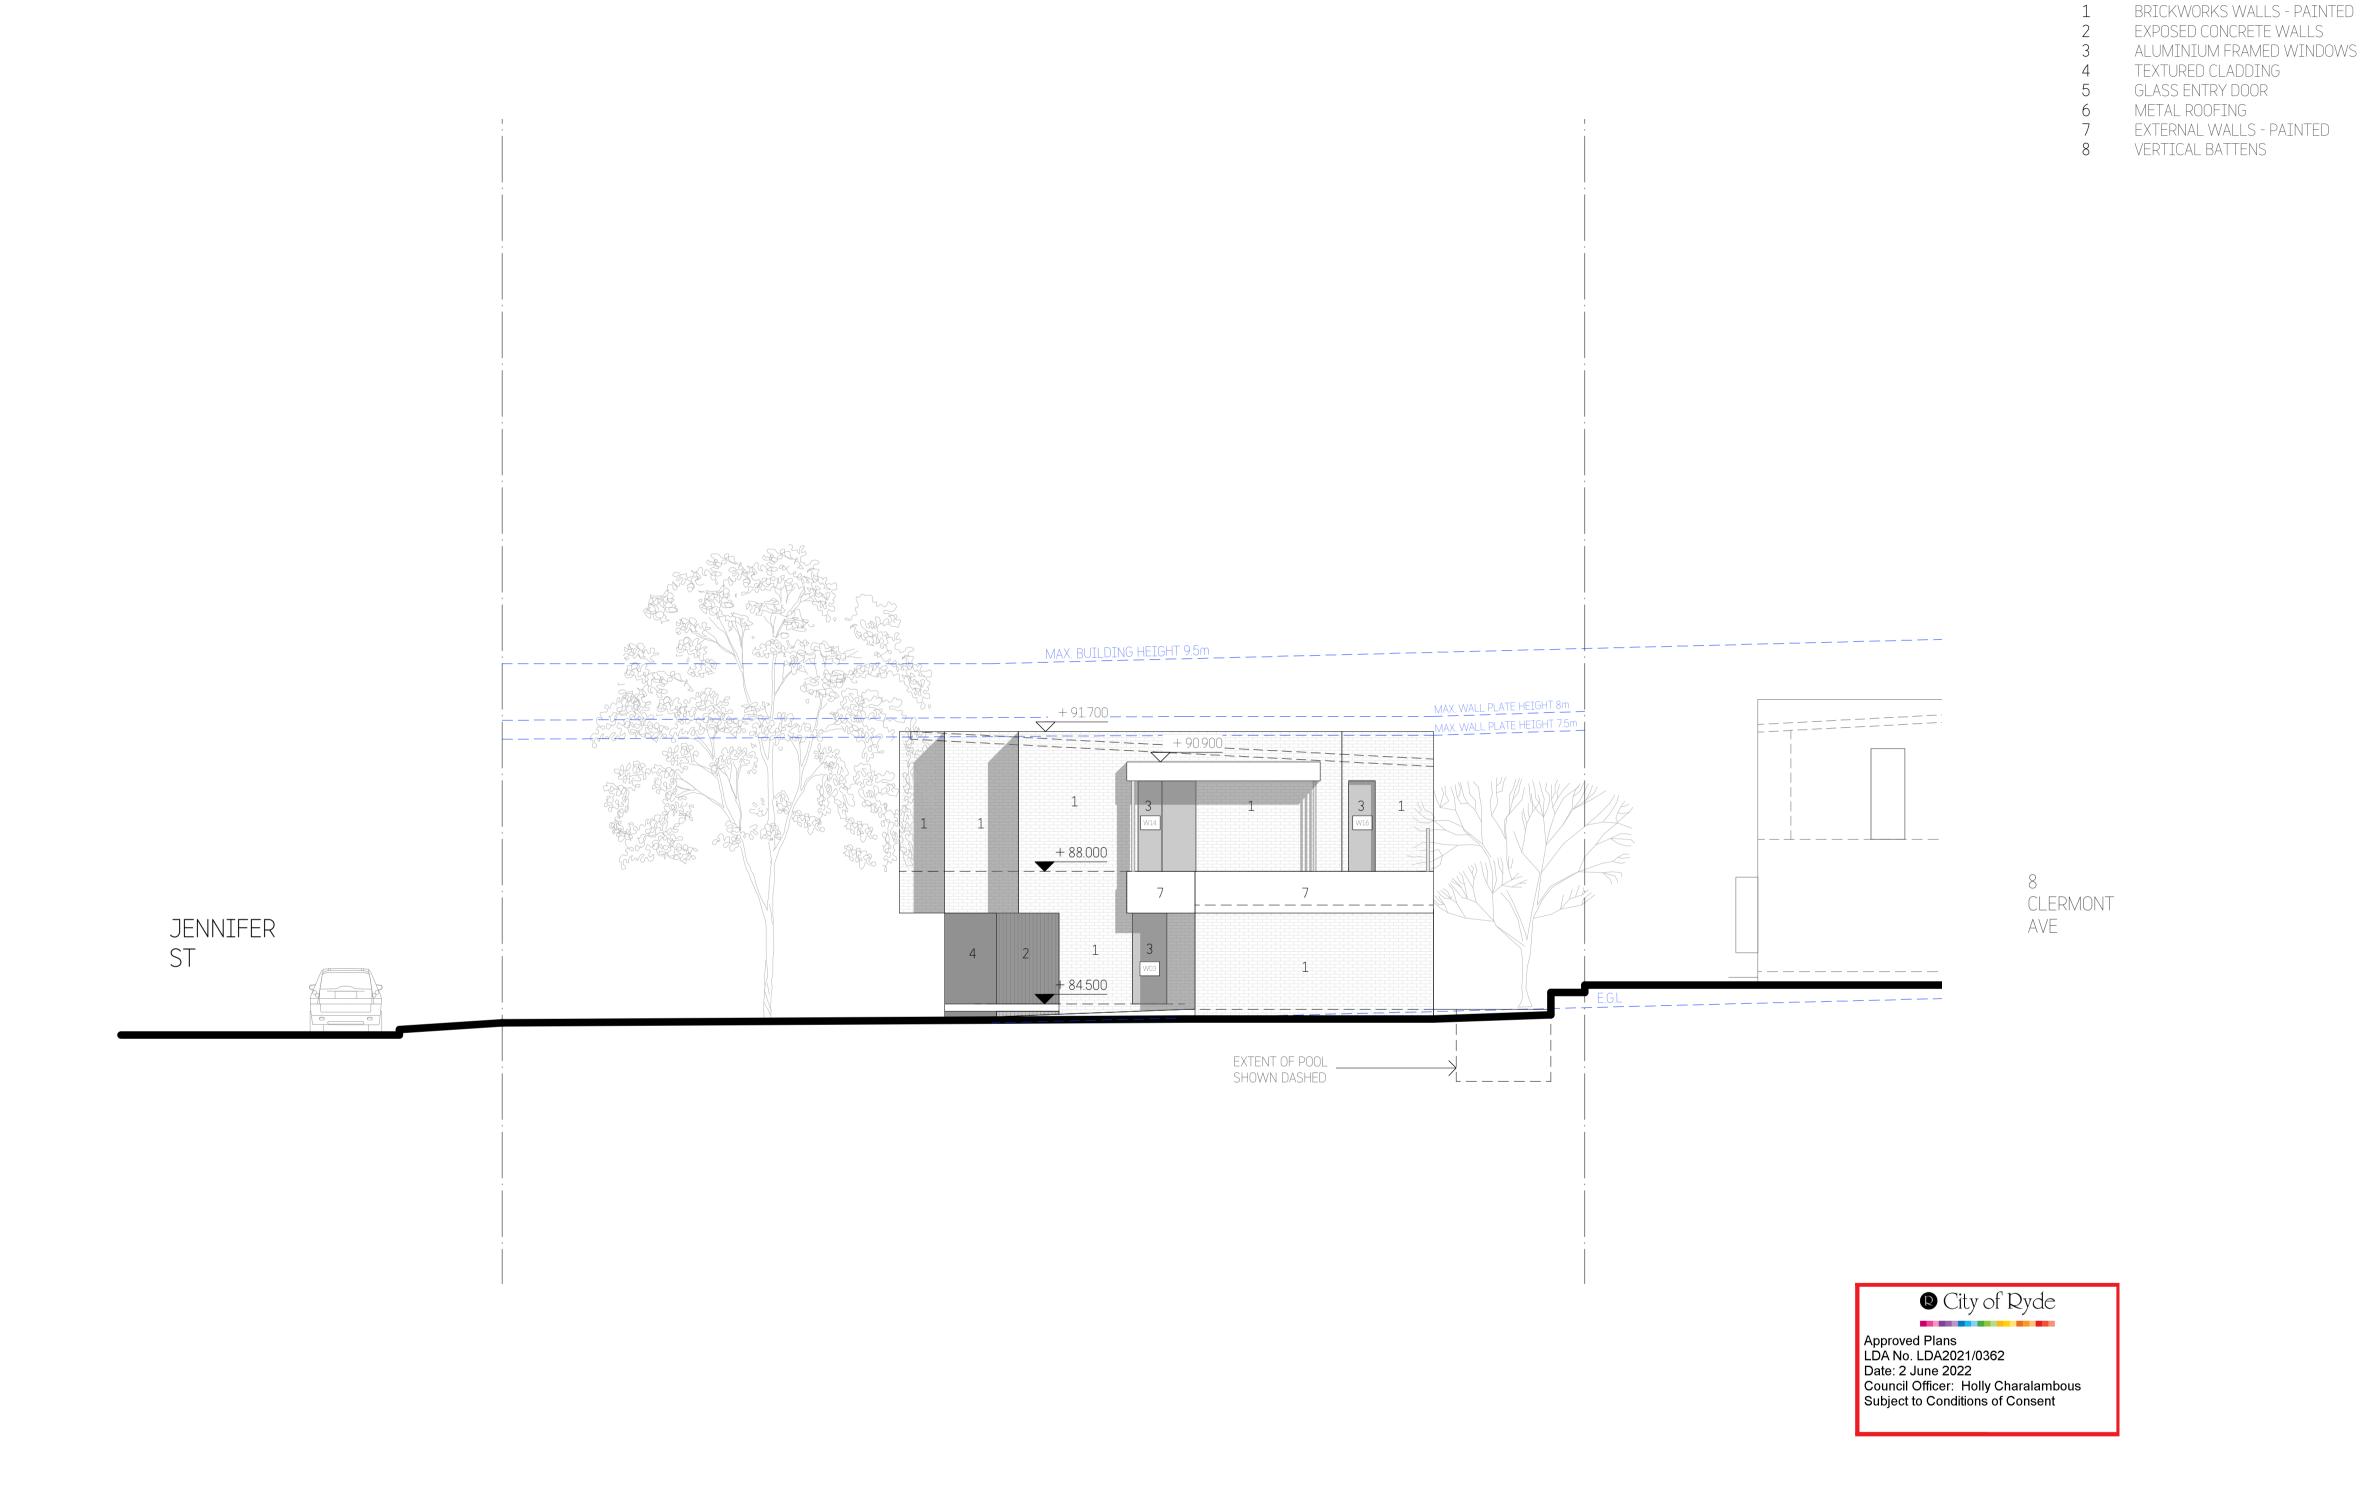


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10 JENNIFER ST, RYDE		Scale: 1:2	200@A3 1:100@A1
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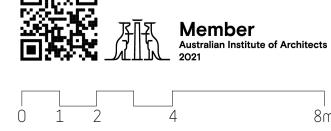
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	SOUTH ELEVATION	782DA_A_	11	D

MATERIALS LEGEND:

Refer to External Finishes Schedule




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	10 JENNIFER ST, RYDE				Scale: 1:200@A3	1:100@A1
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IORS ?	Title:	Job No:		Drawing No:		Rev:
,	EAST ELEVATION	7820)A_A_	12		D




MATERIALS LEGEND: Refer to External Finishes Schedule

- BRICKWORKS WALLS PAINTED
- 2 EXPOSED CONCRETE WALLS
 - ALUMINIUM FRAMED WINDOWS
- TEXTURED CLADDING
- GLASS ENTRY DOOR
- METAL ROOFING
- EXTERNAL WALLS PAINTED
- VERTICAL BATTENS

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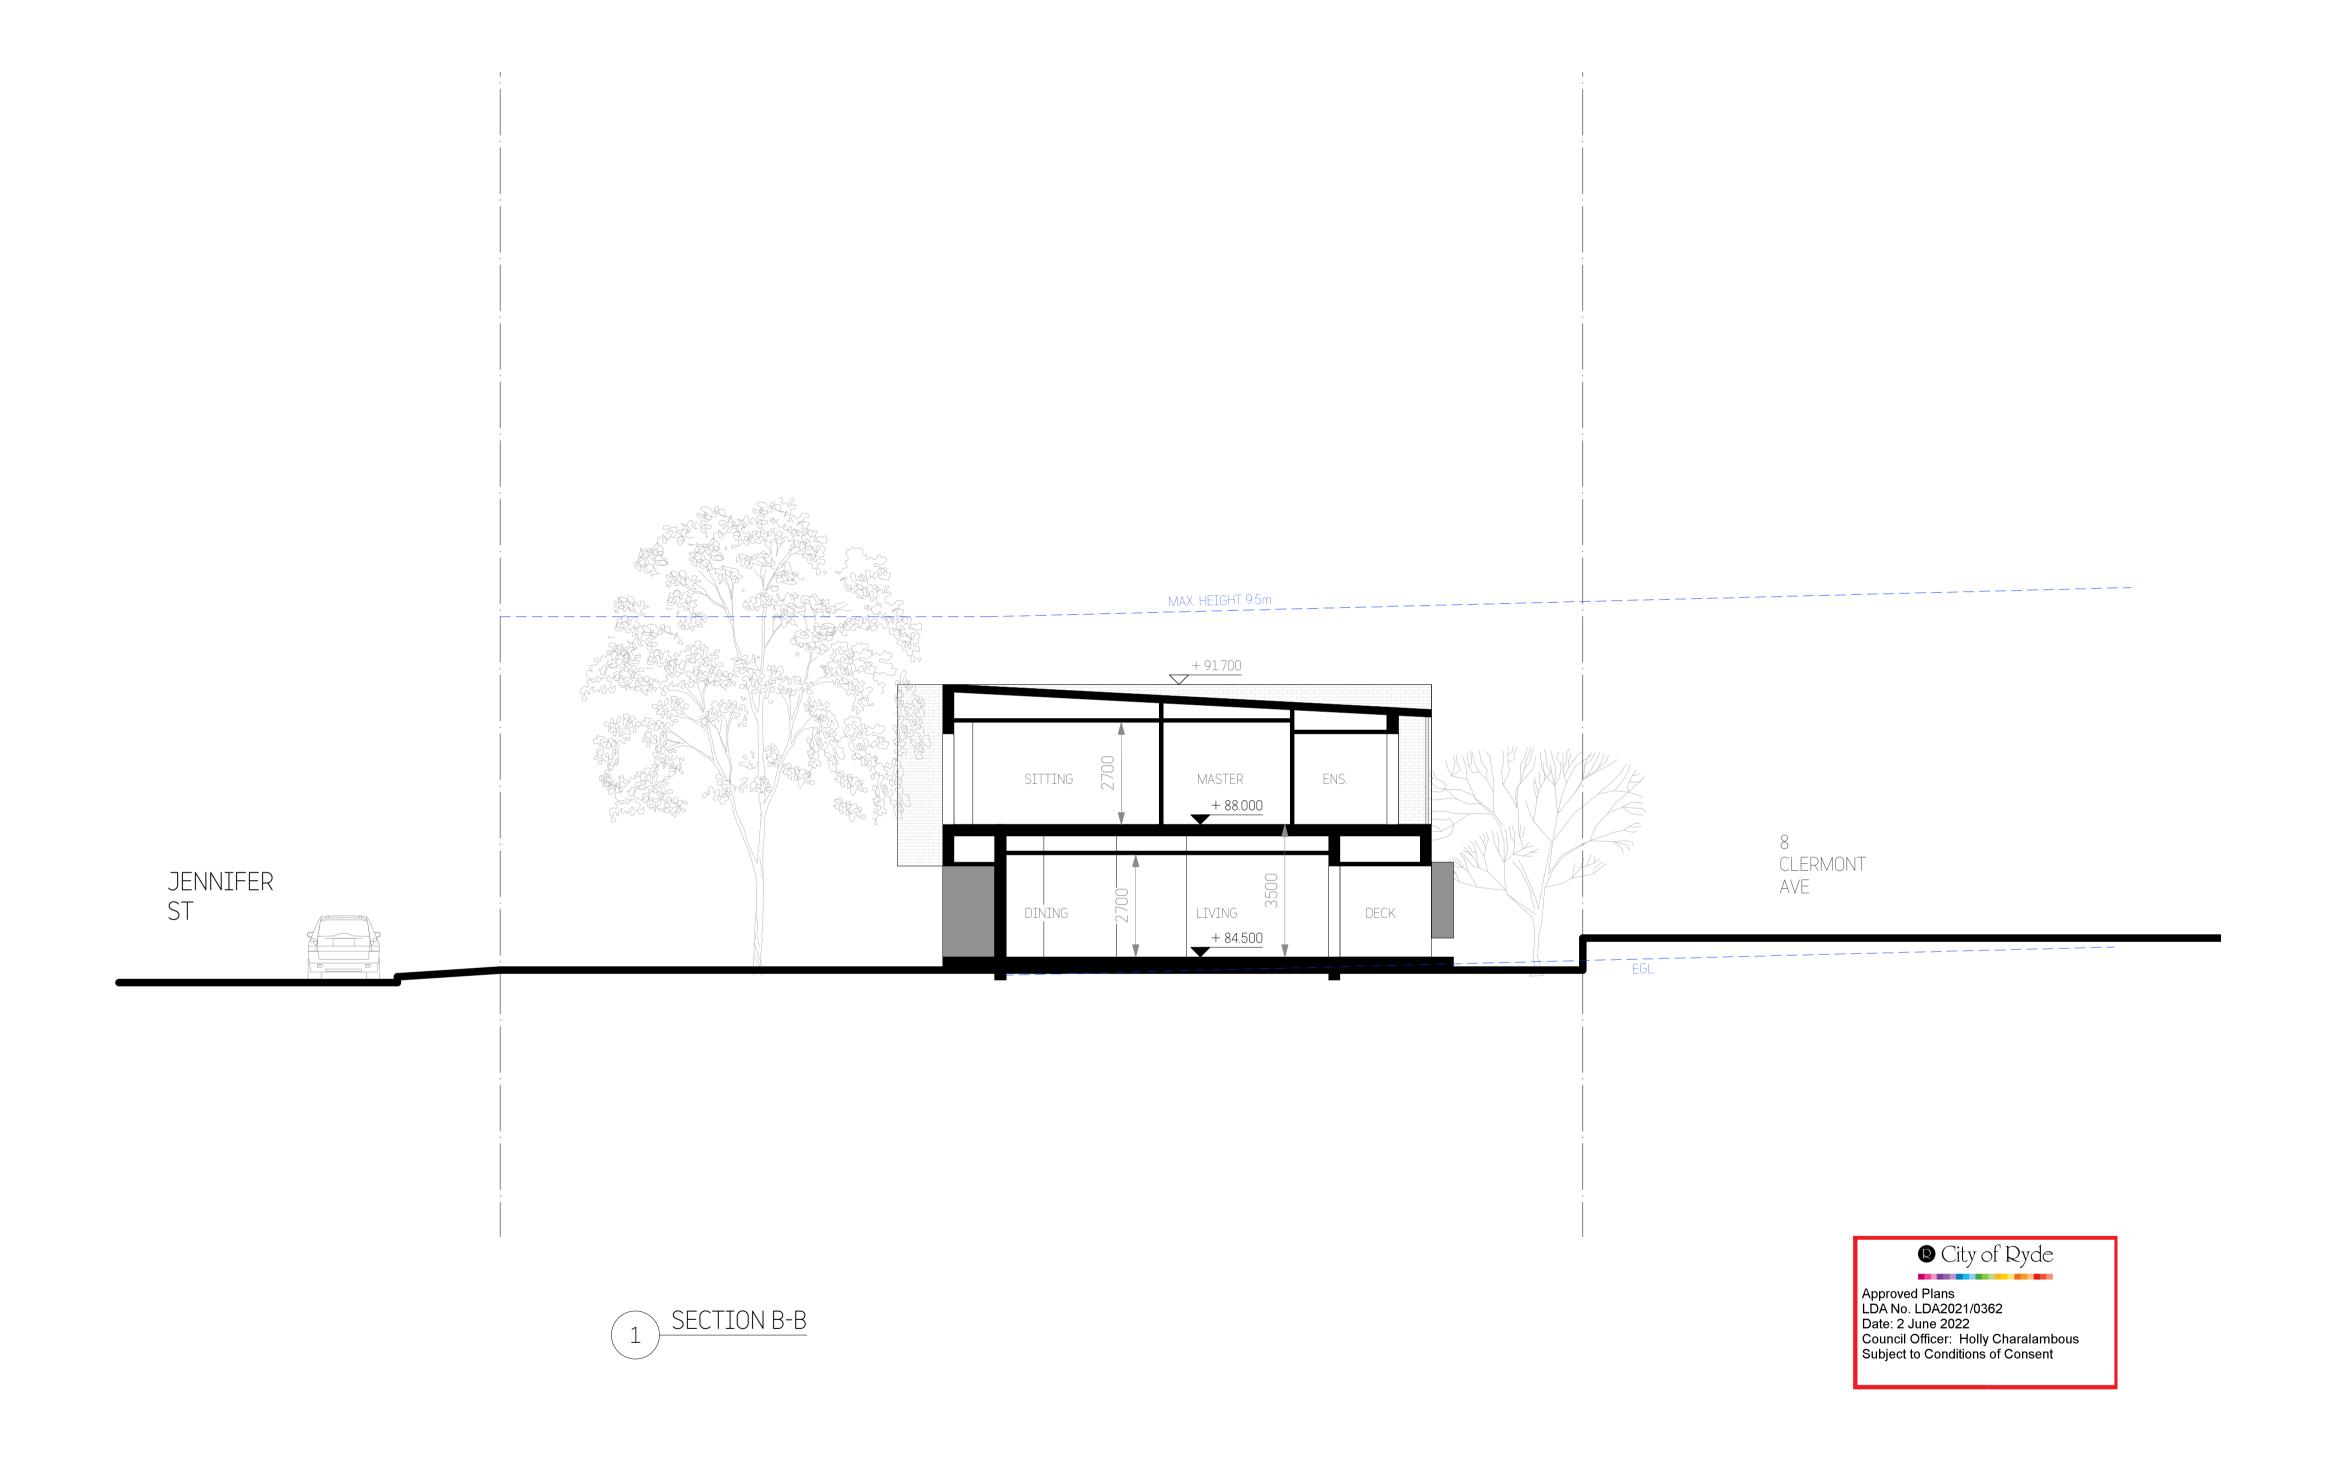


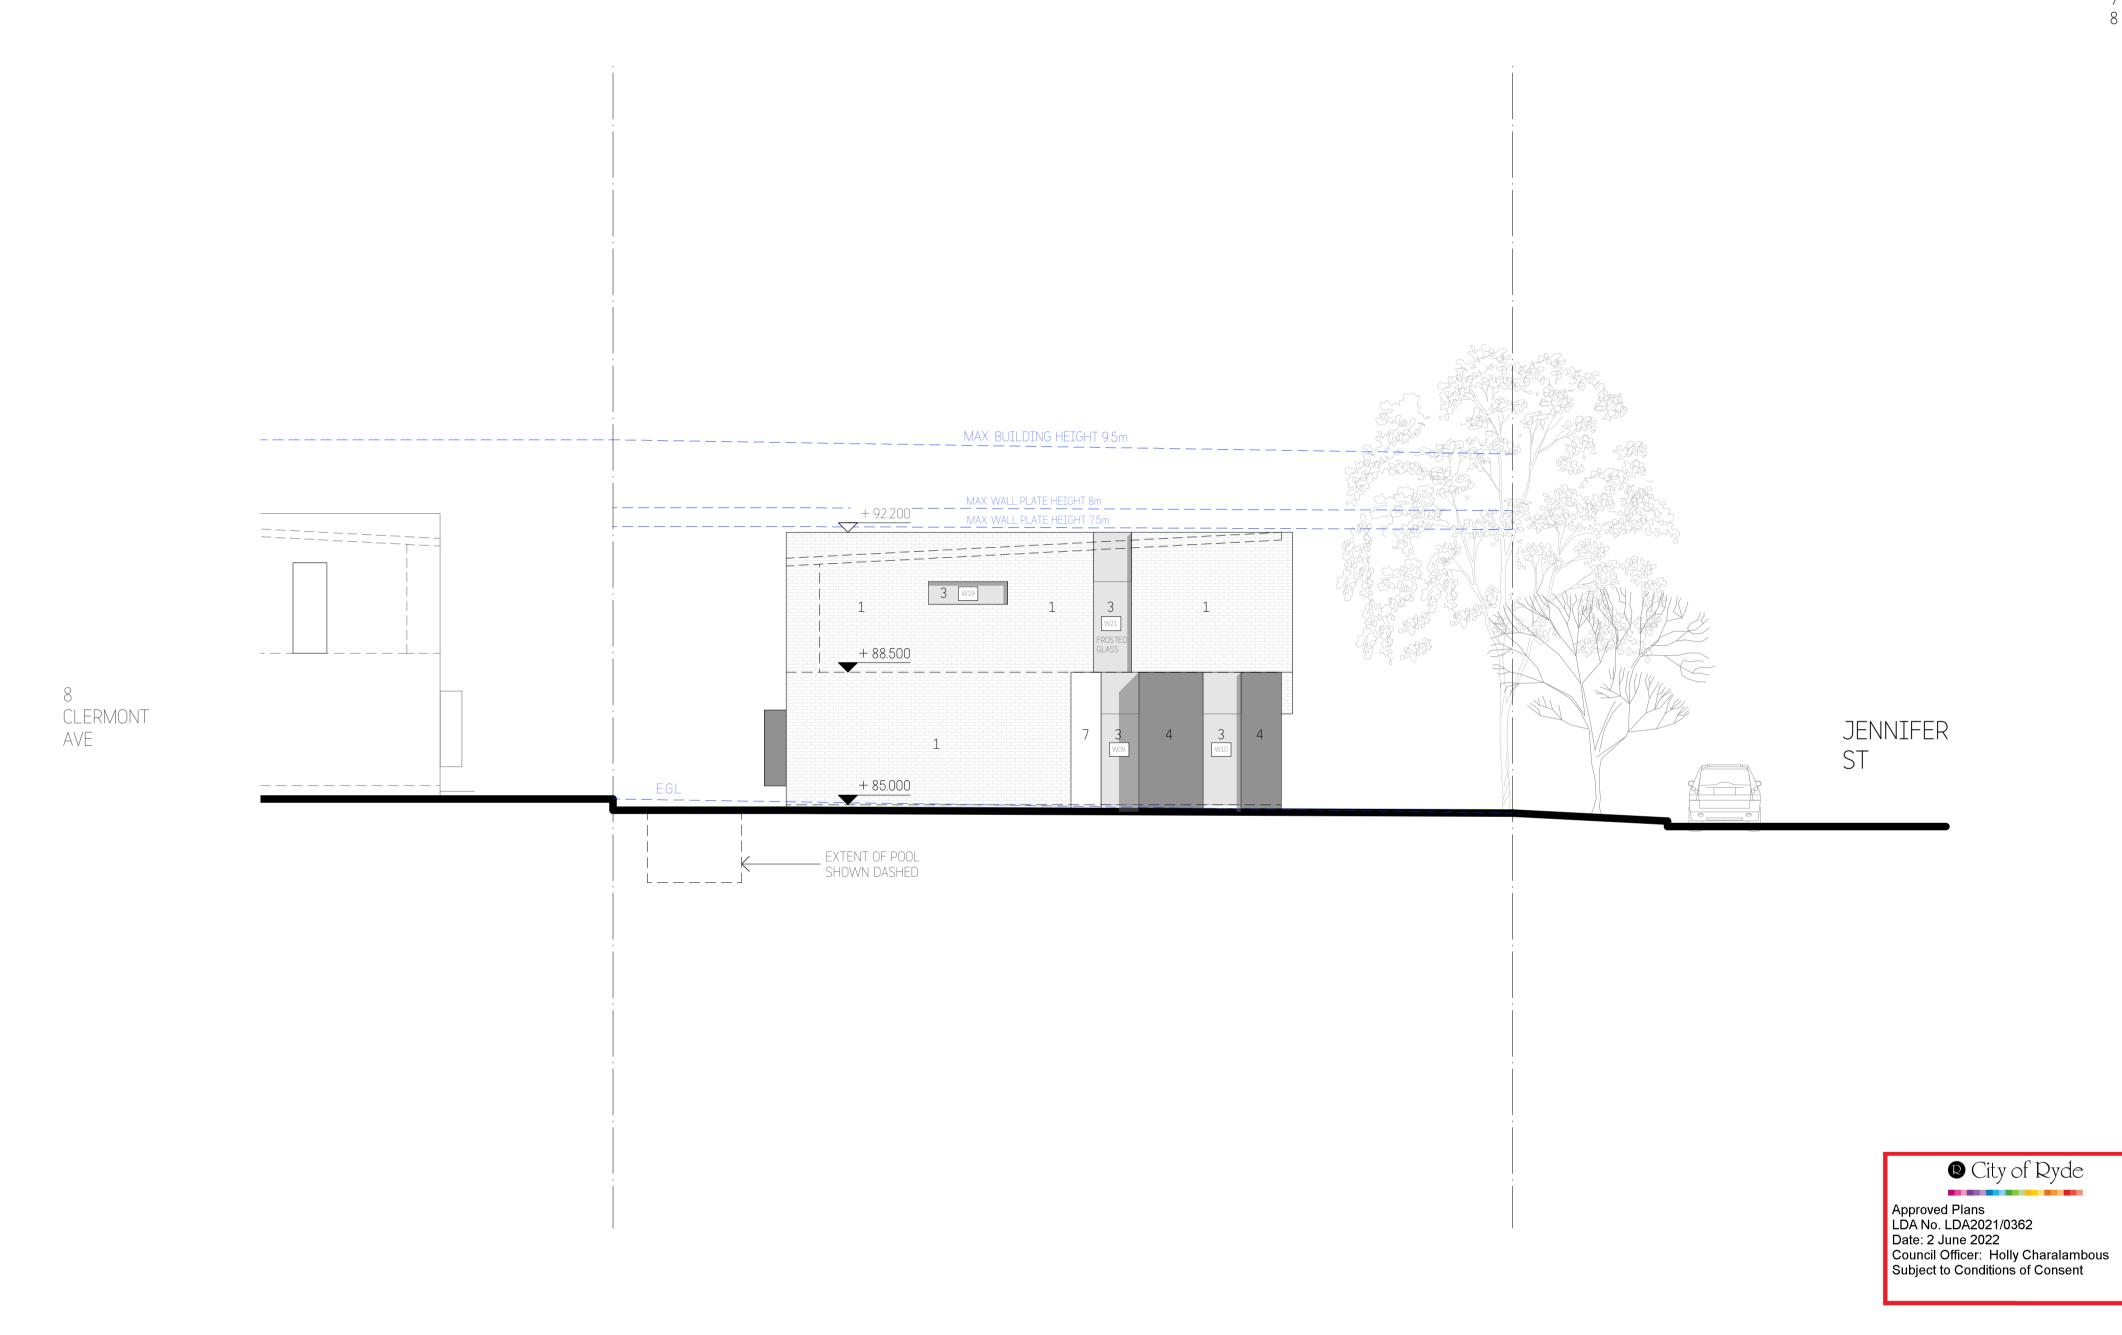STUDIO_BD ARCHITECTURE & INTERIORS Title:

Nominated Architect Boris Dragas NSW ARB #7658

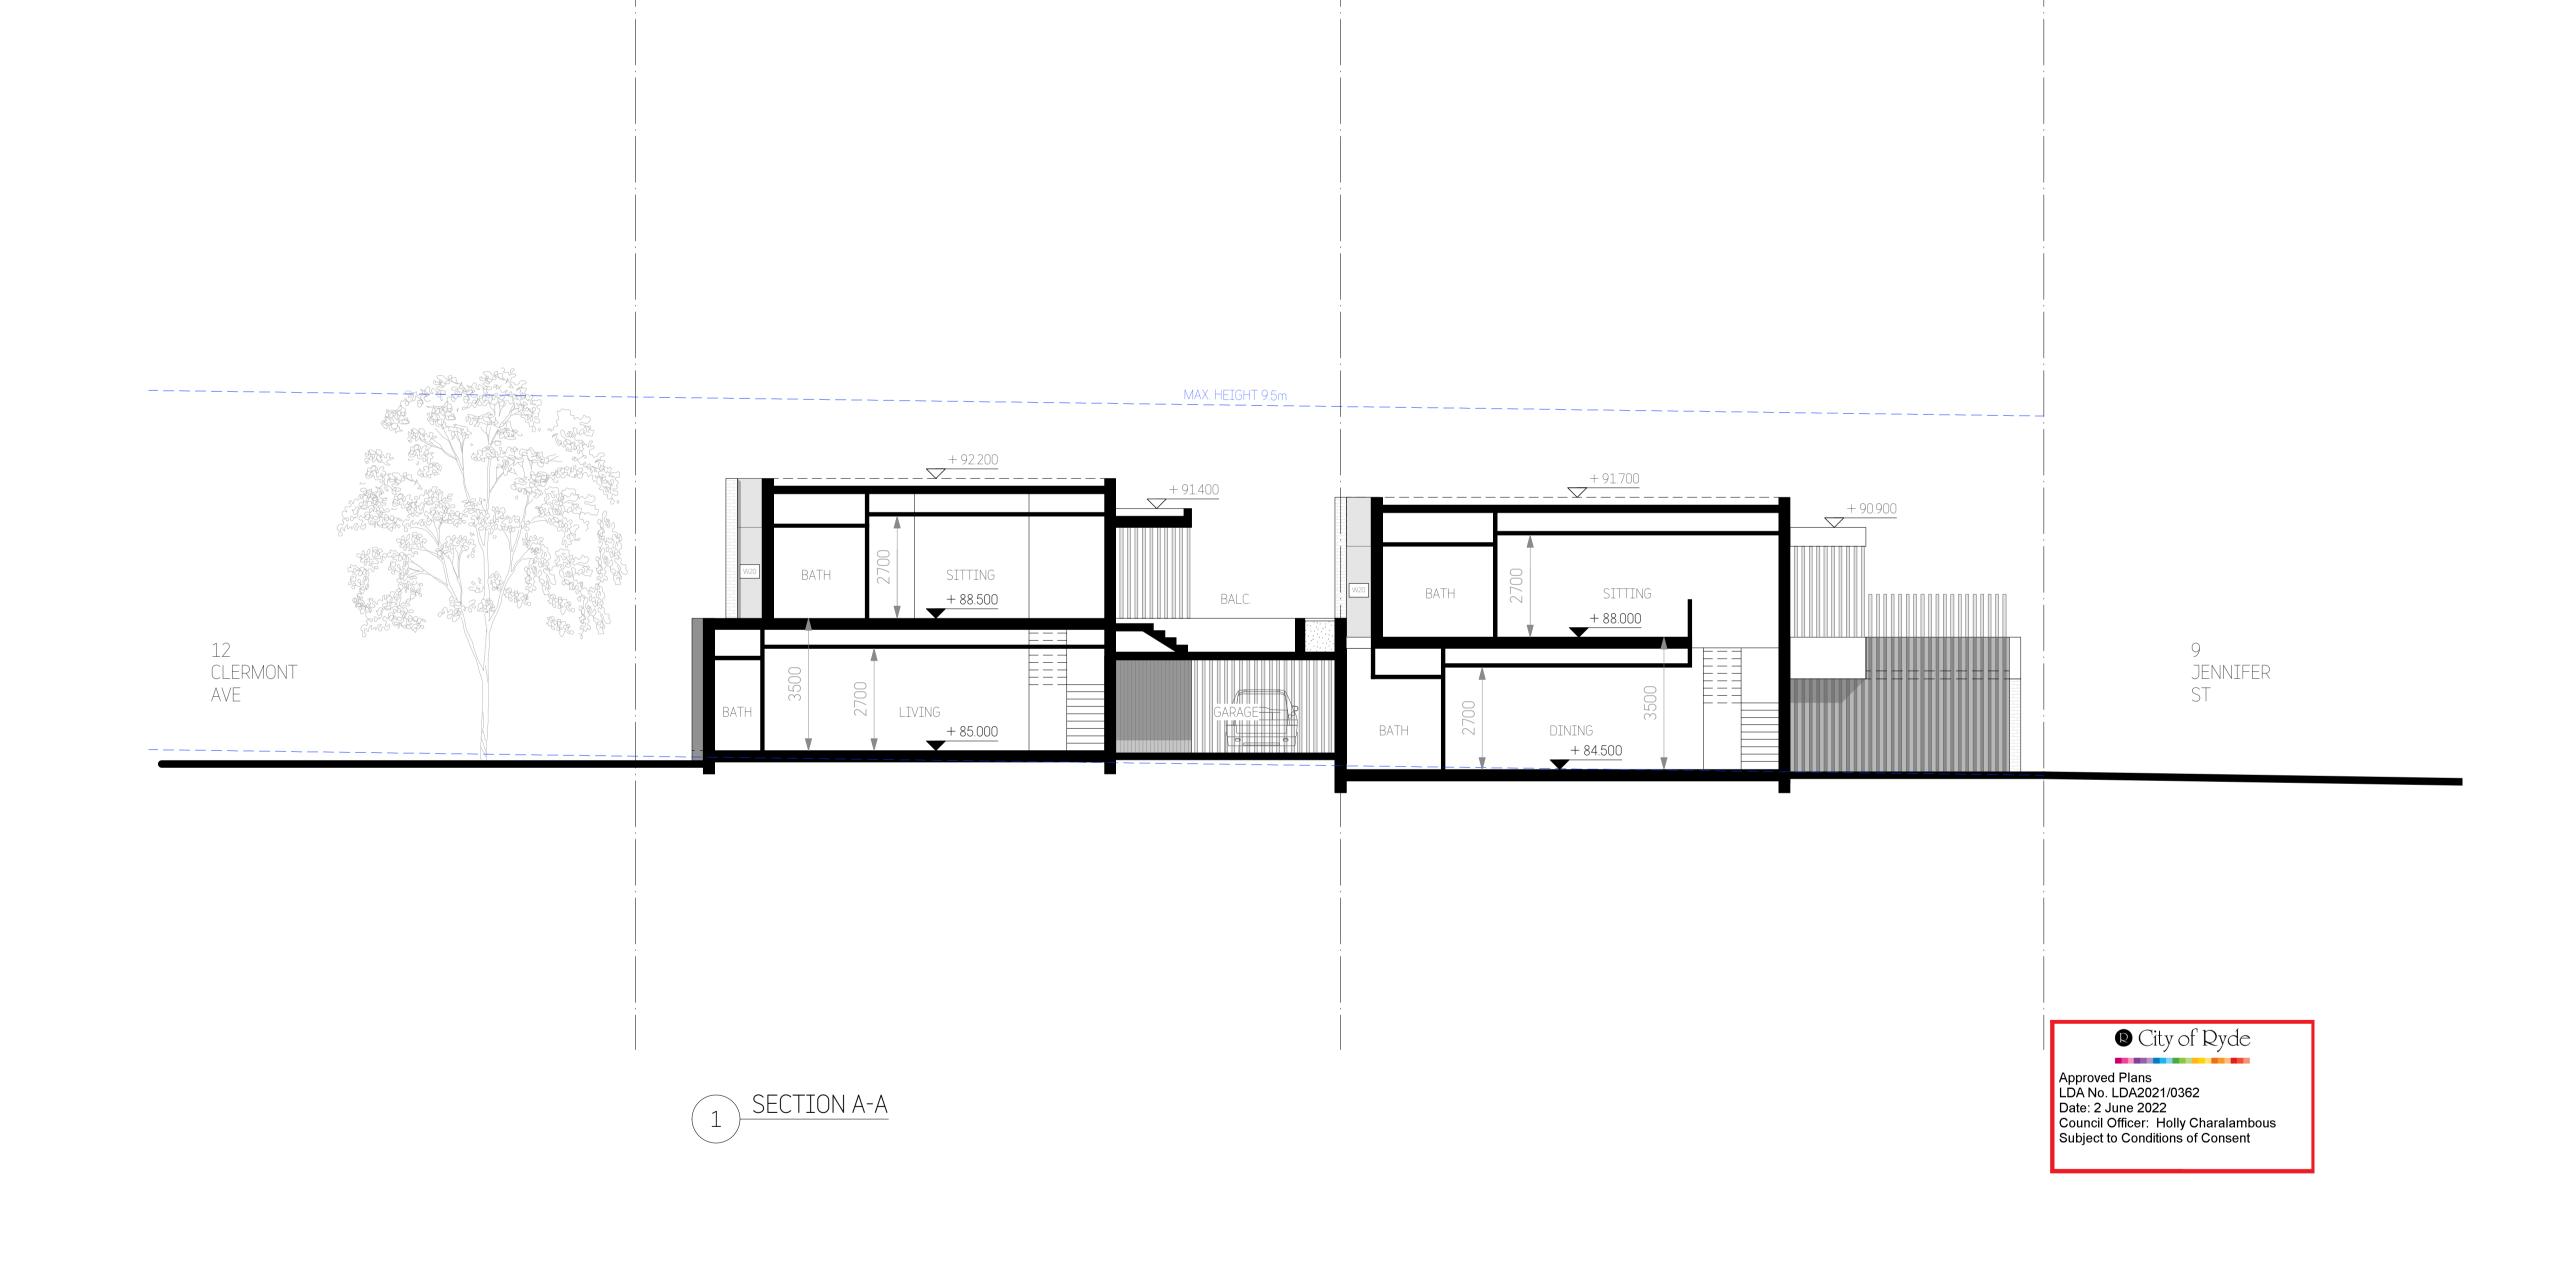t: 0414 866 065 e: boris@studiobd.com.au SFC. w: studiobd.com.au abn: 74 219 560 787

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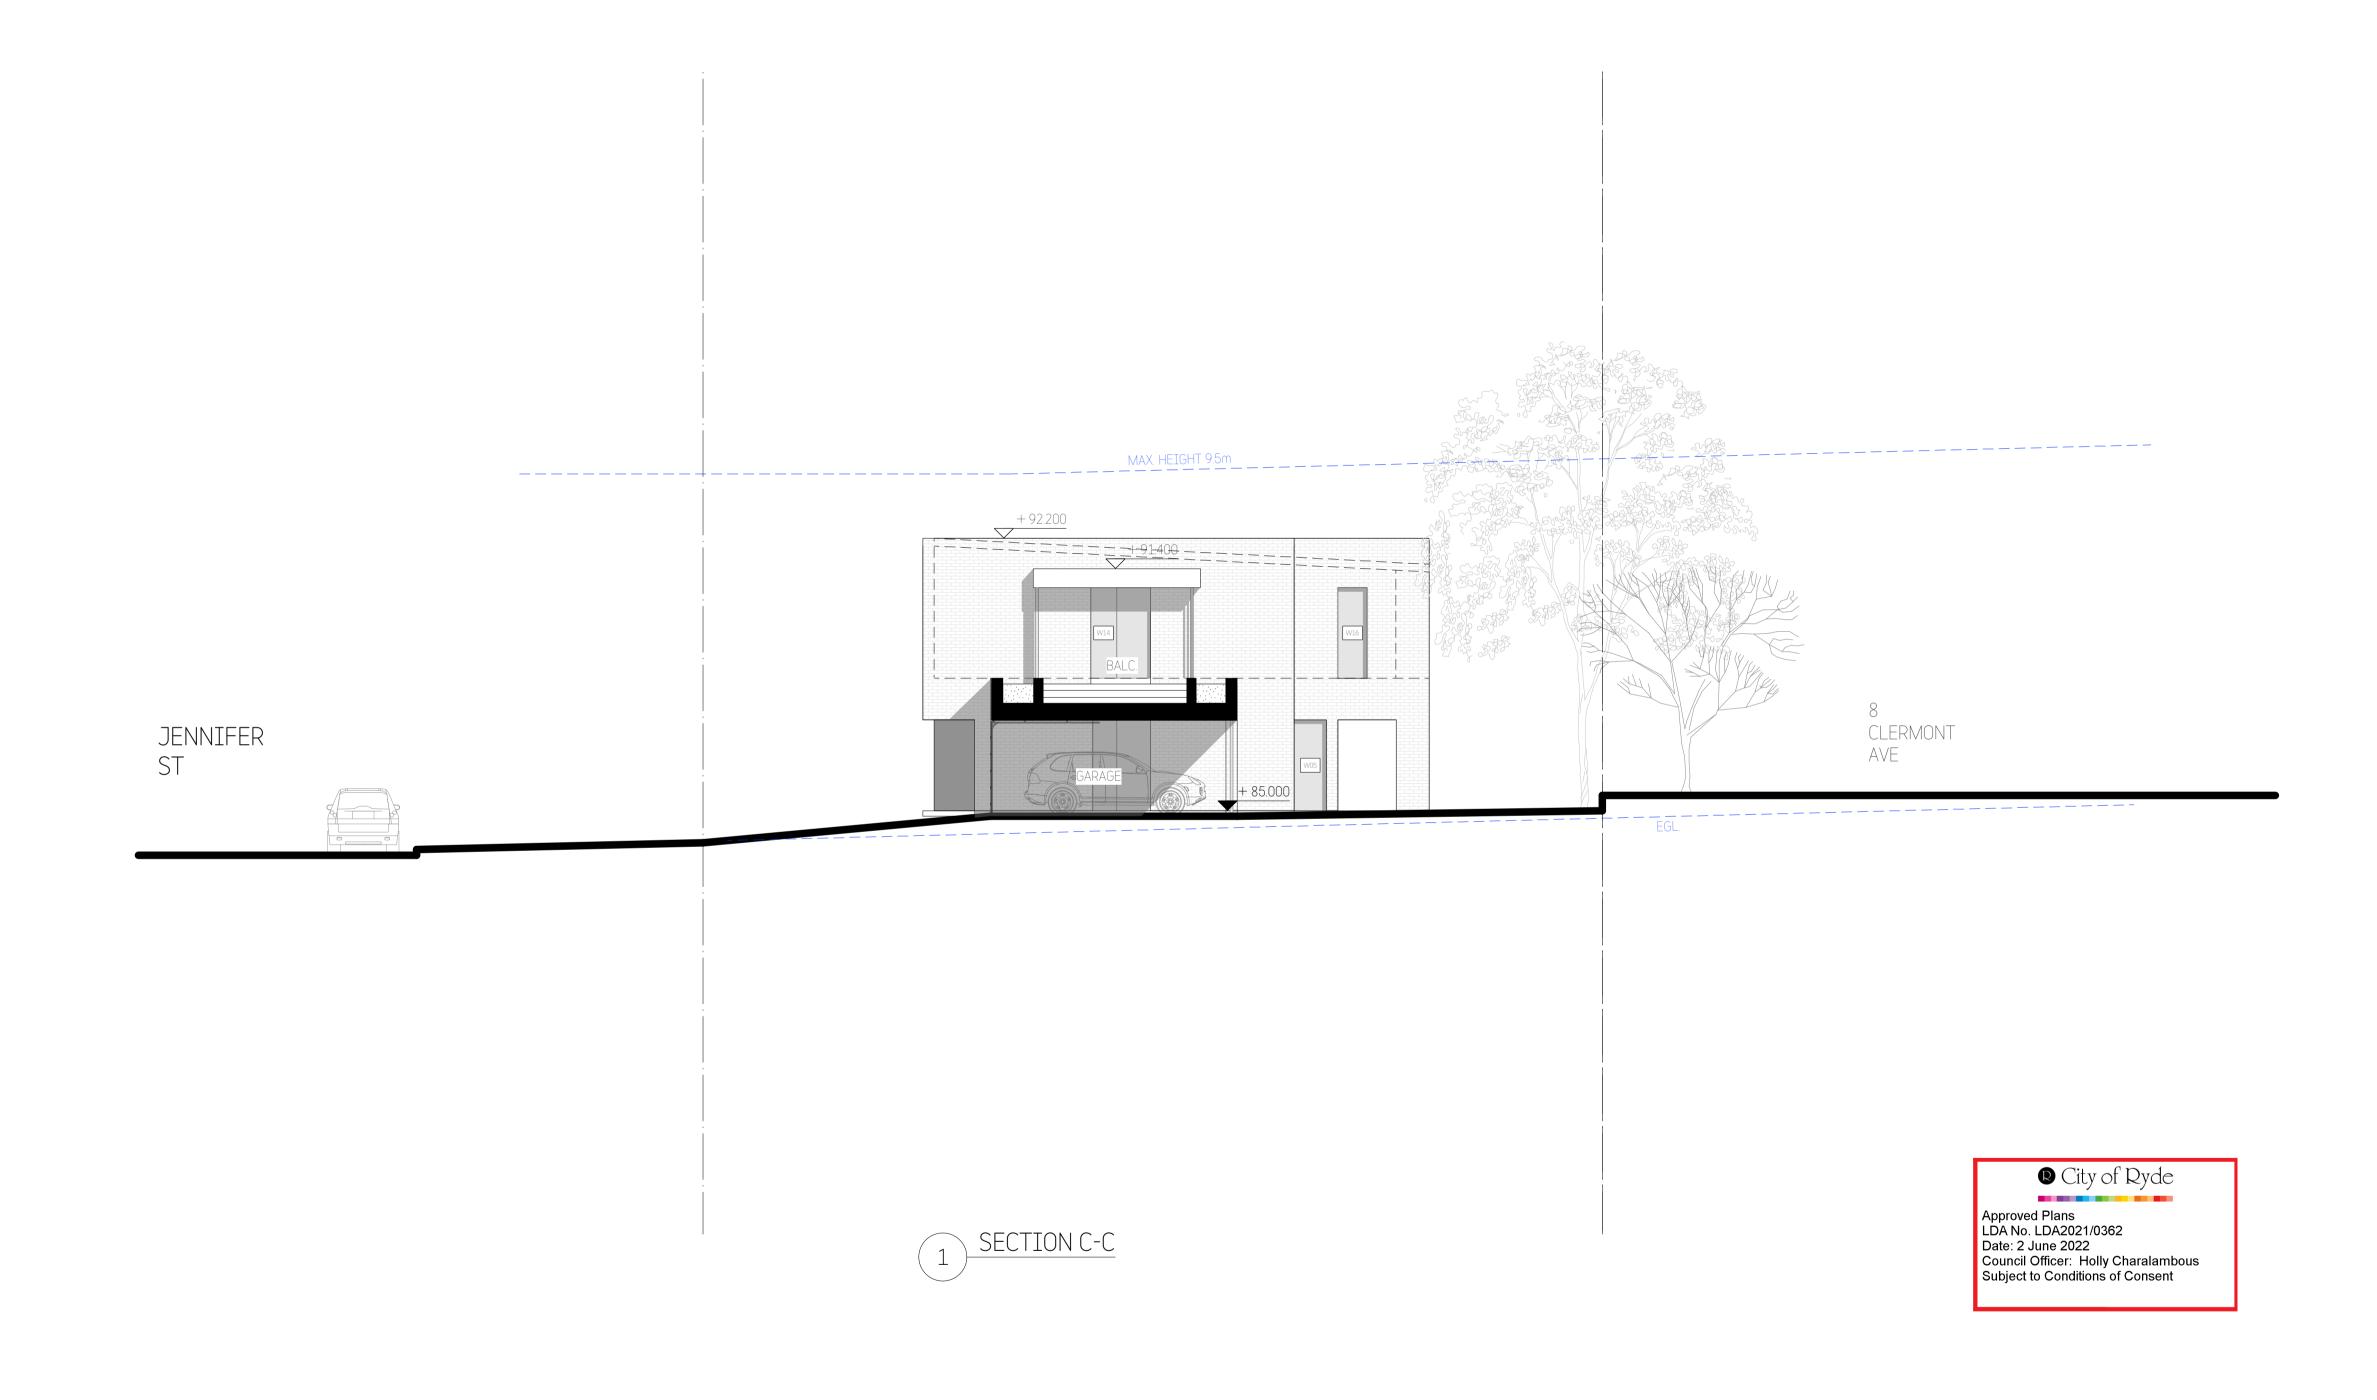
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Nominated Architect Boris Dragas NSW ARB #7658
t: 0414 866 065 e: boris@studiobd.com.au w: studiobd.com.au abn: 74 219 560 787

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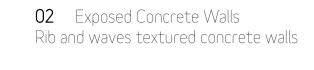


Revisions:

06

Patricia

Zena





01 External Brickwork Walls Painted Dulux ' Lexicon - Quarter'


04 Vertical Aluminium Battens Colorbond 'Monument - Matt'

05 Glass Entry Door

06 Metal Roofing Colorbond "Surfmist"


07 External Walls / Edgebeams Acrilic Render Painted Dulux ' Lexicon - Quarter'



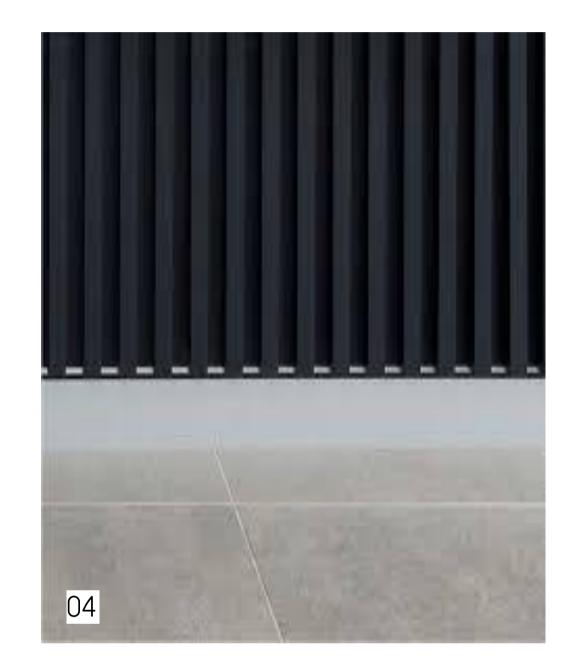





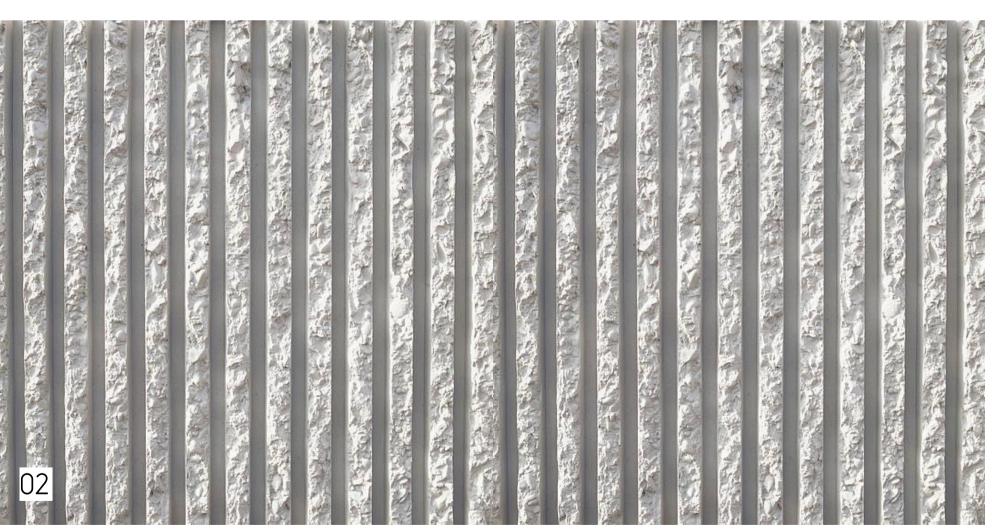



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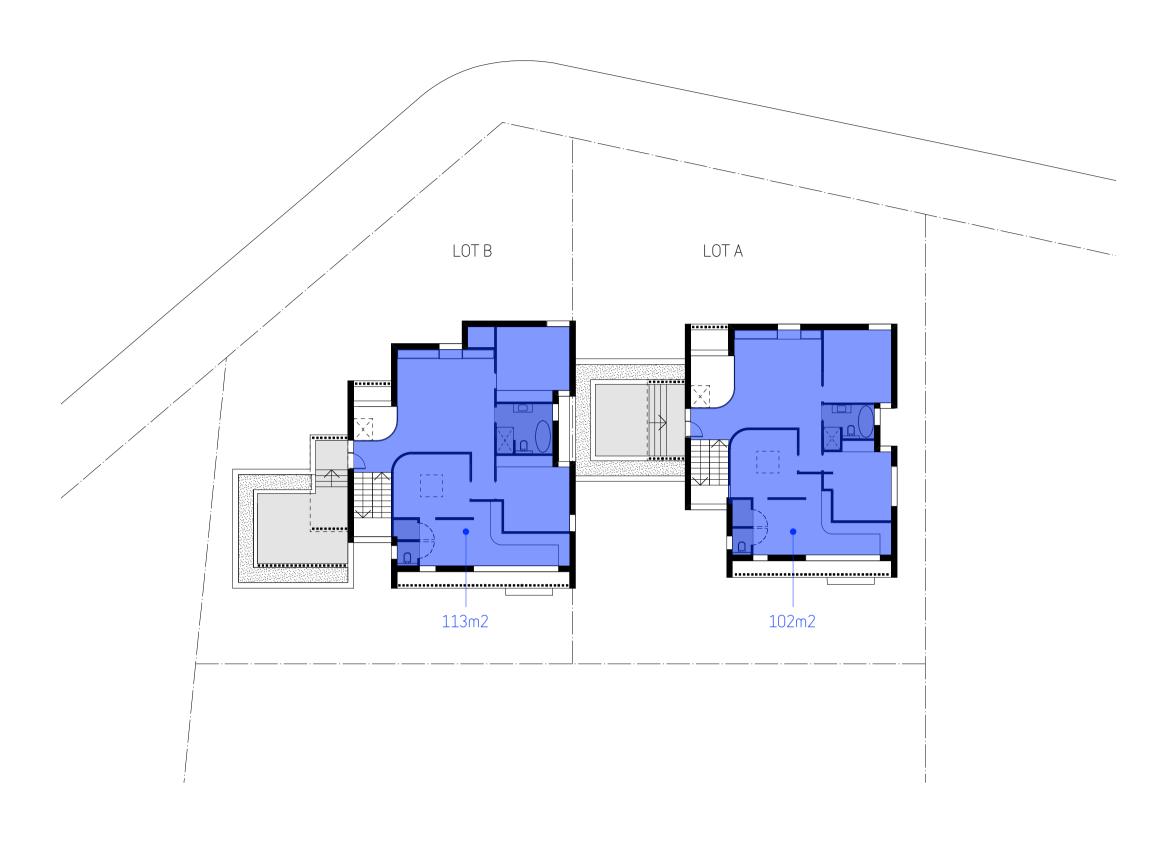


	City of Ryde
STUDIO_BD	Approved Plans LDA No. LDA2021/0362 Date: 2 June 2022 Council Officer: Holly Charalambous Subject to Conditions of Consent
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abn: 74 219 560 787

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t: 0414 866 065 e: boris@studiobd.com.au	-
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Project:	Drawn:	BD		Date: 11/08/21	
10 JENNIFER ST, RYDE				Scale: NTS	
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EXTERNAL FINISHES SCHEDULE	782D	A_A_	17		D







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SITE AREA = 927.4m2

LOT A = 223m2 gfa LOT B = 237m2 gfa = 459.5m2 gfa (0.495:1)

> O City of Ryde Approved Plans LDA No. LDA2021/0362 Date: 2 June 2022 Council Officer: Holly Charalambous Subject to Conditions of Consent



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10 JENNIFER ST, RYDE		Scale: NTS		
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AREA SCHEDULE	782DA_A_	18	В	



DEVELOPMENT APPLICATION

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01 14.09.21 Preliminary issue for comment.

A 06.10.21 Amend to comments. DA issue. B 03.02.22 Amend to comments. DA issue.

10 Jennifer Street, Ryde NSW

Younes Property Pty Ltd

Context Plan

scale pr 1:250 @ A3 2

project no. drawing no LP20

g no. s)





01 14.09.21 Preliminary issue for comment. 06.10.21 Amend to comments. DA issue. 03.02.22 Amend to comments. DA issue.

10 Jennifer Street, Ryde NSW

Younes Property Pty Ltd

Landscape Plan

PLANT SCHEDULE: 10 JENNIFER ST

I LANT CONEDCE I TO	, E. H. H. E. H. G. I				
Botanic Name	Common Name	Supply Size (mm/L)	Mature Height	Mature Spread	Qty
Trees					
Cupaniopsis anacaroides	Tuckeroo	75L	6m	4m	1
Eucalyptus haemastoma *	Scribbly Gum	75L	15m	6m	1
Lagestroemia 'Tuscarora'	Tuscarora Crepe Myrtle	75L	5m	4m	1
Tristaniopsis laurina *	Water Gum	75L	12m	4m	1
Shrubs					
Alpinia zerumbet 'Variagata'	Variagated Shell Ginger	200mm	2m	1m	12
Buxus sempervirens	Boxwood	200mm	1m	1m	42
Cordyline fruticosa 'Rubra'	Red Ti plant	300mm	2m	1m	1
Doryanthes excelsa	Gymea Lily	45L	1.2m	1.2m	3
Emerophila nivea	Silky Emu Bush	200mm	1.5m	1.5m	1
Eriostemon myoporoides	Long Leaf Wax Flower	300mm	2m	2m	2
Gardenia thunbergia	Thunberg's Gardenia	300mm	2m	1m	10
Lavandula stoechas	Lavander	200mm	1.5m	1m	14
Polygala grandiflora	Milkwort	300mm	1.5m	1.5m	4
Rhaphiolepis 'Oriental Pearl'	Oriental Pearl Hawthorn	200mm	1m	1m	23
Syzygium australe 'Select'	Brush Cherry Select Form	300mm	2m	1m	5
Westringia 'Aussie Box'	Aussie Box Coast Rosemary	200mm	0.9m	0.9m	12
Palms / Ferns / Cycads					
Cycas revoluta	Sago Palm	45L	1.5m	1m	2
Groundcovers / Climbers					
Aspidistra elatior	Cast Iron Plant	200mm	1m	1m	17
Brachyscome multifida	Cut Leaf Daisy	200mm	0.3m	0.6m	20
Calathea zebrina	Zebra Plant	200mm	0.7m	0.7m	5
Cissus antarctica	Kangaroo Vine	140mm	0.1m	1m	26
Dianella caerulea	Flax Lily	140mm	0.7m	0.7m	21
Gaura lindheimeri	Butterfly Bush	200mm	1.2m	1m	5
Pennisetum 'Nafray'	Nafray Foxtail Grass	140mm	0.9m	0.9m	19
Philodendron 'Xanadu'	Xanadu Philodendron	200mm	0.9m	0.9m	13
Trachelospermum 'Tricolor'	Tricolor Jasmine	140mm	0.3m	1m	14
Viola hederacea	Native Violet	140mm	0.2m	0.5m	25
* - Denotes selection to satisfy C	Council DCP part 2.13 - Landscapii	ng		Q	City of Ryde

^{* -} Denotes selection to satisfy Council DCP part 2.13 - Landscaping

Matthew Higginson Landscape Architecture Pty Ltd po box 353 five dock nsw 2046 மூர் இரு இது வரை பார்கள் மார்கள் மார்க



Approved Plans



Layered Planting







Patio Fireplace : 2-sided

Landscape steps







Driveway: Cobblestone

Paving: Stone Flagging

Stepping Stones

Steel Edge : Corten®









Eucalyptus haemastona

Tristaniopsis laurina

Lagestroemia 'Tuscarora'

Cupaniopsis anacaroides









Westringia 'Aussie Box'



Rhaphiolepis 'Oriental Pearl'







Trachelospermum

Polygala myrtifolia

10 Jennifer Street, Ryde NSW

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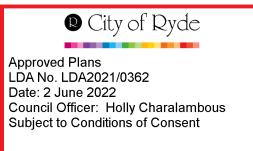
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DEVELOPMENT APPLICATION

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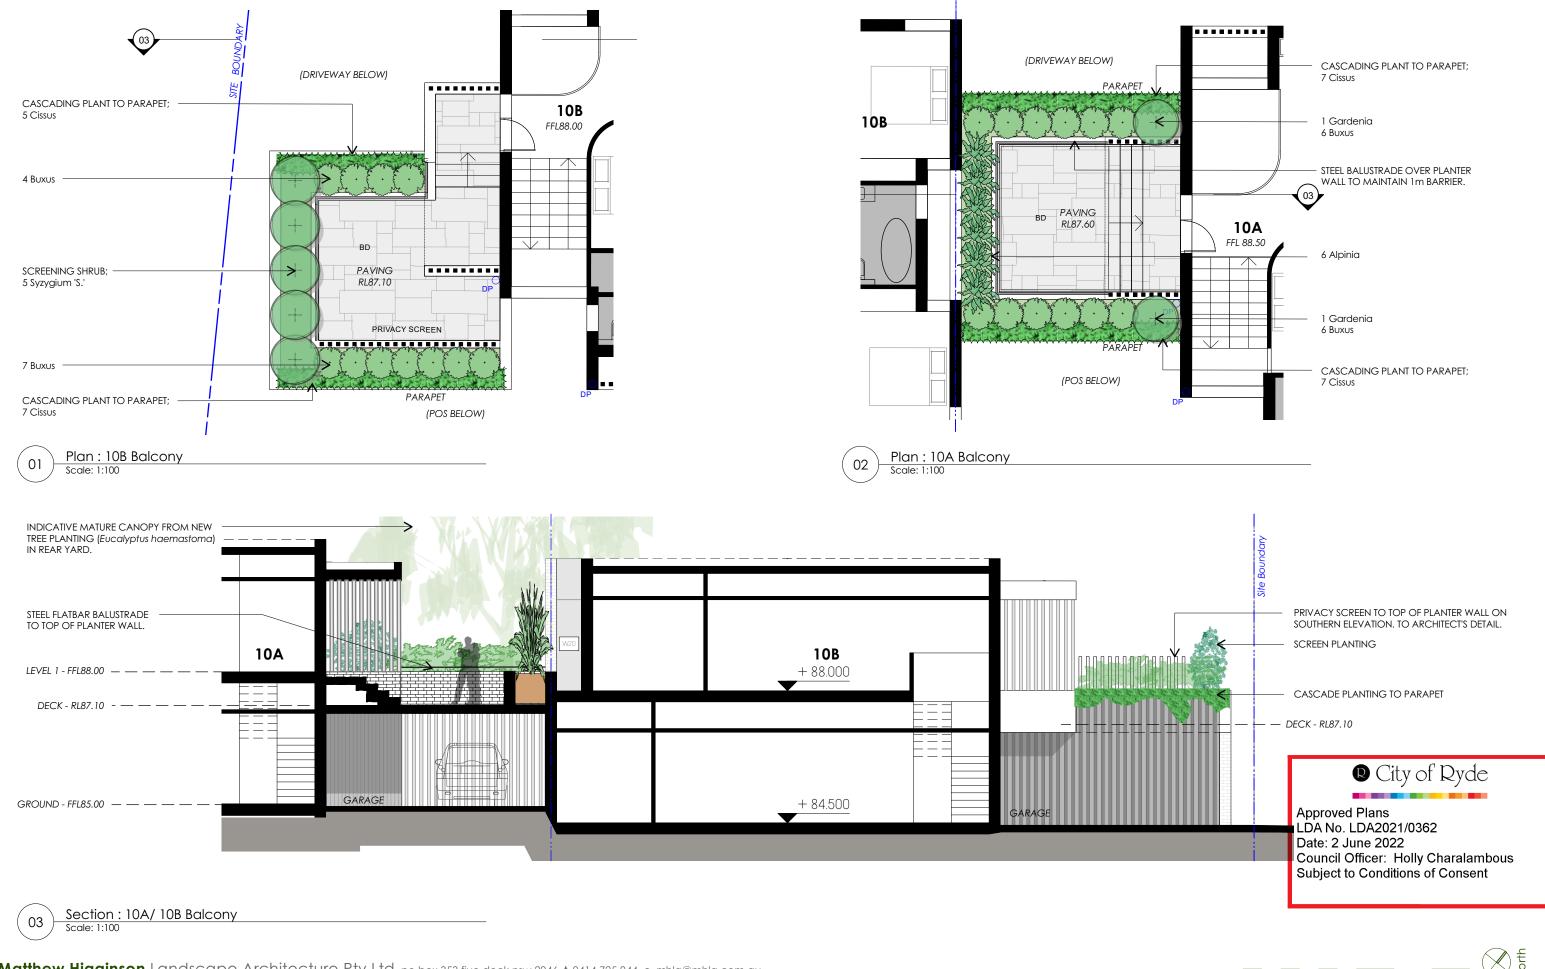
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drawing title **Section A**

1:100 @ A3

21898 LP23

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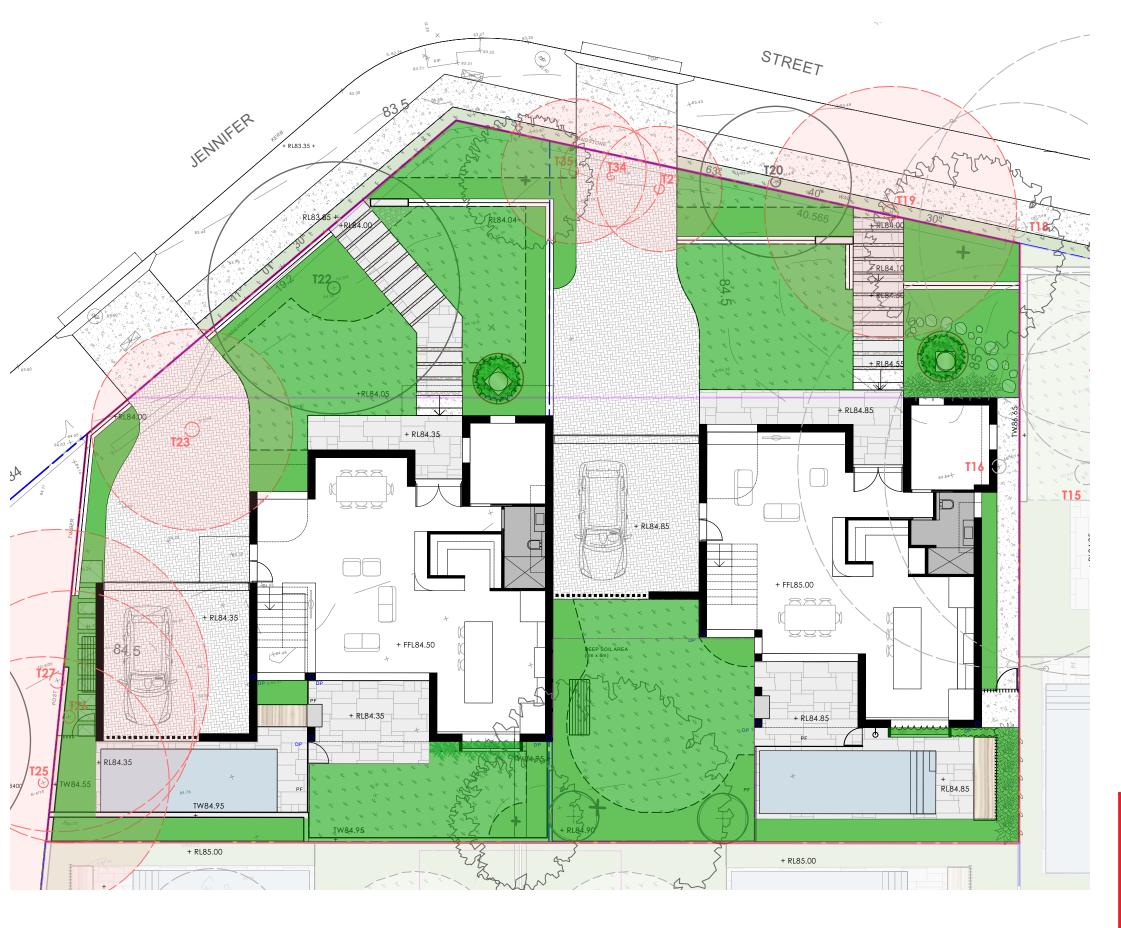
Younes Property Pty Ltd

drawing title Level 1 Balcony

1:150 @ A3 21898 LP24

В

notes: This drawing has been prepared for consideration and reference in the communication of conceptual ideas and is not intended as a detailed 'For Construction' document . No guarantee is given to the accuracy in location or size of existing or proposed elements, measurements or nominated or figured dimensions. Do not scale drawing. Drawing and content protected by copyright.



SITE AREA 927.40m2

LANDSCAPE:

324.59m2 (35%; DA) Deep Soil 337.37m2 (36%)

City of Ryde

Approved Plans LDA No. LDA2021/0362 Date: 2 June 2022

Council Officer: Holly Charalambous Subject to Conditions of Consent

Matthew Higginson Landscape Architecture Pty Ltd po box 353 five dock nsw 2046 t 0414 725 944 e mhla@mhla.com.au _

DEVELOPMENT APPLICATION

01 14.09.21 Preliminary issue for comment. A 06.10.21 Amend to comments. DA issue.

B 03.02.22 Amend to comments. DA issue. 10 Jennifer Street, Ryde NSW

Younes Property Pty Ltd

drawing title

1:150 @ A3

Calculations Diagram

21898

LP25

Development Engineering Service

Approved Engineering Plans

Application Number: LDA2021/362 Council Officer: HJ Date: 24/2/21

STORMWATER MANAGEMENT PLAN PROPOSED DUAL OCCUPANCY No.10 JENNIFER STREET, RYDE

Q City of Ryde

Approved Plans

LDA No. LDA2021/0362 Date: 2 June 2022

Council Officer: Holly Charalambous Subject to Conditions of Consent

GENERAL NOTES:

- THESE PLANS REMAIN THE PROPERTY OF NY CIVIL ENGINEERING PTY LTD AND ARE SUBJECT TO COPYRIGH
- ALL DIMENSIONS IN MILLIMETERS UNLESS OTHERWISE STATED. ALL REDUCED LEVELS (SURFACE LEVELS, INVERT LEVELS) AND CHAINAGES ARE IN METERS UNLESS OTHERWISE STATED. DO NOT SCALE OFF THE DRAWINGS, SCALES ARE AS SHOWN, USE FIGURED DIMENSION:
- THIS PLAN IS TO BE READ IN JUNCTION WITH LATEST ARCHITECTURAL STRUCTURAL LITHLITY AND LANDSCAPE PLANS IN ADDITION TO ANY
- ALL WORKS SHALL BE CARRIED OUT TO LOCAL COUNCIL'S DEVELOPMENT CONTROL PLAN AND SPECIFICATIONS. AS/NZS 3500.3 AND B.C.A.
- ALL LEVELS SHALL RELATE TO THE ESTABLISHED BM. PM AND/OR LM. ALL EXISTING SERVICES ARE TO BE VERIFIED FOR LOCATION AND DEPTH PRIOR TO COMMENCEMENT OF ANY WORK. CONTRACTOR TO NOIFY DESIGNER OF ANY DISCREPANCIES OF SERVICE LEVELS QUOTED ON THIS PLAN. ALL SURVEY INFORMATION, BUILDING AND FINISHED SURFACE LEVELS SHOWN IN THESE DRAWINGS ARE BASED ON LEVELS OBTAINED
- IT IS THE RESPONSIBILITY OF THE CONTRACTOR TO ORTAIN ANY PRIOR APPROVAL REQUIRED FROM COUNCIL WITH RESPECT TO POTENTIAL IMPACT ON TREES FOR ANY WORKS SHOWN ON THIS DRAWING PRIOR TO THE COMMENCEMENT OF WORKS. NO TREES SHALL BE REMOVED WITHOUT THE WRITTEN PERMISSION OF COUNCIL
- THE CONTRACTOR SHALL TAKE ALL DUE CARE TO USE THE ABSOLUTE MINIMUM AREA FOR CONSTRUCTION AND THAT NO UNDUE DAMAGE IS
- THE CONTRACTOR SHALL COMPLY WITH CONDITIONS, AND SPECIFICATION OF COUNCIL AND ALL ACTS OF THE NSW EPA.
- THE CONTRACTOR SHALL TAKE ALL REASONABLE CARE TO PROTECT EXISTING SERVICES. DAMAGED SERVICES SHALL BE REPAIRED AT THE
- ALL NEW WORK IS TO MAKE A SMOOTH JUNCTION WITH EXISTING WORK
- SUITABLE WARNING SIGNS AND BARRICADES ARE TO BE PROVIDED IN ACCORDANCE WITH THE AUSTRALIAN STANDARDS AND AS DIRECTED BY
- SERVICES SHOWN ARE INDICATIVE ONLY FROM AVAILABLE INFORMATION AND THE TIME OF SITE INVESTIGATION (IF ANY). THE BUILDER IS TO
- RESTORE ALL TRAFFIC AREAS TO PRE EXISTING CONDITION. FOR ALL SURFACES OTHER THAN IN TRAFFIC AREAS RESTORE DISTURBED
- RESTORE ALL AUTHORITY OWNED AREAS TO COUNCIL AND/OR AUTHORITY STANDARD AND SPECIFICATION.
- THE WORK AS CONSTRUCTED WORKS SHALL BE INSPECTED BY THE ENGINEER, MINIMUM 48 HOURS NOTICE SHALL BE PROVIDED FOR ALL
- THE DESIGN PLANS HEREIN ARE SUBJECT TO COUNCIL APPROVAL PRIOR TO CONSTRUCTION
- WORK AS CONSTRUCTED DRAWINGS TO BE REQUESTED AND RECEIVED IN CAD/DWG FILE TYPE AND HARD COPY 'RED LINE' MARKLIP FROM

ROOF STORMWATER DRAINAGE NOTES:

- ALL ROOF GUTTERS TO HAVE OVERFLOW PROVISION IN ACCORDANCE WITH AS 3500.3 AND SECTIONS 3.5.3, 3.7.5 AND APPENDIX G OF AS 3500.3.
- ALL DOWNPIPES TO BE FITTED VERTICALLY TO THE SOLE OF EAVES GUTTERS. RAINHEAD AND/OR SUMP
- ALL DOWNPIPES TO DRAIN INTO RAINWATER TANK AND OR PIT PRIOR TO DISCHARGE OFFSITE UNLESS PRIOR APPROVAL IS OBTAINED FROM
- ALL EAVES GUTTERS TO BE SIZED FOR ARI 20 AS PER AS 3500.3 3.5 AND APPENDIX H.
- ROOF DRAINAGE INSTALLATION TO BE IN ACCORDANCE TO AS 3500.3 SECTION 4

STORMWATER DRAINAGE NOTES:

- DN90 FOR ALL DOWNPIPES:
- DN100 WHERE THE LINE ONLY RECEIVES ROOF STORMWATER RUNOFF, OR;
- DN100 WHERE THE LINE RECEIVES RUNOFF FROM PAVED OR UNPAVED AREAS.

PIPE GRADE:

- THE MINIMUM PIPE GRADE SHALL BE
- FOR DN100 DN150 1.00%
- FOR DN225 0.50% FOR DN300 - 0.45%

STANDARD COVER:

- MINIMUM PIPE COVER FOR PVC PIPES SHALL BE AS PER AS 3500.3 TABLE 6.2.5:
- NOT SUBJECT TO VEHICULAR LOADING
- WITHOUT PAVEMENT OTHER THAN SINGLE DWELLINGS 300mm
- WITH PAVEMENT (BRICK/PAVERS) AND/OR UNREINFORCED CONCRETE 100mm
- SUBJECT TO VEHICULAR LOADING:
- ROADS (LINSEALED) 750mm
- OTHER THAN ROADS (WITH PAVEMENT) 100mm OTHER THAN ROADS (WITHOUT PAVEMENT) - 450mm

- PIPES AND FITTINGS FOR STORMWATER DRAINAGE SHALL BE AS FOLLOWS:
- FOR PIPE SIZES UP TO DN225 PVC WITH SOLVENT WELDED JOINTS (IN GROUND).
- FOR PIPE SIZES GREATER THAN DN225 RCP WITH RUBBER RING JOINTS.
 FOR LARGER PIPE DEPTHS AS SPECIFIED IN AS 3500.3 RCP WITH RUBBER RING JOINTS.
- FOR PIPES AND FITTINGS FOR SUBSOIL DRAINAGE SHALL BE SLOTTED PVS WITH SOLVENT WELDED JOINTS MINIMUM DN150. FOR GRATED DRAINS SHALL BE MINIMUM DN150 IN NON-TRAFFICABLE ZONES AND DN225 IN TRAFFICABLE ZONES.
- LAY AND JOINT ALL PIPES IN ACCORDANCE WITH THE MANUFACTURING RECOMMENDATIONS AND
- AS 3725-1989 LOADS ON BURIED CONCRETE PIPES
- AS 2566 1988 BURIED FLEXIBLE PIPELINES
- AS 1597.2 1996 PRECAST REINFORCED CONCRETE BOX CULVERTS
- AS 3500 1990 NATIONAL PLUMBING AND DRAINAGE CODE PART 2 SANITARY PLUMBING AND SANITARY DRAINAGE SYDNEY WATER
- ALLOW TO TEST ALL PIPES AND PITS TO MANUFACTURERS REQUIREMENTS

CONNECTIONS TO STORMWATER SYSTEMS UNDER BUILDINGS

IN ACCORDANCE WITH AS 3500.3 SECTION 9.2

CONNECTIONS TO COUNCIL STORMWATER SYSTEMS:

CONNECTION TO COUNCIL STORMWATER SYSTEM TO BE IN ACCORDANCE TO LOCAL COUNCIL DCP AND STANDARDS. NO CONNECTIONS TO BE MADE UNTIL PROPER PERMIT/APPROVALS ARE OBTAINED FROM LOCAL COUNCIL IN WRITING

EXISTING SERVICES SHOWN ON THESE PLANS ARE NOT GUARANTEED COMPLETE OR CORRECT AND FURTHER INFORMATION IS REQUIRED FROM THE RELEVANT AUTHORITY AND FIELD INVESTIGATION AND ARE TO BE VERIFIED BY THE CONTRACTOR PRIOR TO CONSTRUCTION

29.09.2021

01.02.2022

LEGEND

SURFACE INLET PIT GRATED TRENCH DRAIN SURFACE INLET PIT ABSORPTION TRENCH 00 (WITH ENVIROPOD 200 MICRON) PROPOSED ROOF GUTTER FALL (WITH GROSS POLLUTANT TRAP) PROPOSED DOWNPIPE SPREADER ⊢ (SP) 450 SQUARE INTERVAL 450 X 450 STORMWATER PIPE 100mm DIA, MIN, UNO GRATE LEVEL = 75.50 SL 75.50 SUBSOIL PIPE INVERT LEVEL = RL 75.20 **EXISTING STORMWATER PIPE** PROPOSED DOWNPIPE INSPECTION RISER 90mm DIA. OR 100mm x 50mm MIN. RAINWATER HEAD NATURAL GROUND FINISHED

STORMWATER PIT/STRUCTURES NOTES:

PIT SIZES AND DEPTHS:

PIT SIZES WILL BE AS FOLLOWS:

DEPTH (mm)	MIN. PIT SIZE (mm)
UP TO 450	350x350
450 - 600	450x450
600 - 900	600x600
900 - 1200	600x900
1200+	900x900 (WITH STEP IRONS)

- TRENCH DRAINS: CONTINUOUS TRENCH DRAINS ARE TO BE MIN. DN150 AND MIN. 100mm DEPTH. THE BARS OF THE GRATE ARE TO BE PARALLEL
- STEP IRONS: PITS BETWEEN 1.2m AND 6m ARE TO HAVE STEP IRONS IN ACCORDANCE WITH AS 1657, FOR PITS GREATER THAN 6m OTHER MEANS
- PLASTIC/PVC PITS: PVC PITS WILL ONLY BE PERMITTED IF THEY ARE MAX. 450x450 AND MAX. 450mm DEPTH AS WELL AS BEING HEAVY DUTY
- IN-SITU PITS: IN-SITU PITS ARE TO BE CONSTRUCTED ON A CONCRETE BED OF AT LEAST 150mm THICK. THE WALLS ARE TO BE DESIGNED TO MEET THE MINIMUM REQUIREMENTS OF CLAUSE 4.6.3 OF AS 3500.4. PITS DEEPER THAN 1.8m SHALL BE CONSTRUCTED WITH REINFORCED
- GRATES: GRATES ARE TO BE GALVANIZED STEEL GRID TYPE. GRATES ARE TO BE OF HEAVY-DUTY TYPE IN AREAS WHERE THEY MAY BE SUBJECT

- ALL PITS THAT ARE INSTALLED AT GREATER THAN 600mm DEEP TO BE MIN. 600x600 PIT
- GRATED COVERS ON PITS GREATER THAN 600mm TO BE HINGED
- OUTLET PIPE FROM ANY PIT TO BE 20mm LOWER THAN INLET PIPE/S



ISSUED FOR DA NADER ZAKI MIEAust CPEng NER YR DRAINAGE MODIFIED FOR TREE

DETAILS, NOTES & LEGEND

PROPOSED DUAL OCCUPANCY No.10 JENNIFER STREET **RYDE**


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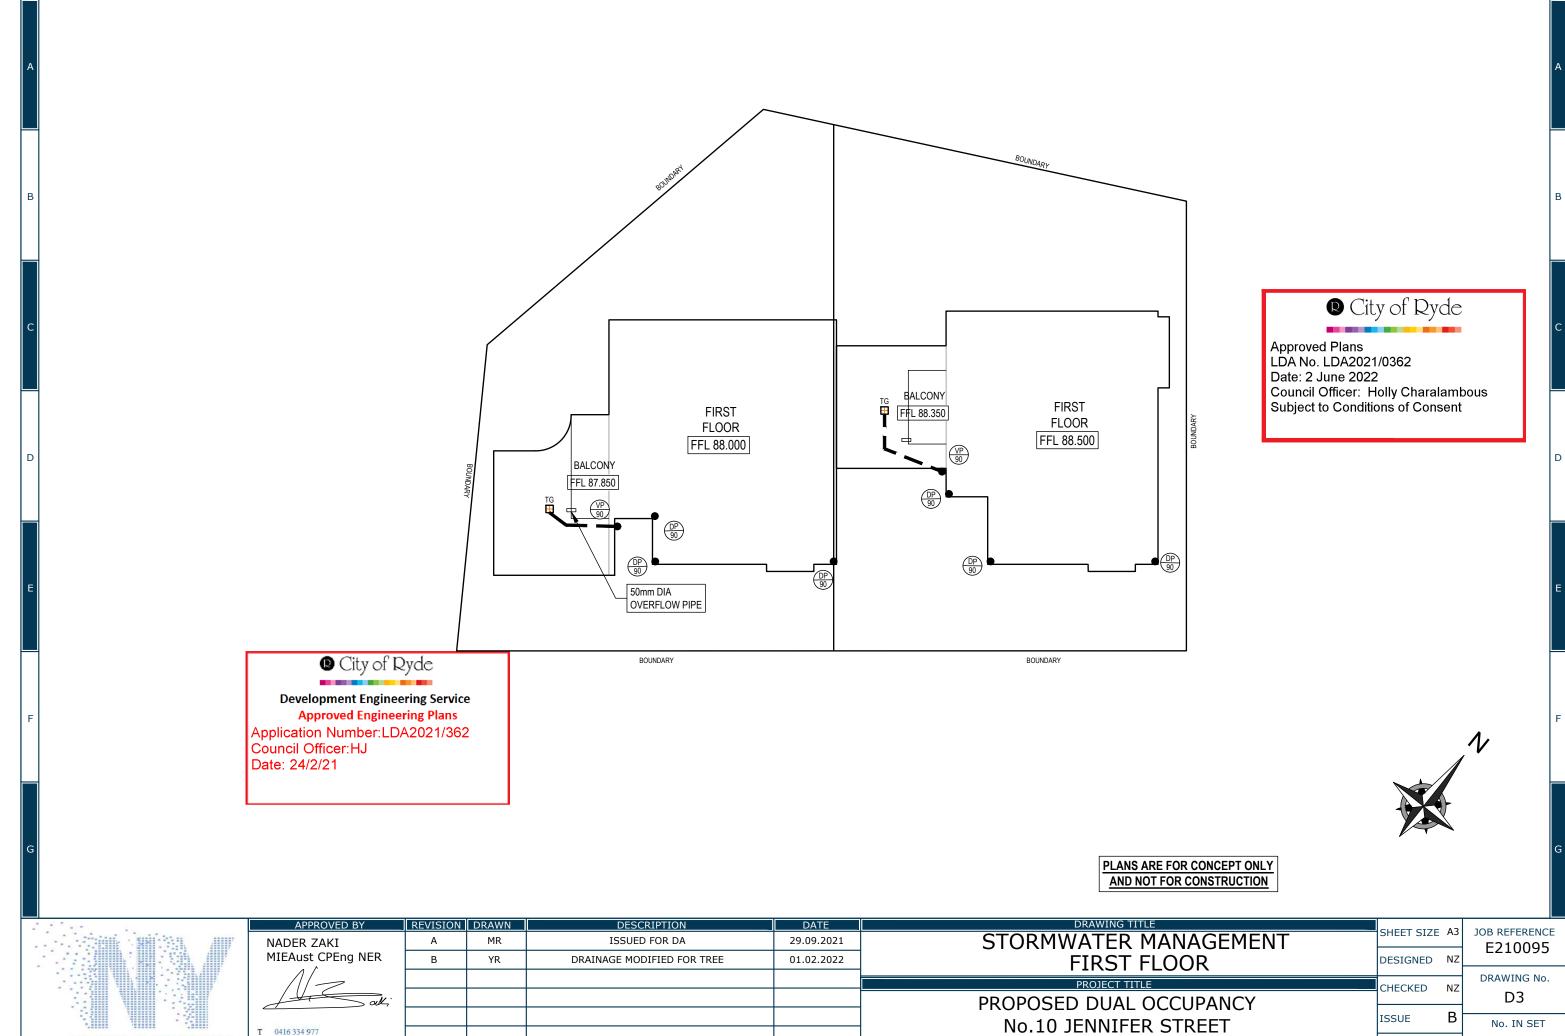
В ISSUE SCALE

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No. IN SET

D1



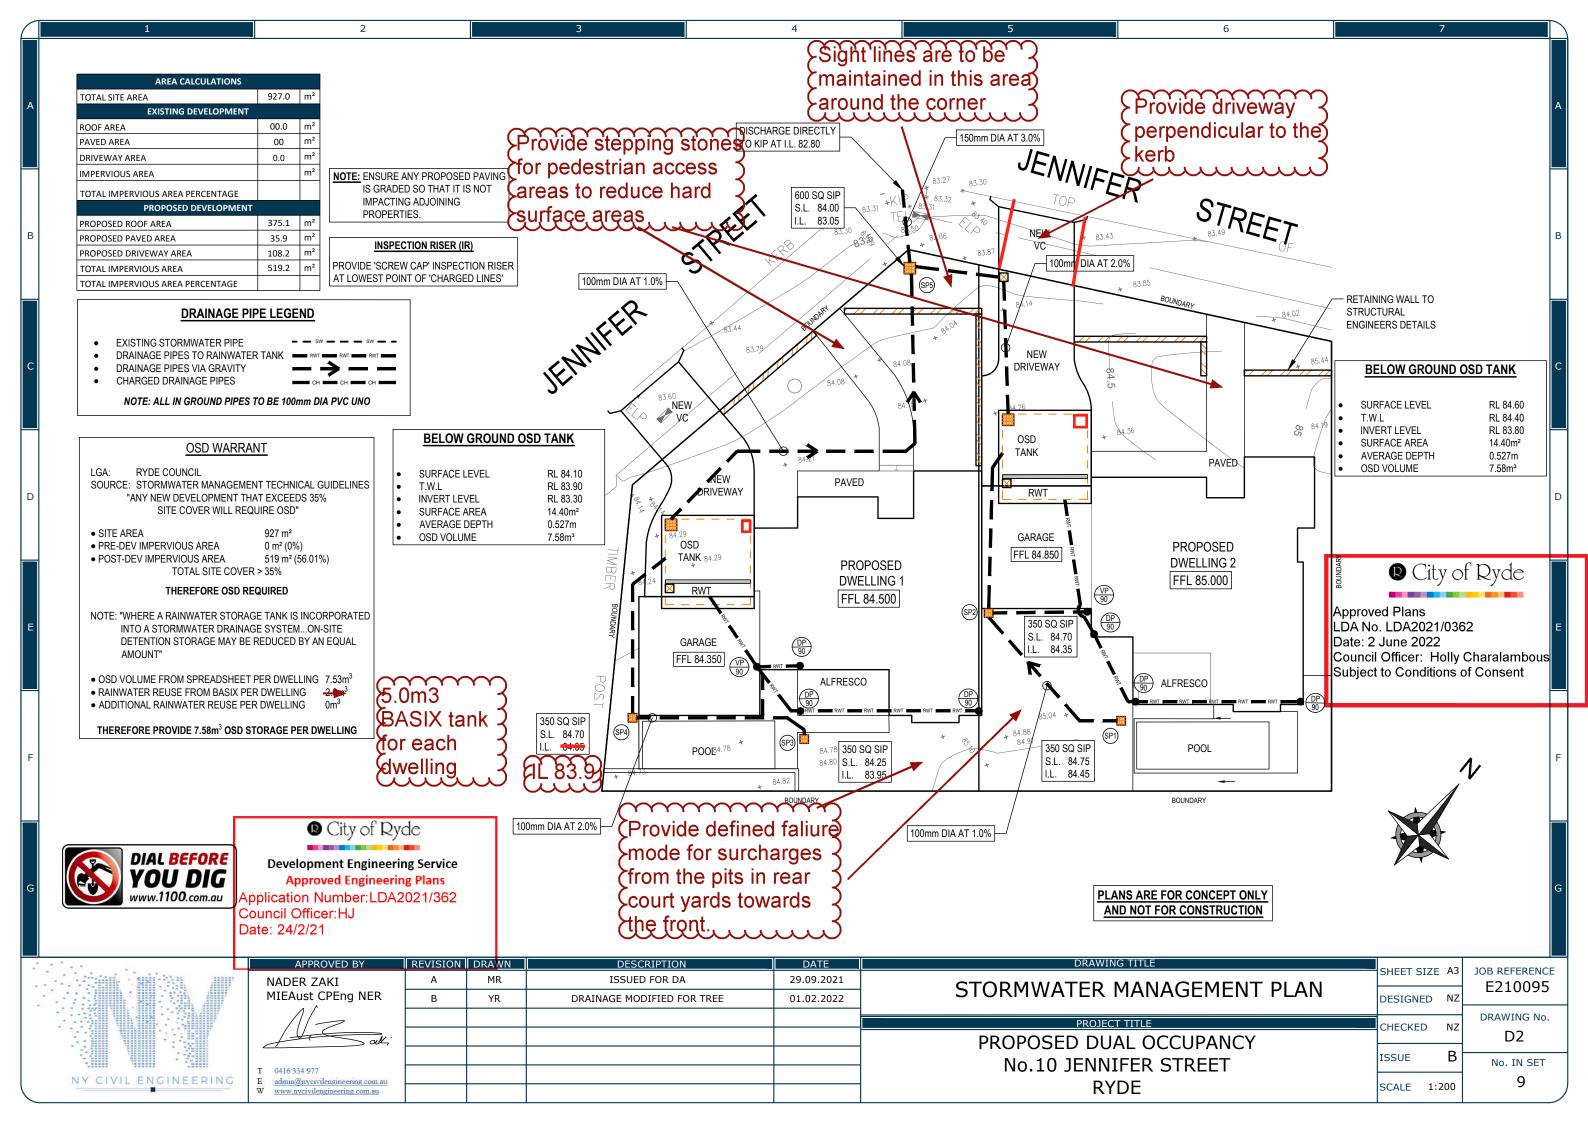


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SCALE 1:200

RYDE

NY CIVIL ENGINEERING



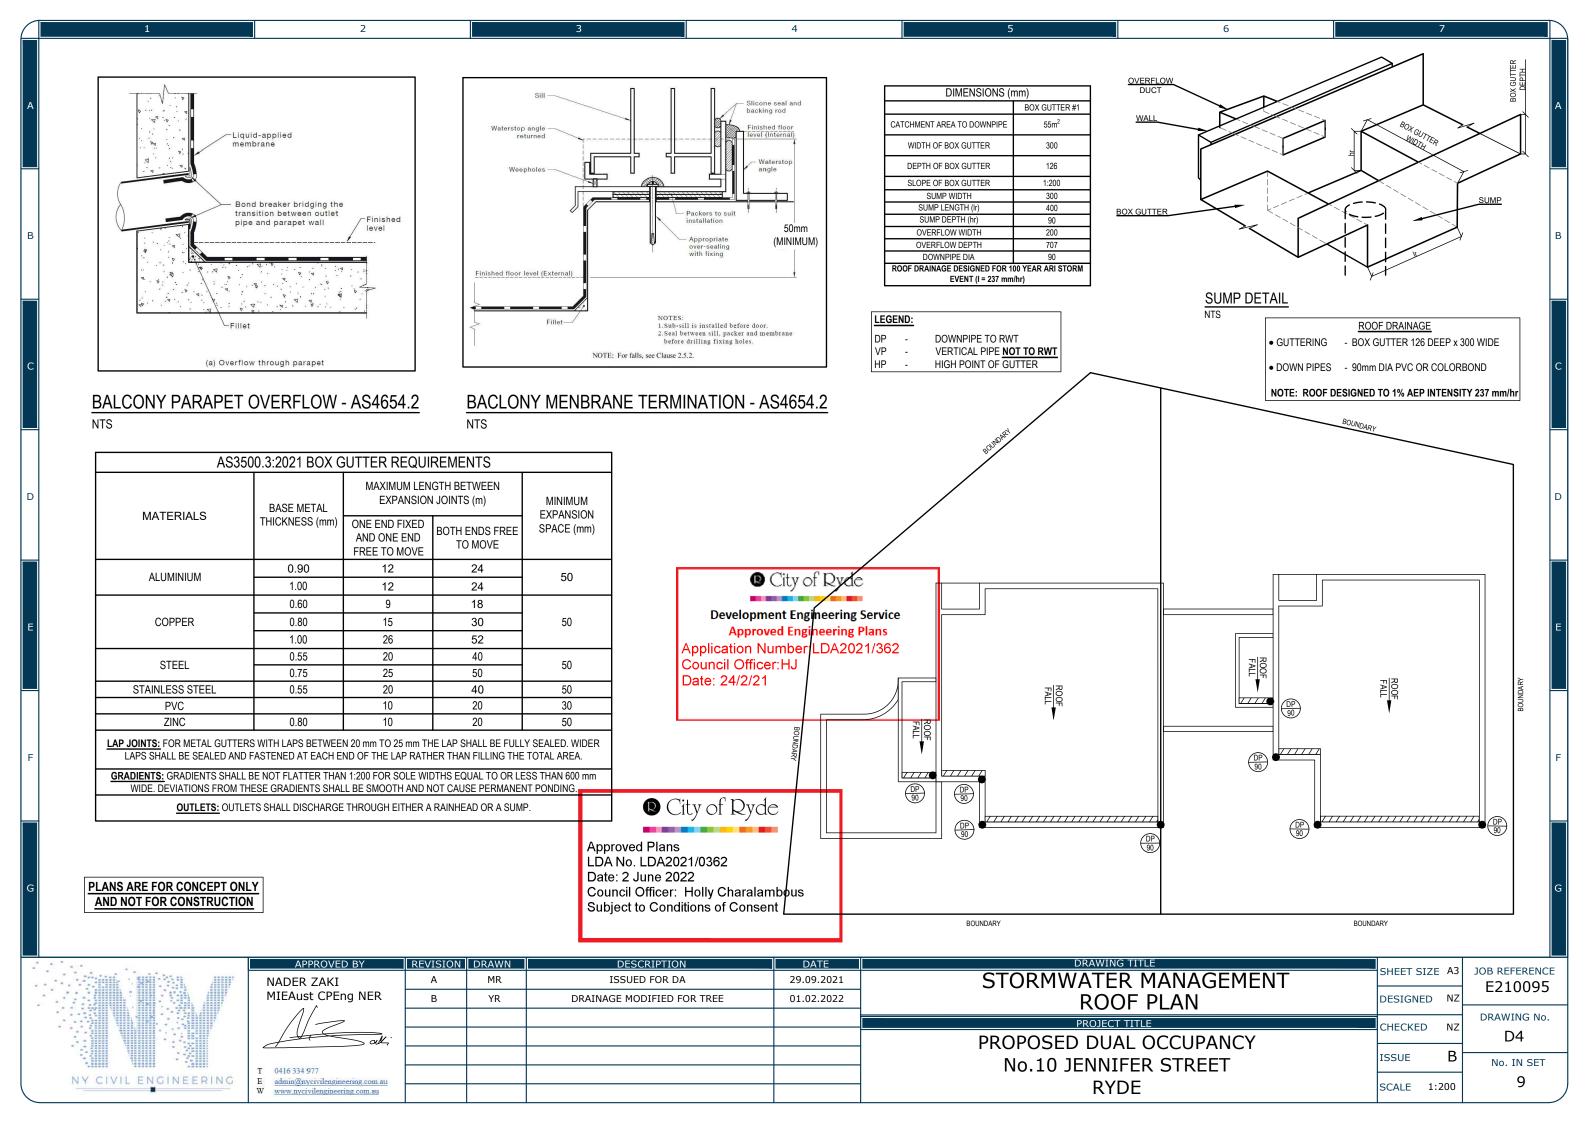





TYPICAL WARNING SIGN

NITS


EVERY EXTERNAL SUPPLY OUTLET FROM RAINWATER RE-USE TANK TO BE LABELED WITH METALLIC WARNING SIGN

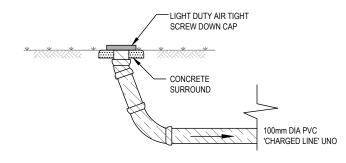

INSPECTION RISER - IR

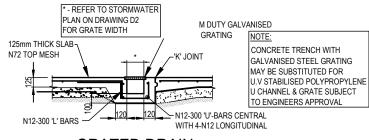


$\frac{\mathsf{GRATED}\;\mathsf{DRAIN}}{\mathsf{NTS}}$

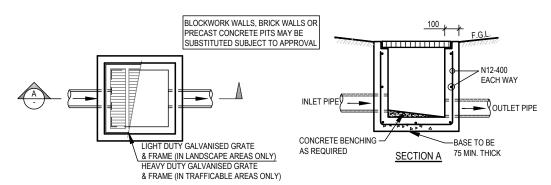


TYPICAL PIT (SIP)

NOTE:
ALL PROPOSED SITE PITS ARE TO BE
CONSTRUCTED IN CONCRETE CAST IN SITU,
PLASTIC OR BRICK PITS ARE NOT ACCEPTABLE.
HOWEVER, 'COUNCIL MAY CONSIDER PRE-CAST
UNITS IF THE UNITS ARE PLACED ON A SOLID
BASE OF GRAVEL OR CONCRETE OF 75mm
THICK AND BACKFILL UP TO HALF THE DEPTH
OF THE PIT SURROUND WITH CONCRETE.

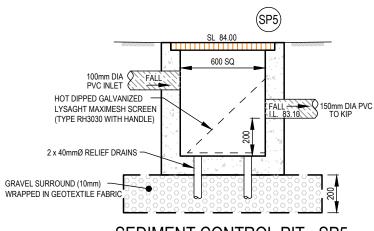

SEDIMENT CONTROL PIT - SP5

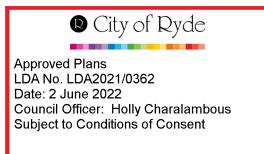






Development Engineering Service
Approved Engineering Plans


Application Number:LDA2021/362 Council Officer:HJ Date: 24/2/21

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						No.10 JENNIFER STREET	ISSUE B	No. IN SET
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NY CIVIL ENGINEERING	W www.nycivilengineering.com.au W www.nycivilengineering.com.au					RYDE	SCALE AS NOTED	9

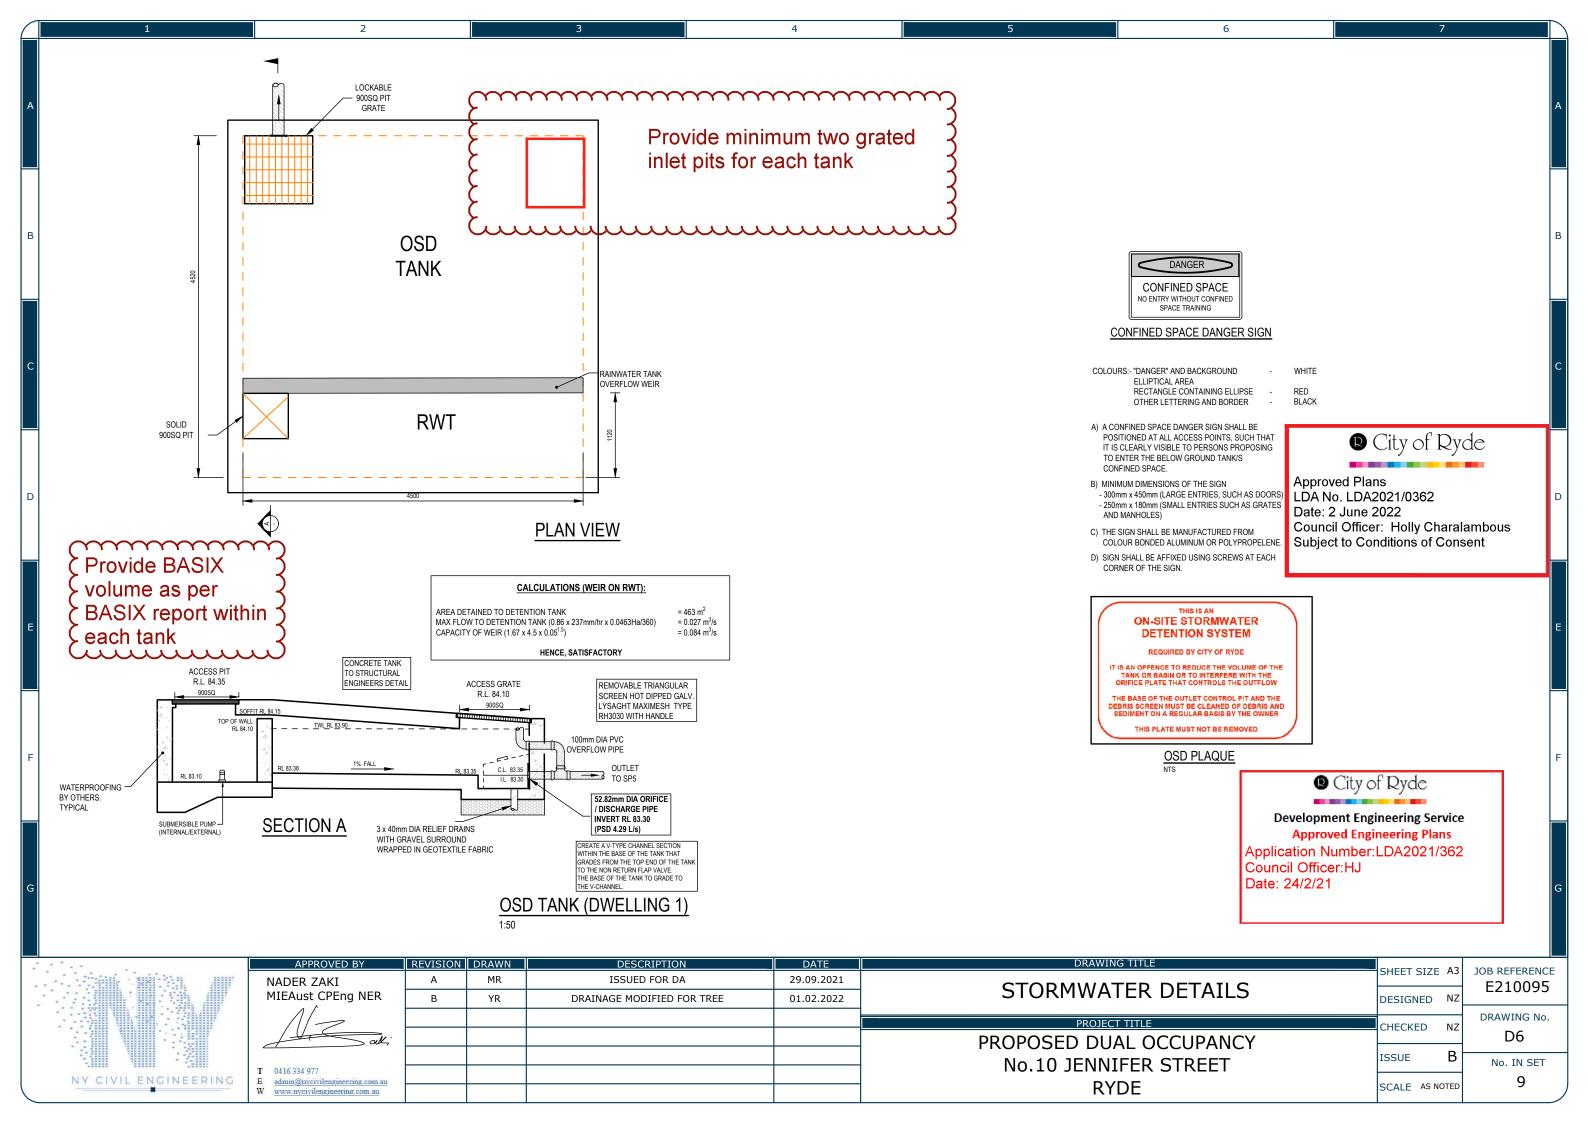

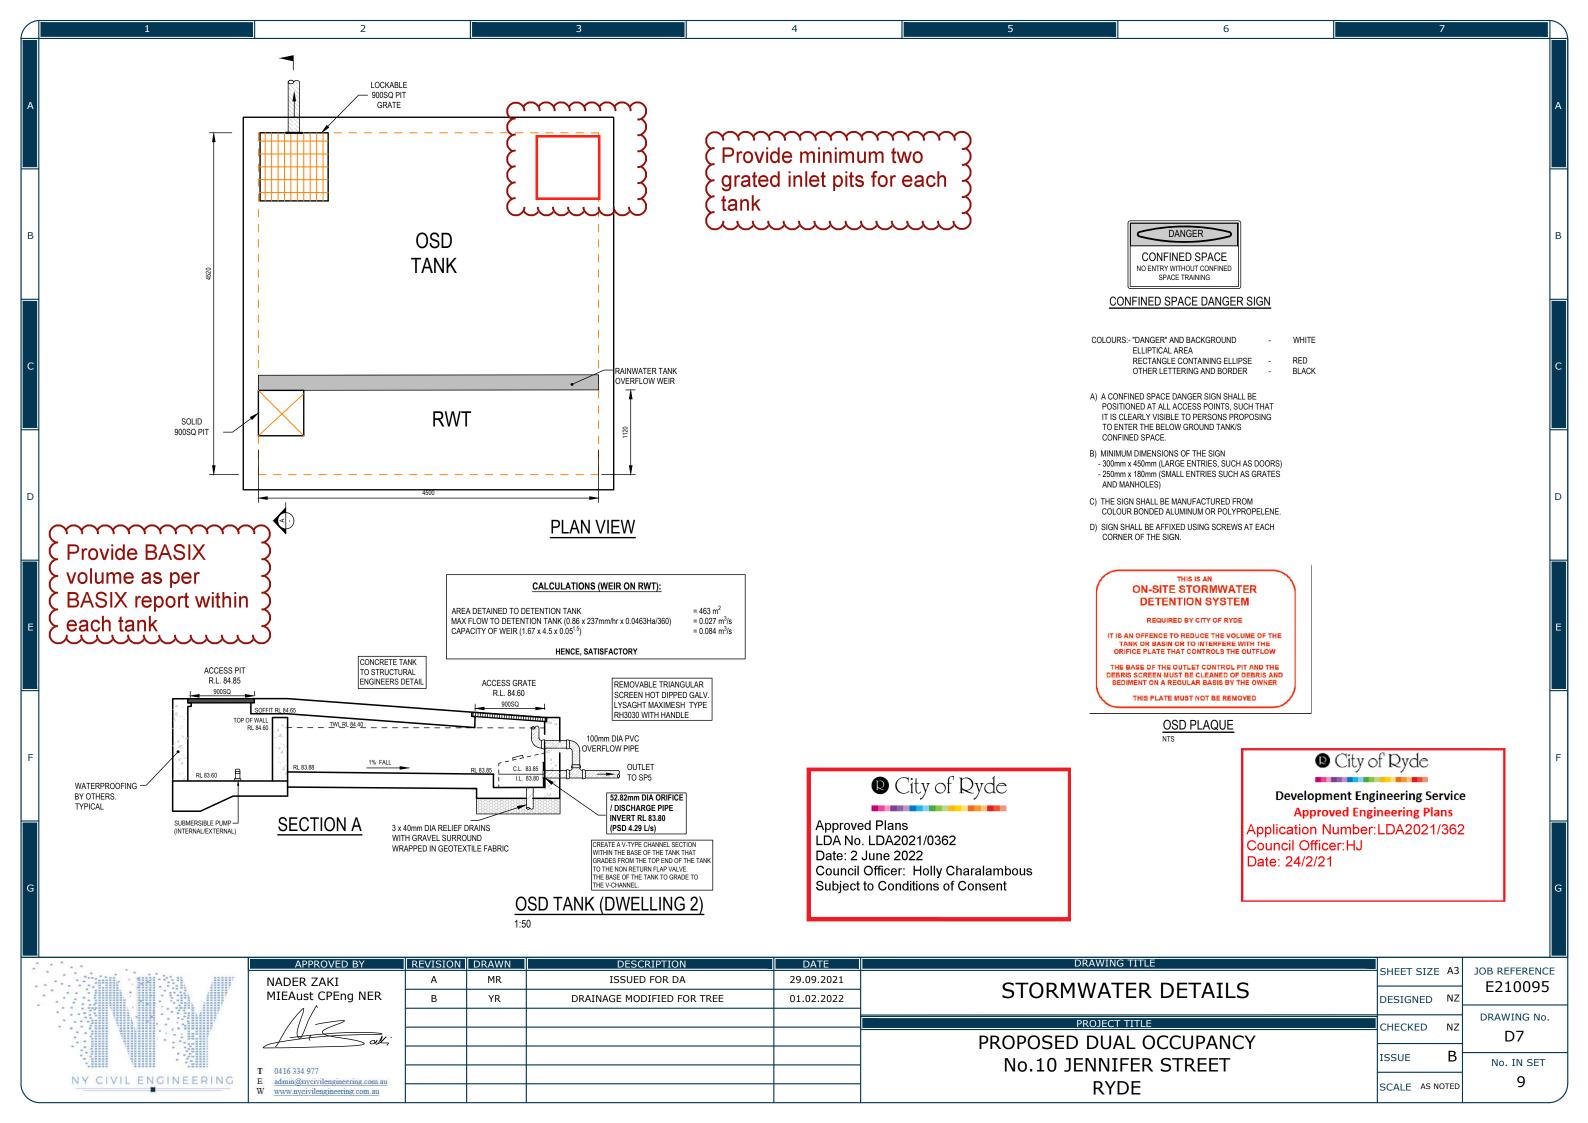

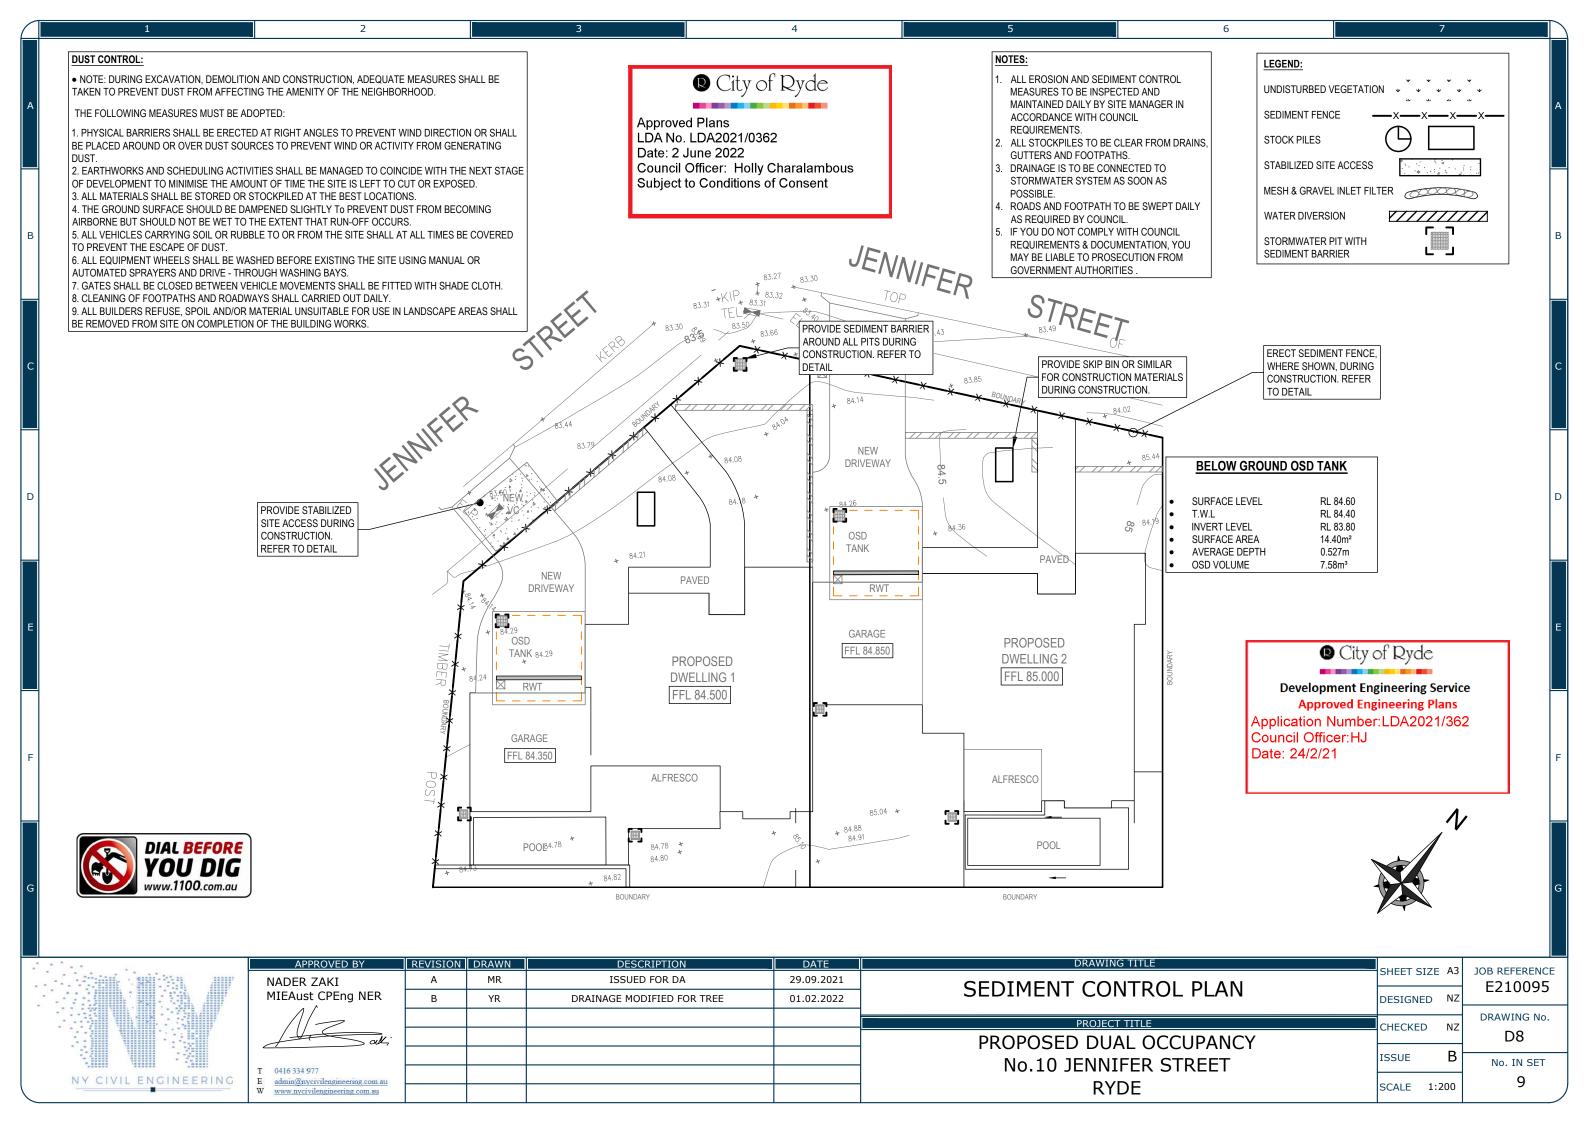

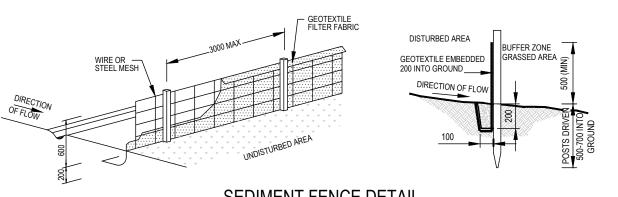

SEDIMENT FENCE DETAIL

CONSTRUCTION NOTES:

- CONSTRUCT SEDIMENT FENCES AS CLOSE AS POSSIBLE TO BEING PARALLEL TO THE CONTOURS OF THE SITE, BUT WITH SMALL RETURNS AS SHOWN IN THE DRAWING TO LIMIT THE CATCHMENTS AREA OF ANY ONE SECTION. THE CATCHMENTS AREA SHOULD BE SMALL ENOUGH TO LIMIT WATER FLOW IF CONCENTRATED AT ONE POINT TO 50 LITRES PER SECOND IN THE DESIGN STORM EVENT, USUALLY THE 10 YEAR EVENT
- CUT A 150mm DEEP TRENCH ALONG THE UPSLOPE LINE OF THE FENCE FOR THE BOTTOM OF THE FABRIC TO BE ENTRENCHED.
- DRIVE 1.5m LONG STAR PICKETS INTO GROUND AT 2.5m INTERVALS (MAX) AT THE DOWNSLOPE EDGE OF THE TRENCH. ENSURE ANY STAR PICKETS ARE FITTED WITH SAFETY CAPS.
- FIX SELF-SUPPORTING GEOTEXTILE TO THE UPSLOPE SIDE OF THE POSTS ENSURING IT GOES TO THE BASE OF THE TRENCH. FIX THE GEOTEXTILE WITH WIRE TIES OR AS RECOMMENDED BY THE MANUFACTURER. ONLY USE GEOTEXTILE SPECIFICALLY PRODUCED FOR SEDIMENT FENCING. THE USE OF SHADE CLOTH FOR THIS PURPOSE IS NOT SATISFACTORY.
- JOIN SECTIONS OF FABRIC AT A SUPPORT POST WITH 150mm OVERLAP.

BACKFILL THE TRENCH OVER THE BASE OF THE FABRIC AND COMPACT IT THOROUGHLY OVER THE GEOTEXTILE.



Approved Plans LDA No. LDA2021/0362 Date: 2 June 2022


Council Officer: Holly Charalambous Subject to Conditions of Consent



Development Engineering Service Approved Engineering Plans

Application Number: LDA2021/362 Council Officer:HJ

Date: 24/2/21

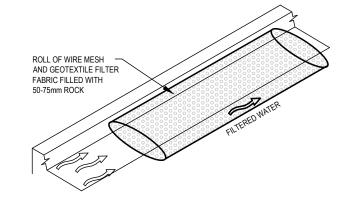


MESH AND GRAVEL FILTER

- INSTALL FILTERS TO KERB INLETS ONLY AT SAG POINTS
- FABRICATE A SLEEVE MADE FROM GEOTEXTILE OR WIRE MESH LONGER THAN THE LENGTH OF THE INLET PIT AND FILL IT WITH 25mm TO 50mm GRAVEL.
- FORM AN ELLIPTICAL CROSS-SECTION ABOUT 150mm(h) x 400mm(w).
- PLACE THE FILTER AT THE OPENING LEAVING AT LEAST 100mm SPACE BETWEEN IT AND THE KERB INLET. MAINTAIN THE OPENING WITH SPACER BLOCKS.
- FORM A SEAL WITH THE KERB TO PREVENT SEDIMENT BYPASSING THE FILTER

-BERM (0.3m MIN, HEIGHT


SANDBAGS FILLED WITH GRAVEL CAN SUBSTITUTE FOR THE MESH OR GEOTEXTILE PROVIDING THEY ARE PLACED SO THAT THEY FIRMLY ABUT EACH OTHER AND SEDIMENT-LADEN WATERS CANNOT PASS BETWEEN.

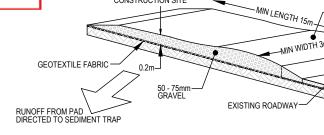

-STABILIZE STOCKPILE SURFACE -SEDIMENT FENCE DIVERSION

STOCKPILE

- PLACE STOCKPILES MORE THAN 2 (PREFERABLY 5) METERS FROM EXISTING VEGETATION, CONCENTRATED WATER FLOW, ROADS AND HAZARD AREAS.
- CONSTRUCT ON THE CONTOUR AS LOW, FLAT, ELONGATED MOUNDS. WHERE THERE IS SUFFICIENT AREA, TOPSOIL STOCKPILES SHALL BE LESS THAN 2
- METERS IN HEIGHT WHERE THEY ARE TO BE IN PLACE FOR MORE THAN 10 DAYS, STABILIZE FOLLOWING
- THE APPROVED ESCP OR SWMP TO REDUCE THE C-FACTOR TO LESS THAN 0.10. CONSTRUCT EARTH BANKS (LOW FLOW) ON THE UPSLOPE SIDE TO DIVERT WATER AROUND STOCKPILES AND SEDIMENT FENCES 1 TO 2 METERS ON THE DOWNSLOPE

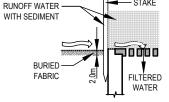

SEDIMENT BARRIER AROUND PIT

- FABRICATE A SEDIMENT BARRIER MADE FROM GEOTEXTILE OR STRAW BALES
- FOLLOW STRAW FILTER AND SEDIMENT FENCE FOR INSTALLATION PROCEDURES FOR THE STRAW BALES OR GEOFABRIC. REDUCE THE PICKET SPACING TO 1 METRE CENTRES.
- IN WATERWAYS, ARTIFICIAL SAG POINTS CAN BE CREATED WITH SANDBAGS OR EARTH BANKS AS SHOWN IN THE DRAWING.
- DO NOT COVER THE INLET WITH GEOTEXTILE UNLESS THE DESIGN IS ADEQUATE TO ALLOW FOR ALL WATERS TO BYPASS IT

STABILIZED SITE ACCESS

CONSTRUCTION NOTES:

THE SEDIMENT FENCE

- STRIP THE TOPSOIL, LEVEL THE SITE AND COMPACT THE SUBGRADE COVER THE AREA WITH NEEDLE-PUNCHED GEOTEXTILE CONSTRUCT A 200mm THICK PAD OVER THE GEOTEXTILE USING ROAD
- BASED OR 30mm AGGREGATE ENSURE THE STRUCTURE IS AT LEAST 15m LONG OR TO BUILD ALIGNMEN
- AND AT LEAST 3 METERS WIDE WHERE A SEDIMENT FENCE JOINS ONTO THE STABILIZED ACCESS. CONSTRUCT A HUMP IN THE STABILIZED ACCESS TO DIVERT WATER TO

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	NY CIVIL ENGINEERING	I

ISSUED FOR DA 29.09.2021 NADER ZAKI MIEAust CPEng NER DRAINAGE MODIFIED FOR TREE YR 01.02.2022

SEDIMENT CONTROL DETAILS

PROPOSED DUAL OCCUPANCY No.10 JENNIFER STREET **RYDE**

JOB REFERENCE SHEET SIZE A3 E210095 DESIGNED NZ DRAWING No.

CHECKED В ISSUE

SCALE AS NOTED

D9 No. IN SET