
SHEET	<u>TITLE</u>
001	Cover
002	Site Plan
003	Landscaping plan
004	Site Analysis / Waste Management Plan
005	Ground Floor Plan
006	First Floor Plan
007	Elevations
800	Elevations
009	Section
010	Acoustic Details
011	Electrical Plan
012	Notification Plan
013	Shadows
014	Demolition Plan

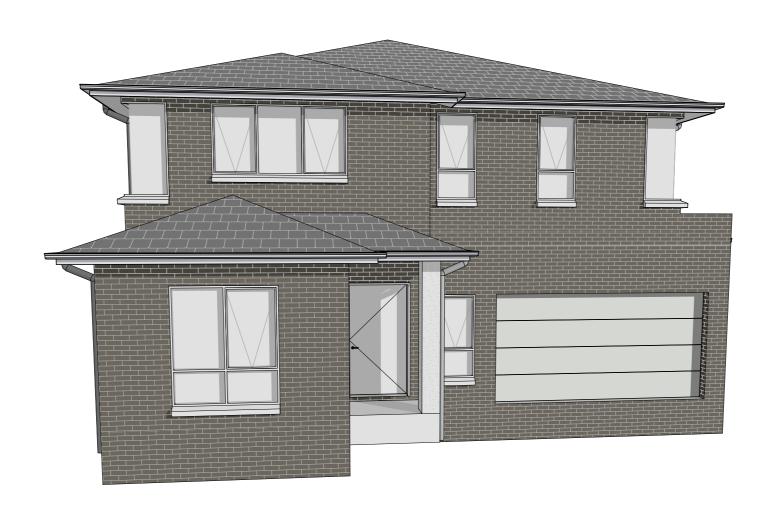

NOTES

DIMENSIONS ARE NOT TO BE SCALED FROM THE DRAWING

- ALL DIMENSIONS ARE IN MILLIMETRES. ALL LEVELS ARE TO AHD.
- ALL DIMENSIONS AND LEVELS ARE TO BE CHECKED AND VERIFIED BEFORE PROCEEDING WITH ANY OF THE WORKS.
- THE CONTRACTOR IS TO SET OUT AND MAINTAIN THE WORKS IN ACCORDANCE WITH THE DRAWINGS AND THE REQUIREMENTS OF ALL RELEVANT AUTHORITIES.
- ALL STRUCTURAL WORKS SHALL BE CARRIED OUT IN ACCORDANCE WITH THE STRUCTURAL ENGINEER'S DETAILS AND SPECIFICATIONS.
- ALL WORK SHALL BE CARRIED OUT STRICTLY IN ACCORDANCE WITH THE
- REQUIREMENTS OF THE BUILDING CODE OF AUSTRALIA, LOCAL AUTHORITY REQUIREMENTS AND ALL STANDARDS COVERING EACH TRADE.
- STORMWATER IS TO DISCHARGE INTO DESIGNATED DISCHARGE POINT TO PCA REQUIREMENTS
- SEWER DISCHARGE IS TO BE IN ACCORDANCE WITH LOCAL AUTHORITY REQUIREMENTS.
- ALL GROUND LINES ARE TO BE VERIFIED ON SITE BY THE CONTRACTOR FINAL LOCATION OF ALL STRUCTURES ARE TO BE VERIFIED ON SITE BY A REGISTERED
- FINISHED FLOOR LEVELS (FFL'S) MAY VARY +/- 200mm FROM THOSE INDICATED ON THE DRAWINGS DUE TO SITE CLEARING, DEMOLITION, CONTOUR INCONSISTENCIES ETC. GARAGE AND DRIVEWAY PROFILES MUST ALWAYS COMPLY TO AUSTRALIAN STANDARD'S AS 2890.
- REFER TO ENGINEERS DETAILS AND SPECIFICATIONS FOR ALL DROP EDGE BEAM AND REINFORCED CONCRETE SLAB REQUIREMENTS.
- WINDOWS SPACING SHOWN ON DRAWINGS ARE APPROXIMATE AND MAY VARY ON
- ALL DRAWINGS ARE TO BE READ IN CONJUNCTION WITH THE ENGINEERING PLANS AND SPECIFICATIONS - ALL BOUNDARY LENGTHS AND BUILDING SETBACKS ARE TO BE VERIFIED ON SITE BY A
- REGISTERED SURVEYOR PRIOR TO CONSTRUCTION. ALL DETAILS, STANDARDS, CODES AND CLASSIFICATIONS REFERRENCED IN THE CONSTRUCTION SPECIFICATION ARE TO BE REVIEWED AND CONFIRMED BY EACH

RELEVANT INDUSTRY PROFESSIONAL PRIOR TO CONSRUCTION

- EXTERNAL WINDOWS INCLUDING SUIDING DOORS WITH FRAMES AD HITSTARLE LOUVERS AND WINDOW WALLS WITH ONE PIECE FRAMING SHALL BE DESIGNED AND CONSTRUCTED IN ACCORDANCE WITH AS2047- WINDOWS IN BUILDINGS - SELECTION AND INSTALLATION
- SMOKE ALARMS SHALL BE DESIGNED AND CONSTRUCTED IN ACCORDANCE WITH PARTS 3.7.5.1 TO 3.7.2.6 (ACCEPTABLE CONSTRUCTION PRACTICE) OF THE NCC.
- HEATING AND APPLIANCES
- WET AREAS
- WET AREAS SHALL BE CONSTRUCTED TO BE WATERPROOF OR WATER RESISTANT IN ACCORDANCE WITH AS3740 WATERPROOFING OF DOMESTIC WET AREAS ROOM HEIGHTS CEILING HEIGHTS SHALL BE CONSTRUCTED IN ACCORDANCE WITH PART 3.8.2 (ACCEPTABLE CONSTRUCTION PRACTICE) OF THE NCC
- **FACILITIES** FACILITIES SHALL BE CONSTRUCTED IN ACCORDANCE WITH PART 3.8.3 (ACCEPTABLE CONSTRUCTION PRACTICE) OF THE NCC.
- LIGHTS LIGHTING SHALL BE PROVIDED IN ACCORDANCE WITH PART 3,8.4 (ACCEPTABLE CONSTRUCTION PRACTICE) OF THE NCC.
- VENTILATION VENTILATION SHALL BE PROVIDED IN ACCORDANCE WITH PART 3.8.5 (ACCEPTABLE CONSTRUCTION PRACTICE) OF THE NCC WIND LOADS
 - THE ENTIRE BUILDING SHALL BE CONSTRUCTED TO WITHSTAND THE LOADS IMPOSED BY THE WIND SPEED CLASS APPLICABLE TO THIS SITE THE ENTIRE BUILDING SHALL BE CONSTRUCTED IN ACCORDANCE WITH PART 3.10.1.0 (ACCEPTABLE CONSTRUCTION PRACTICE) OF THE NCC.
- INSULATION THERMAL INSULATION SHALL BE INSTALLED IN THE BUILDING FABRIC IN ACCORDANCE WITH NSW PART 3.12.1.1 OF THENCC.
- MASONRY UNREINFORCED MASONRY, REINFORCED MASONRY, MASONRY ACCESSORIES, WEATHERPROOFING OF MASONRY, MANONRY VENEER AND ISLOATED MASONRY SHALL BE DESIGNED AND INSTALLED IN ACCORDANCE WITH AS3700 - MASONRY STRUCTURES AND 3.3.1 TO 3.3.6 OF NCC
- TIMBER FRAMING TIMBER FRAMING SHALL BE DESIGNED AND CONSTRUCTED IN ACCORDANCE WITH AS 1684.2 - RESIDENTIAL TIMBER FRAMED CONSTRUCTION - NON CYCLONIC AREAS
 - TIMBER FRAMING SHALL BE DESIGNED AND CONSTRUCTED IN ACCORDANCE WITH THE DETAILS AND SPECIFICATIONS PROVIDED BY A PRACTICING STRUCTURAL ENGINEER.
- PRE-FABRICATED WALL FRAMES AND ROOF TRUSSES SHALL BE DESIGNED AND CONSTRUCTED IN ACCORDANCE WITH THE STRUCTURAL ENGINEERS DETAILS AND SPECIFICATION PROVIDED BY THE MANUFACTURER. ROOF CLADDING
- ROOF TILES SHALL BE INSTALLED IN ACCORDANCE WITH AS2049 ROOF TILES AND AS2050 INSTALLATION OF ROOF TILES.
- ROOF TILES SHALL BE INSTALLED IN ACCORDANCE WITH PART 3.5.2 (ACCEPTABLE CONSTRUCTION PRACTICE) OF THE NCC. ROOF SHEETING SHALL BE INSTALLED IN ACCORDANCE WITH PART 3.5.1 (ACCEPTABLE CONSTRUCTION PRACTICE) OF THE NCC.
 - GUTTERS AND DOWNPIPES SHALL BE DESIGNED AND INSTALLED IN ACCORDANCE WITH PARTS 3.5.2.1 TO 3.5.2.5 (ACCEPTABLE CONSTRUCTION PRACTICE) OF THE NCC

CONSTRUCTION SPECIFICATION

- TIMBER AND COMPOSITE WALL CLADDING SHALL BEINSTALLED IN ACCORDANCE WITH PART 3.5.4 (ACCEPTABLE CONSTRUCTION PRACTICE) OF THE NCC.
- METAL WALL CLADDING SHALL BEINSTALLED IN ACCORDANCE WITH PART 3.5.5 (ACCEPTABLE CONSTRUCTION PRACTICE) OF THE NCC
- ALL EARTHWORKS SHALL BE CARRIED OUT IN ACCORDANCE WITH PART 3.1.1 OF THE NCC.
- ALL EARTHWORKS SHALL BE CARRIED OUT IN ACCORDANCE WITH THE DETAILS AND SPECIFICATIONS PROVIDED BY A PRACTICING STRUCTURAL ENGINEER.
- ALL DRAINAGE WORKS SHALL BE CARRIED OUT IN ACCORDANCE WITH AS/NZS 3500.5 DOMESTIC INSTALLATIONS STORMWATER DRAINAGE
- SURFACE WATER DRAINAGE, SUBSOIL WATER DRAINAGE AND STORMWATER DRAINAGE SHALL BE CARRIED OUT IN ACCORDANCE WITH PARTS 3.1.3 OF THE NCC.
- TERMITE BARRIERS SHALL BE INSTALLED TO MINIMISE THE RISK OF TERMITE ATTACK TO PRIMARY BUILDING ELEMENTS IN ACCORDANCE WITH AS3660.1 TERMITE MANAGEMENT NEW BUILDING WORK TERMITE BARRIERS SHALL BE INSTALLED TO MINIMISE THE RISK OF TERMITE ATTACK TO PRIMARY BUILDING ELEMENTS FOR CONCRETE SLABS ON GROUND IN ACCORDANCE WITH PARTICLE AND ACCORDANCE WITH PARTICLE
- 3.1.4 OF THE NCC. TERMITE BARRIER'S SHALL BE INSTALLED TO MINIMISE THE RISK OF TERMITE ATTACK TO PRIMARY BUILDING ELEMENTS FOR SUSPENDED FLOORS IN ACCORDANCE WITH PART 3.1.4 OI
- ATTACHMENTS TO BUILDINGS SHALL BE INSTALLED TO MINIMISE THE RISK OF TERMITE ATTACK TO PRIMARY BUILDING ELEMENTS IN ACCORDANCE WITH PART 3,1,4 OF THE NCC.
- OOTINGS AND SLABS
- FOOTINGS AND SLABS SHALL BE DESIGNED AND INSTALLED IN ACCORDANCE WITH AS2870 RESIDENTIAL SLABS AND FOOTINGS CONSTRUCTION
- FOOTINGS AND SLABS SHALL BE DESIGNED BY A PRACTICING STRUCTURAL ENGINEER IN ACCORDANCE WITH AS2870 RESIDENTIAL SLABS AND FOOTINGS CONSTRUCTION. FOOTINGS AND SLABS SHALL BE DESIGNED AND INSTALLED IN ACCORDANCE WITH PARTS 3,2,2 TO 3,2,5 OF THE NCC
- BUILDING SEALING
- THE BUILDING SHALL BE SEALED IN ACCORDANCE WITH NSW PART 3.12.3 OF THE NCC.

BUILDING SERVICES

- BUILDING SERVICES (THE HOTWATER SERVICE) SHALL BE DESIGNED AND INSTALLED IN ACCORDANCE WITH NSW PART 3.12.5 OF THE NCC.
- STAIR REQUIREMENTS: RISER 190MM MAXIMUM, 115MM MINIMUM. GOING 355MM MAXIMUM 240MM MINIMUM (DOMESTIC ONLY) RISERS AND TREADS TO BE CONSTANT IN SIZE THROUGH FLIGHT, PROVIDE NON-SLIP FINISH OR SUITABLE NON-SKID STRIP NEAR EDGE OF NOSING TO NCC TABLE 3.9.1.2. COMPARTMENT
- W.C. DOORS TO TOILET PANS LOCATED WITHIN 1,2M OF THE DOOR JAMB, LIFT OFF HINGES SHALL BE FITTED, OTHERWISE THE DOORS MUST SWING OUTWARDS AS PER 3,8,3,3 OF THE NCC

2/08/2022

SEPARATING WALL
- PARTY WALL TO COMPLY WITH BCA FIRE SEPERATION PART 3.7.1 TO 3.7.5& SOUND INSULATION PART 3.8.6 OF THE NCC

- BARRIERS AND HANDRAILS BARRIERS AND HANDRAILS SHALL BE INSTALLED IN ACCORDANCE WITH PART 3,9,2 OF THE NCC



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- DIMENSIONS TAKE PREFERENCE . BOUNDARIES TO BE VERIFIED BY SURVEYOR.
- OTHER CONSULTANT DRAWINGS TAKE PREFERENCE. DRAINAGE TO COUNCIL'S REQUIREMENTS AND AS 3500

LODGEMENT DA ONLY COUNCIL RYDE DESIGN: CUSTOM DATE:

DRAWING TITLE Cover DP No: SITE ADDRESS

LOT 13, NO.23A EPPING ROAD NORTH RYDE

CLIENT NAMES : **CRYSTELE HOMES**


VERSION No: FP2 Scale

KP22-119

DRWG No:

001

1:100

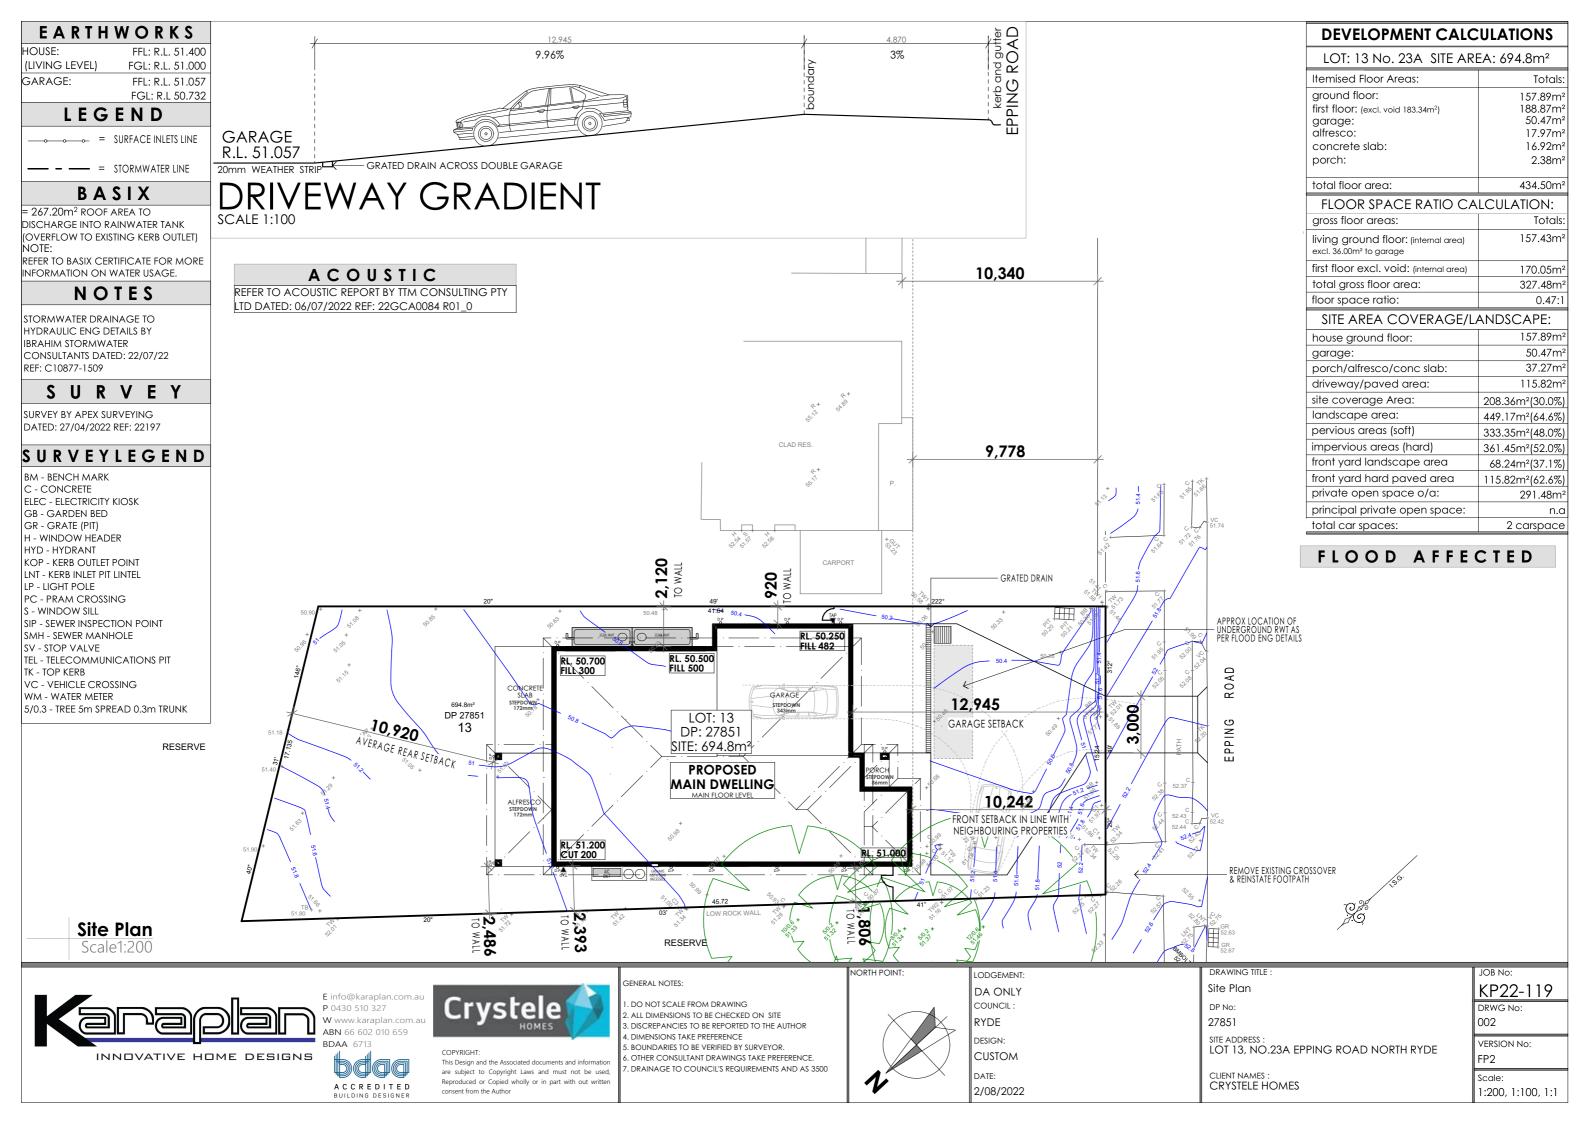



Typical Letterbox Detail




letterbox or similar (Note: Letterbox by owner) blend with materials or similar




Basix commitments Total area of vegetation 325.35m² Total area of indigenous planting $0.00m^{2}$ Total area of washed pebbles 8.00m² or similar

Notes:


- It is the owners responsibility to ensure all landscaping including schedule of planting and maintenance complies with local government requirements and guidelines.

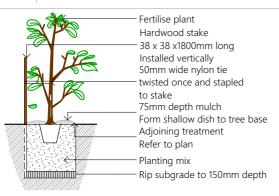

15-45 Litre tree planting detail

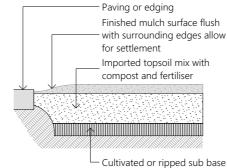


Ground preparation Planting area using imported soil

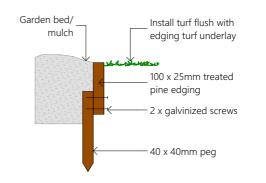


LODGEMENT

Typical edging detail

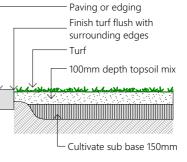

Ground preparation Grassed area; turf using imported topsoil

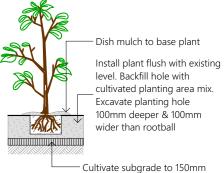

Planting in garden beds

INNOVATIVE HOME DESIGNS

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OTHER CONSULTANT DRAWINGS TAKE PREFERENCE. DRAINAGE TO COUNCIL'S REQUIREMENTS AND AS 3500



DA ONLY COUNCIL RYDE DESIGN: **CUSTOM** DATE: 2/08/2022

DRAWING TITLE : Landscaping plan DP No: 27851 SITE ADDRESS : LOT 13, NO.23A EPPING ROAD NORTH RYDE

CLIENT NAMES : CRYSTELE HOMES

KP22-119 DRWG No: 003 VERSION No: FP2

Scale: 1:200



membrane and temp, backfill to restore prior natural ground surface level

Silt fence detail (Typical Section)

Plastic safety cap 50 x 50 x 1000mm Stake or star picket Propex siltstop sediment


control fabric

Bury approx. 150mm of


Straw bale impaled on star picket

placed firmly into ground 2 star pickets per straw bale Straw bale to be re-bound with - metal packing strip prior to placement Rock drill hole 300mm deep and grout star pickets or 2 x 16mm reinforcement bars as option to star pickets.

Straw bale barrier (Typical Section)

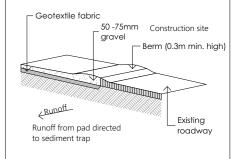

Temporary construction exit

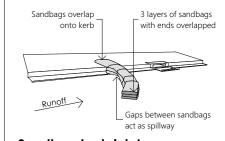

Sandbag kerb inlet sedimentation trap

Notes:

<u>Dust Control measures</u>

- If the site becomes dusty during hotter months Lifestyle designer Homes will sprinkle water on the dust.
- Any area of road base will be positioned for heavy vehicles to reduce and provide an area to wash trucks (as required).

Noise and vibration measures

- All excavation will be carried out between the time setout in the council conditions.
- Machinery size will be kept to a

minimum required for the job.

INNOVATIVE HOME DESIGNS

Site Analysis/ Waste Management Plan

Scale1:200

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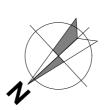
GENERAL NOTES:

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DISCREPANCIES TO BE REPORTED TO THE AUTHOR DIMENSIONS TAKE PREFERENCE . BOUNDARIES TO BE VERIFIED BY SURVEYOR.

OTHER CONSULTANT DRAWINGS TAKE PREFERENCE. DRAINAGE TO COUNCIL'S REQUIREMENTS AND AS 3500



NORTH POINT

LODGEMENT: DA ONLY COUNCIL: RYDE DESIGN: **CUSTOM** DATE: 2/08/2022

Site Analysis / Waste Management Plan DP No: 27851 SITE ADDRESS : LOT 13, NO.23A EPPING ROAD NORTH RYDE


CLIENT NAMES : CRYSTELE HOMES


DRWG No: 004 VERSION No: FP2


Scale:

1:200

KP22-119

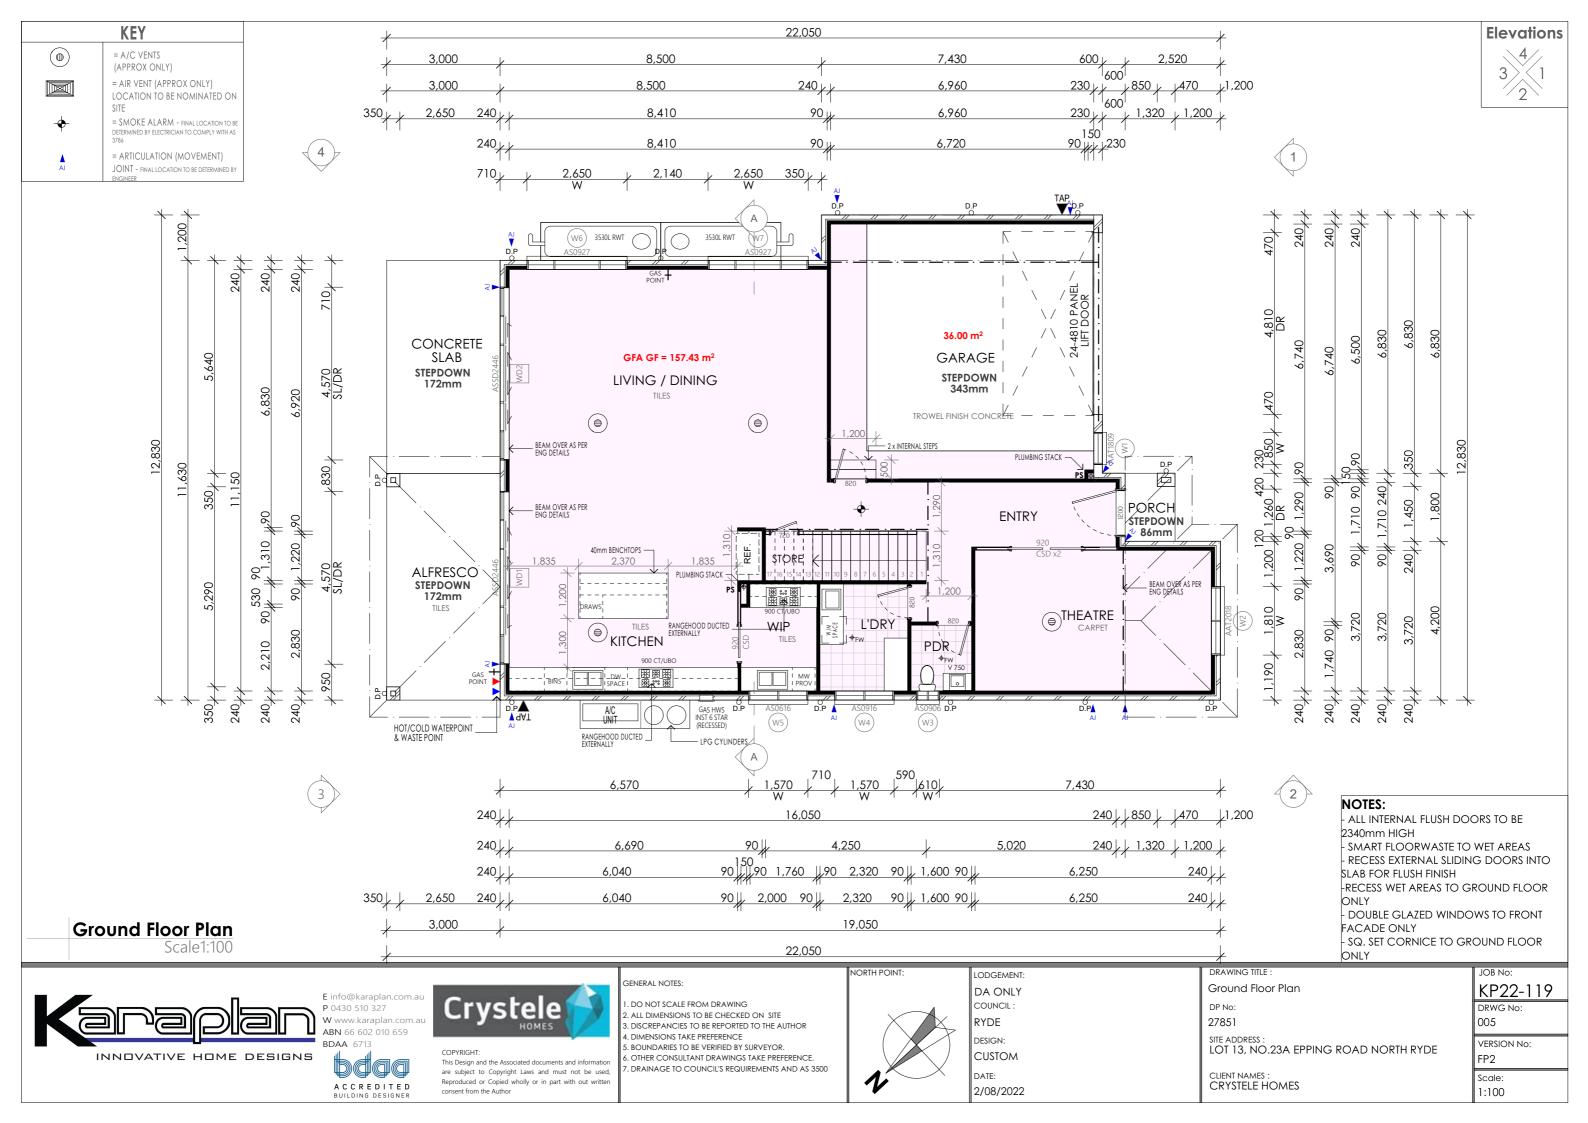

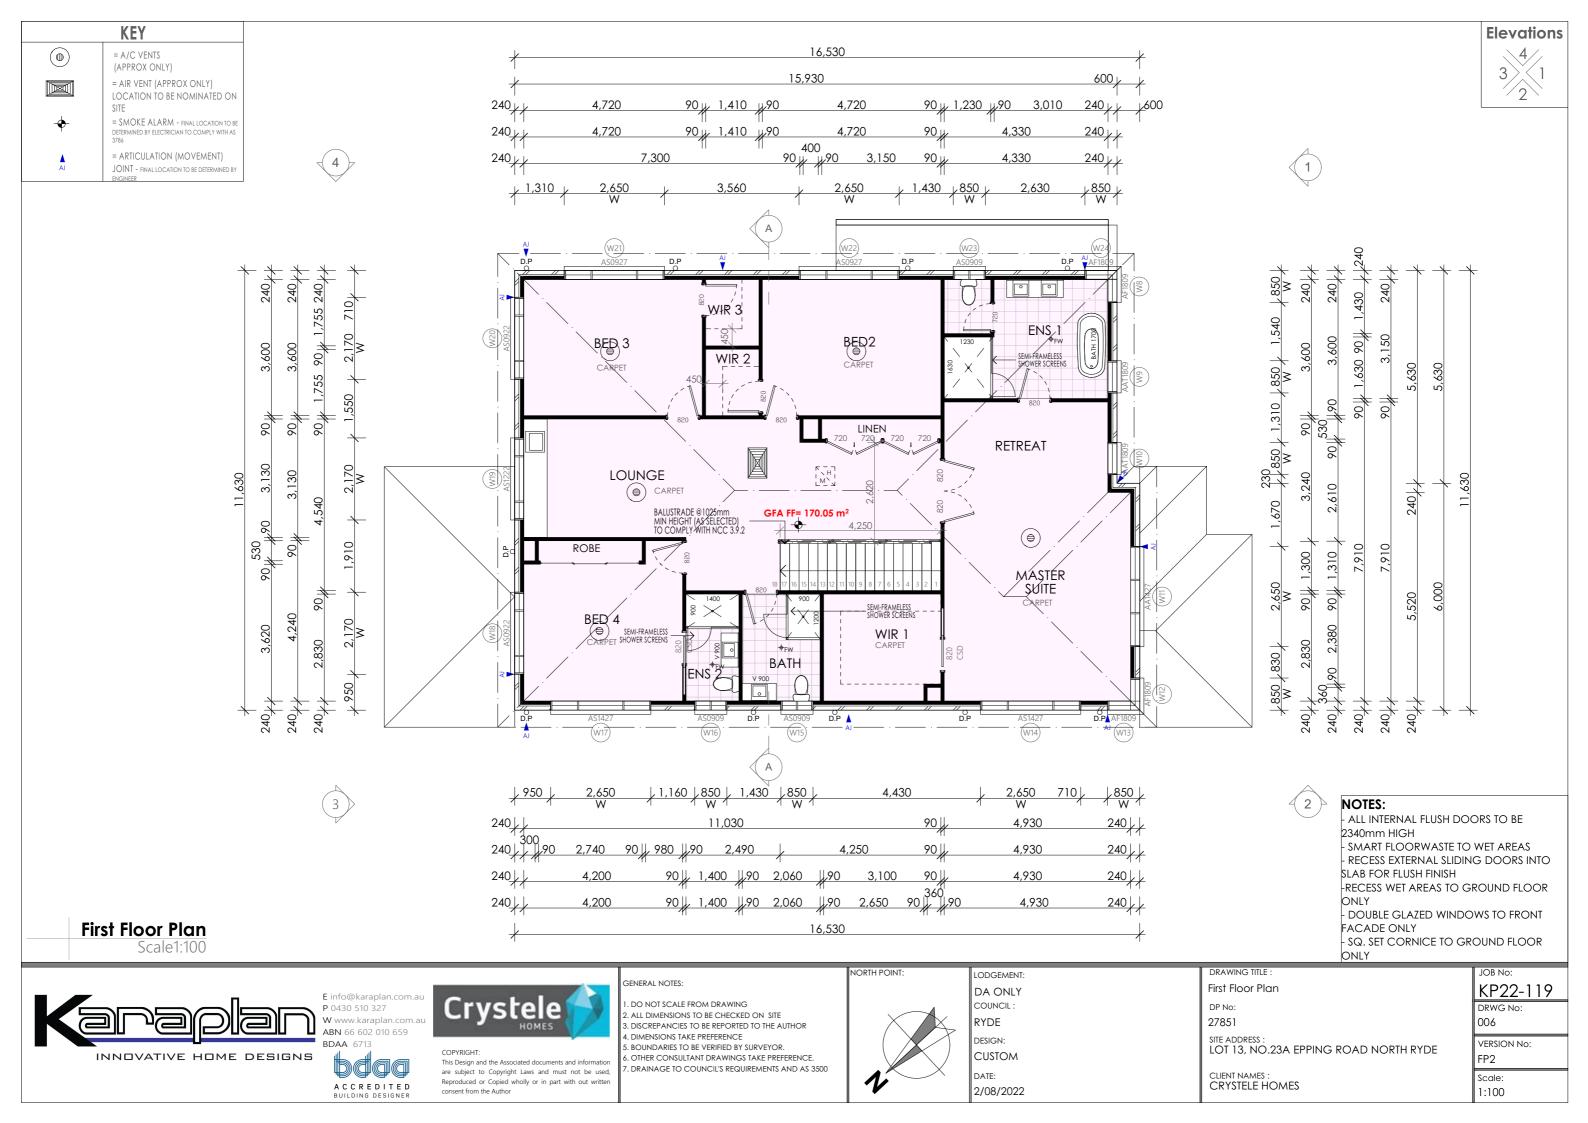

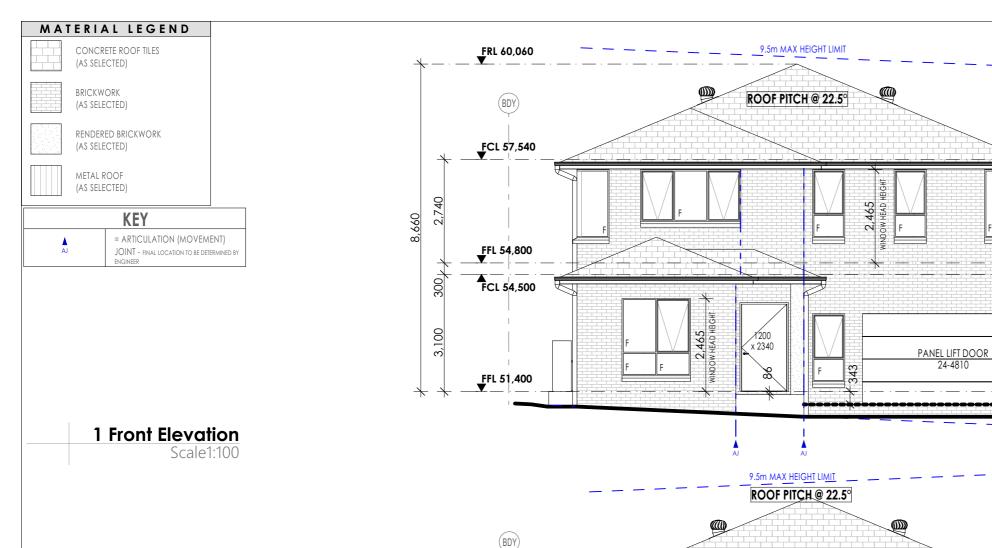



3 Rear Elevation



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A C C R E D I T E D BUILDING DESIGNER



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5. BOUNDARIES TO BE VERIFIED BY SURVEYOR.
5. OTHER CONSULTANT DRAWINGS TAKE PREFERENCE.
7. DRAINAGE TO COUNCIL'S REQUIREMENTS AND AS 3500

LODGEMENT: DA ONLY COUNCIL: RYDE DESIGN: CUSTOM DATE: 2/08/2022

NORTH POINT:

(BDY)

FCL 57,540

FFL 54,800

FCL 54,500

− FFL 51,057 ·

450

DRAWING TITLE : Elevations


DP No: 27851


site address : LOT 13, NO.23A EPPING ROAD NORTH RYDE


CLIENT NAMES : CRYSTELE HOMES

KP22-119 DRWG No: 007

VERSION No: FP2 Scale: 1:100

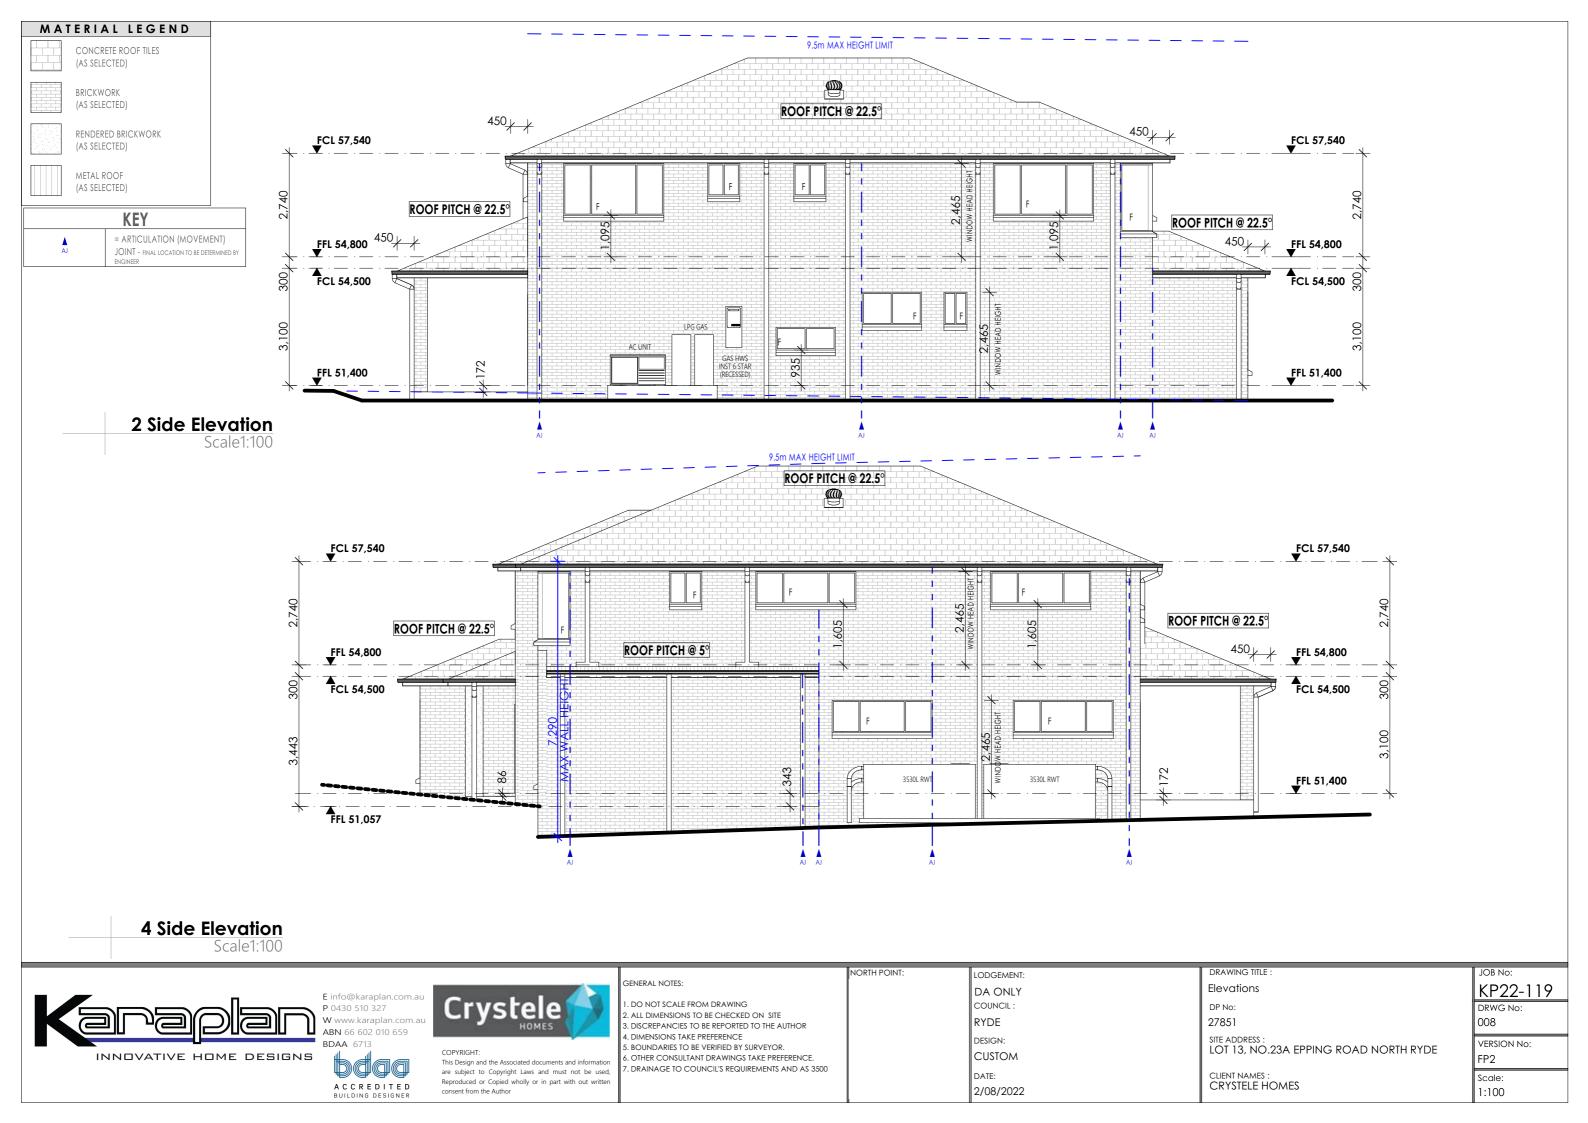

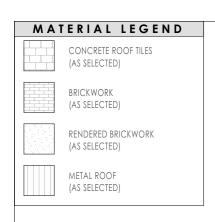

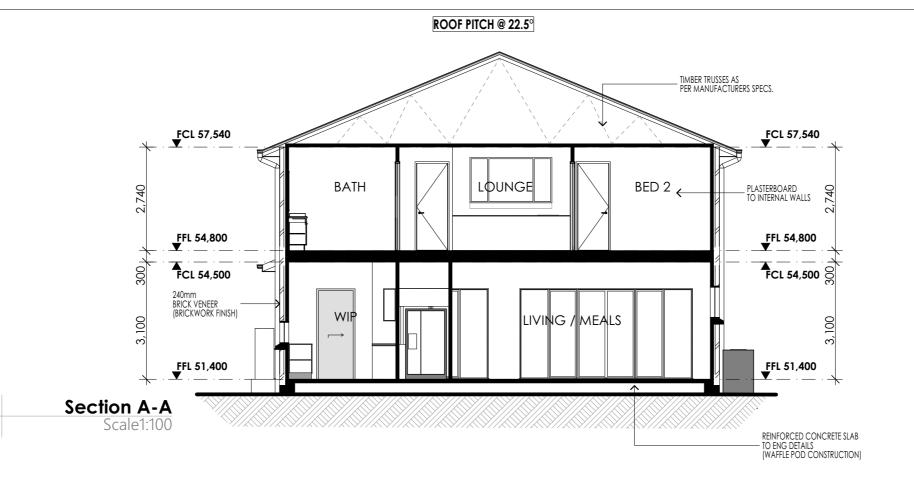

Window List					
No.	Height	Width	Head height		
W1	1,800	850	2,400		
W2	2,050	1,810	2,465		
W3	860	610	2,465		
W4	860	1,570	2,465		
W5	600	1,570	1,535		
W6	860	2,650	2,465		
W7	860	2,650	2,465		
W8	1,800	850	2,465		
W9	1,800	850	2,465		
W10	1,800	850	2,465		
W11	1,370	2,650	2,465		
W12	1,800	850	2,465		
W13	1,800	850	2,465		
W14	1,370	2,650	2,465		
W15	860	850	2,465		
W16	860	850	2,465		
W17	1,370	2,650	2,465		
W18	860	2,170	2,465		
W19	1,200	2,170	2,465		
W20	860	2,170	2,465		
W21	860	2,650	2,465		
W22	860	2,650	2,465		
W23	860	850	2,465		
W24	1,800	850	2,465		
WD1	2,400	4,570	2,400		
WD2	2,400	4,570	2,400		



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5. BOUNDARIES TO BE VERIFIED BY SURVEYOR. 6. OTHER CONSULTANT DRAWINGS TAKE PREFERENCE. DRAINAGE TO COUNCIL'S REQUIREMENTS AND AS 3500

LODGEMENT: DA ONLY COUNCIL: RYDE DESIGN: CUSTOM DATE: 2/08/2022

NORTH POINT:

DRAWING TITLE : Section DP No: 27851

site address : LOT 13, NO.23A EPPING ROAD NORTH RYDE

CLIENT NAMES : CRYSTELE HOMES

Water

- Rainwater tank of at least 5,000L to be installed.
- Rainwater tank to meet and be installed in accordance with applicable regulatory authorities.

Basix NO. 13187998

- Rainwater tank to collect rain runoff from roof area depicted in BASIX certificate.
- Rainwater tank supply to be connected to all toilets in dwelling.
- Rainwater tank to be connected to at least one outdoor tap in the dwelling.

Tap fittings			
Kitchen	3 star		
Shower head	3 star (7.5 BUT<=9L/MIN)		
Toilet rating (dual flush)	4 star		
Vanity and bath	3 star		

Thermal Comfort			
External walls	Brick Veneer		
Frame	Timber		
External wall insulation	R 2.0		
External wall colour	Medium		
Roofing material	Concrete Tiles		
Roof insulation	Sarking		
Roof colour	Medium		
Ceiling insulation	R 3.5		

Energy

- Gas 6 star instantaneous hot water system.
- Gas cooktop to Kitchen.
- Electric oven to Kitchen.
- Outdoor clothes line.

KP22-119 DRWG No: 009 VERSION No: FP2 Scale: 1:100

1. Noise Criteria

Internal noise levels of the dwelling are to achieve those specified in Development near Rail Corridors and Busy Roads - Interim Guideline, Internal noise levels specified in the Guideline are expressed as Land levels and are reproduced in Table 1 below.

Table 1: Internal Noise Limits from Development near Rail Corridors and Busy Roads - Interim Guideline

Toront Commence	Residential Buildings			
Type of Occupancy	Design Sound Level, dB(A)	Applicable time period		
Sleeping areas (bedroom)	35	Night 10pm to 7am		
Other habitable rooms (excluding bathrooms)	40	At any time		

2. Predicted Noise Levels

The site is located in proximity to a major road corridor (M2 Motorway) as defined by Clause 102 of the State Environmental Planning Policy (Infrastructure) 2007. Additionally, the site is adjacent to Epping Road which is also a significant vehicle carrying road. Both roads have been included in the noise assessment for completeness.

Based on traffic volumes obtained from TTM Data and the NSW Traffic Volume Viewer, SoundPLAN noise modelling was conducted considering a 10-year planning horizon to predict road traffic noise levels at façades of the proposed dwelling.

The predicted road traffic noise levels at habitable rooms of the dwelling are presented in Table 3. Laed (1 hour) noise level corrections were taken from measured noise levels of roads with similar traffic flows to M2 Motorway and Epping Road.

Table 2: Predicted Road Traffic Noise Levels at the Dwelling

Facade	Floor	Parama.	Predicted Noise Level, dB(A) Façade Corrected			
racade	Floor	Rooms	LA10 (18 hour)	LAeq (1 hour) Day	Laeq (1 hour) Night	
N	Ground	Living / Dining	59	59	57	
(rear)	First	Lounge, Bedroom 3, Bedroom 4	62	62	60	
E	Ground	Living / Dining	66	66	64	
	First	Bedroom 2, Bedroom 3	69	69	67	
S	Ground	Entry, Theatre	75	75	73	
(front)	First	Bedroom 1 / Retreat	77	77	75	
W	Ground	Kitchen	70	70	68	
	First	Bedroom 4	72	72	70	

ACOUSTIC

REFER TO ACOUSTIC REPORT BY TTM CONSULTING PTY LTD DATED: 06/07/2022 REF: 22GCA0084 R01_0

3. Recommendations

Building treatments were determined by using the calculation methods detailed in Australian Standard AS3671:1989 Acoustics – Road Traffic Noise Intrusion – Building Siting and Construction. Based on the architectural drawings, the recommended construction details are listed below.

3.1 Glazing Treatments

Table 3 presents the recommended glazing R_W performance specifications for the dwelling.

- . The R_W rating relates to the full glazing system including the frame, seals and the glass. Where acoustic seals are necessary, glazing will require a Q-Lon seal or equivalent product.
- . Alternative glazing may be used provided the specified R_W rating can be achieved and certified by the window manufacturer with a NATA report (on request). Generic reports should not be accepted.
- Depending on the type of window system, the framing can significantly reduce the performance. This should be investigated with the glazing supplier thoroughly (referring to NATA certified test report data) to ensure the minimum Rw is being achieved.
- It is imperative that the minimum R_W rating is achieved and that the presented glazing thickness is used as a guide only. If the glazing thickness does not comply with the R_w rating, thicker glass should be considered until the Rw rating is achieved.

Table 3: Glazing Treatments

Habitable Room	Component	Min Rw	Indicative Glazing Thickness	Acoustic seals
Living / Dining /	Sliding doors	28	5mm toughened	Yes
Kitchen	Windows	28	5mm toughened	Yes
Theatre	Windows	38	14.38mm laminate	Yes
Redroom 1	Windows (front)	40	12.5mm Viridian VLam Hush	Yes
Bedroom 1	Windows (side)	35	10.38mm laminate	Yes
Bedroom 2	Windows	35	10.38mm laminate	Yes
Bedroom 3 and	Windows (rear)	30	6.38mm laminate	Yes
Bedroom 4	Windows (side)	38	14.38mm laminate	Yes
Lounge	Windows	24	4mm float	No

All remaining glazing not stated above should be installed with a minimum of 4mm float (Rw24) for windows and 5mm toughened (R_W25) for sliding doors.

It is recommended that a glazing certificate be obtained from the glazier demonstrating that the installed glazing meets the minimum weighted sound reduction index (R_W) requirements. The certificate should be retained for certification of the completed dwelling.

3.2 Wall Construction

Brick or masonry external walls with 10mm plasterboard internally and R1.5 cavity insulation will achieve a Rw57 acoustic rating without the need for further treatment

Other wall systems may be used providing the system achieves the minimum acoustic rating.

3.3 External Penetrations

Penetrations through the walls/ceiling system to the outside shall be kept to a minimum to ensure the acoustic integrity of the system is maximised. Where penetrations must be made, they must be no larger than 10-15mm greater than the object passing through the wall. The gap shall be filled with Bostik Fireban 1 or equivalent product.

Large diameter services penetrations (greater than 50mm around the penetrating object) will require further detailed design to ensure the acoustic integrity of the wall system is not diminished. As a guide, using the plasterboard materials, close the gap to a maximum 10-15mm and generously fill the residual gap with a non-hardening fire-rated mastic.

All remaining penetrations with a gap of maximum 10-15mm around the penetrating object must be generously filled with a non-hardening fire-rated mastic.

Penetrations through noise affected walls may require specific design to provide adequate attenuation for internal compliance and should be reviewed by the acoustic consultant before final approval.

3.4 Roof/Ceiling Construction

Table 4 below details the minimum roof/ceiling constructions that are predicted to meet the required acoustic

Table 4: Recommended Roof/Ceiling Construction

Room	Roof / Ceiling Construction	Cavity Insulation	Minimum Rw
Lounge, Bedroom 2, Bedroom 3, Bedroom 4	 Pitched tiled roof with sarking under battens, Cavity insulation as per table, 1 x 13mm standard plasterboard internally. 	Minimum R3.5 insulation batts	43
Bedroom 1	 Pitched tiled roof with sarking under battens, Cavity insulation as per table, 1 x 13mm sound-rated plasterboard internally. 	Minimum R3.5 insulation batts	48

3.5 Entry Door

The entry door is required to achieve a minimum R_W33. We recommend consultation with a suitable manufacturer to determine a door system that can achieve the required rating. Alternatively, AS3671 recommends a solid-core 42mm thick plywood door, soft plastics gasket around sides and top, and a drop seal at the base. Glass planes should also achieve a minimum Rw33.

3.6 Alternative Ventilation

To achieve the required internal noise levels in noise affected habitable rooms, doors and/or windows would need to be closed. Therefore, it is recommended that consideration is given to the inclusion of alternative ventilation so that windows/doors can be closed to achieve the indoor sound levels.

Suitable forms of ventilation include air-conditioning, borrowed ventilation in accordance with the BCA, Silence Air or Aeropac noise ventilators. The plant should not reduce the acoustic performance of the building or cause intrusive noise at neighbouring properties.

4 Conclusion

The proposed dwelling at 23A Epping Road, North Ryde was designed in accordance with AS3671 to comply with the indoor sound levels stated in Section 1. Based on the inclusion of the recommendations in this report, the dwelling is predicted to comply with the relevant noise requirements.

This assessment does not imply that road traffic noise will be inaudible within a living or sleeping area.

CRYSTELE HOMES

We trust this information meets with your current requirements. Should you have any queries please do not hesitate to contact TTM.



E info@karaplan.com.au P 0430 510 327 ABN 66 602 010 659

ACCREDITED


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NORTH POINT

DA ONLY COUNCIL RYDE DESIGN: **CUSTOM** DATE:

LODGEMENT 2/08/2022 DRAWING TITLE Acoustic Details DP No: 27851 SITE ADDRESS

LOT 13, NO.23A EPPING ROAD NORTH RYDE CLIENT NAMES :


VERSION No: FP2

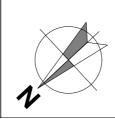010

Scale:

DRWG No:

KP22-119

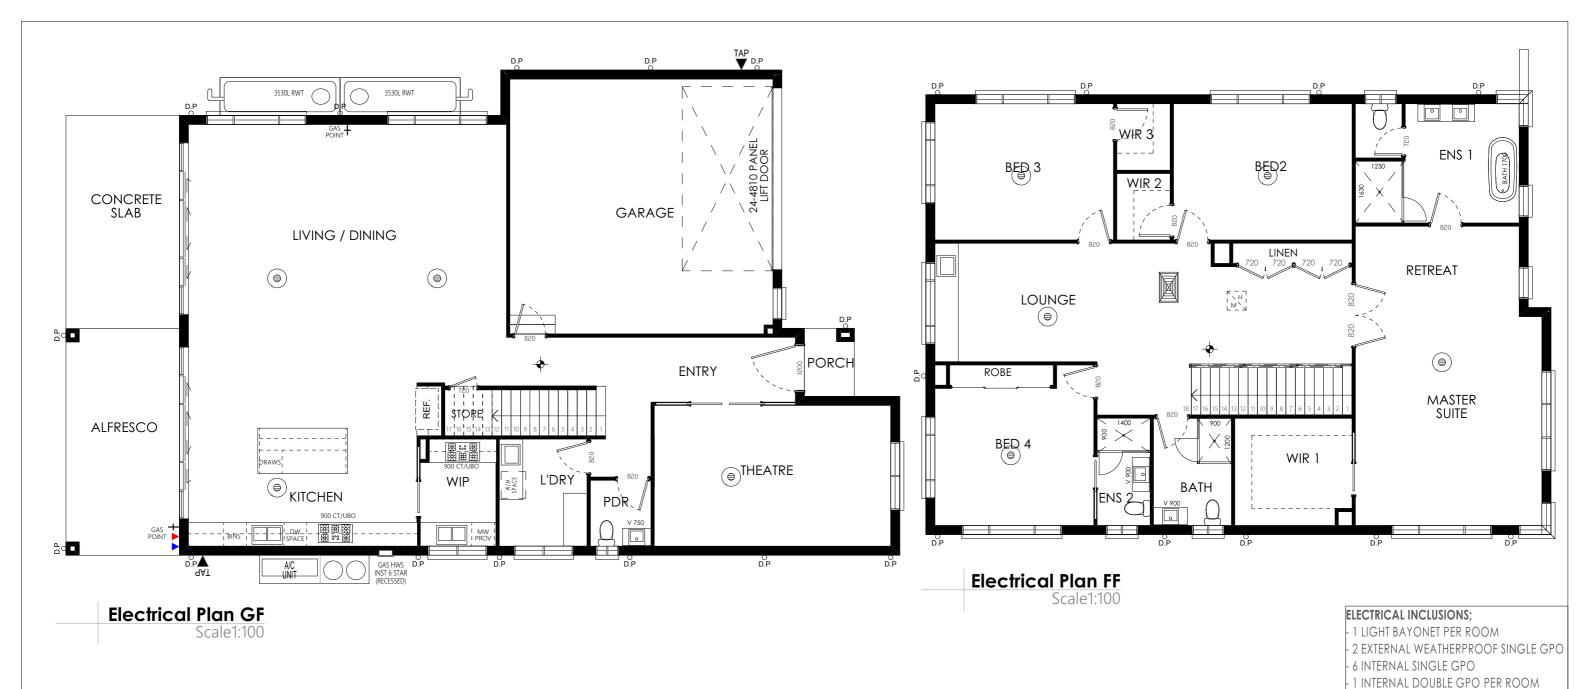



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NORTH POINT:

LODGEMENT: DA ONLY COUNCIL: RYDE DESIGN:

2/08/2022

CUSTOM DATE:

DRAWING TITLE : DP No: 27851

CLIENT NAMES : CRYSTELE HOMES

JOB No: KP22-119 DRWG No:

1 TWO-WAY SWITCH

1 DUCTING TO RANGEHOOD NBN PROVISION ONLY

- 3 PHASE POWERPOLE WITHIN LOT

ALARM SYSTEM 4xPIR, 1xKEYPAD, 1xSIREN

- 3 PHASE DUCTED AIR-CONDITIONING (10

1 TV POINT 1 PHONE POINT 1 EXHAUST FAN 2 SMOKE ALARM

UPGRADES;


BOUNDARY


VIDEO INTERCOM

OUTLETS 2 ZONES) - 30 LED DOWNLIGHTS

> Scale: 1:100

Electrical Plan 011 SITE ADDRESS : LOT 13, NO.23A EPPING ROAD NORTH RYDE VERSION No: FP2

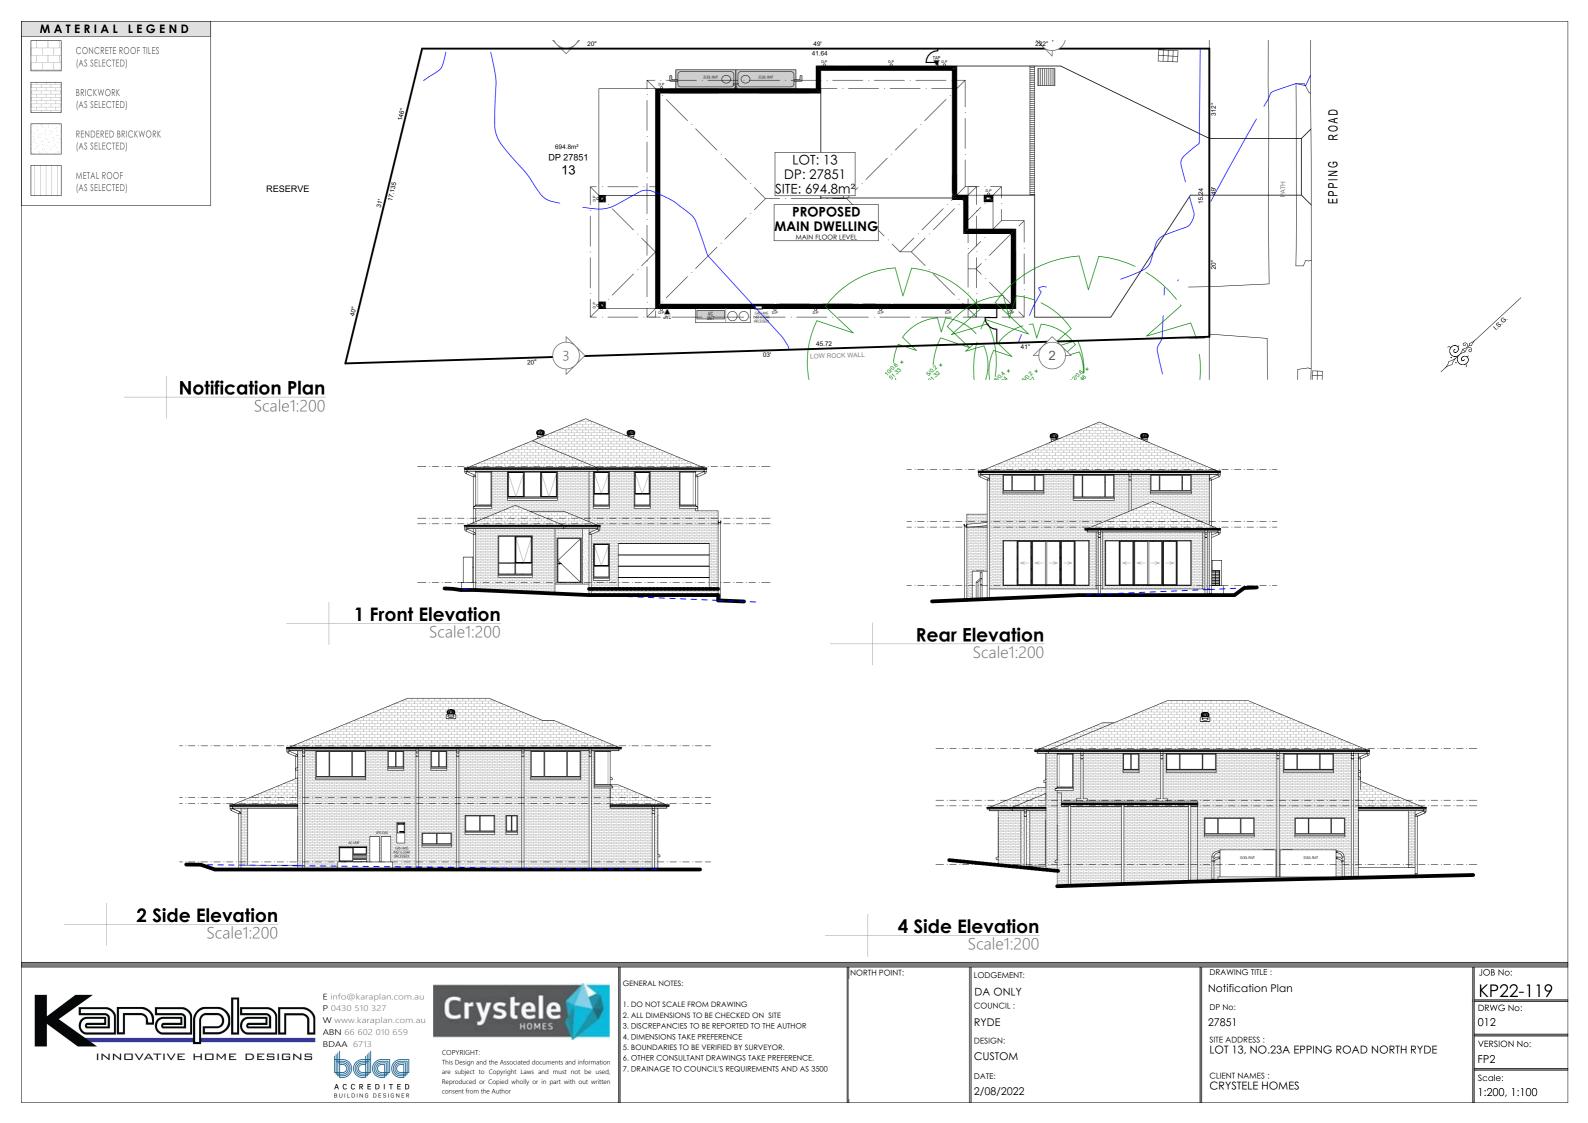

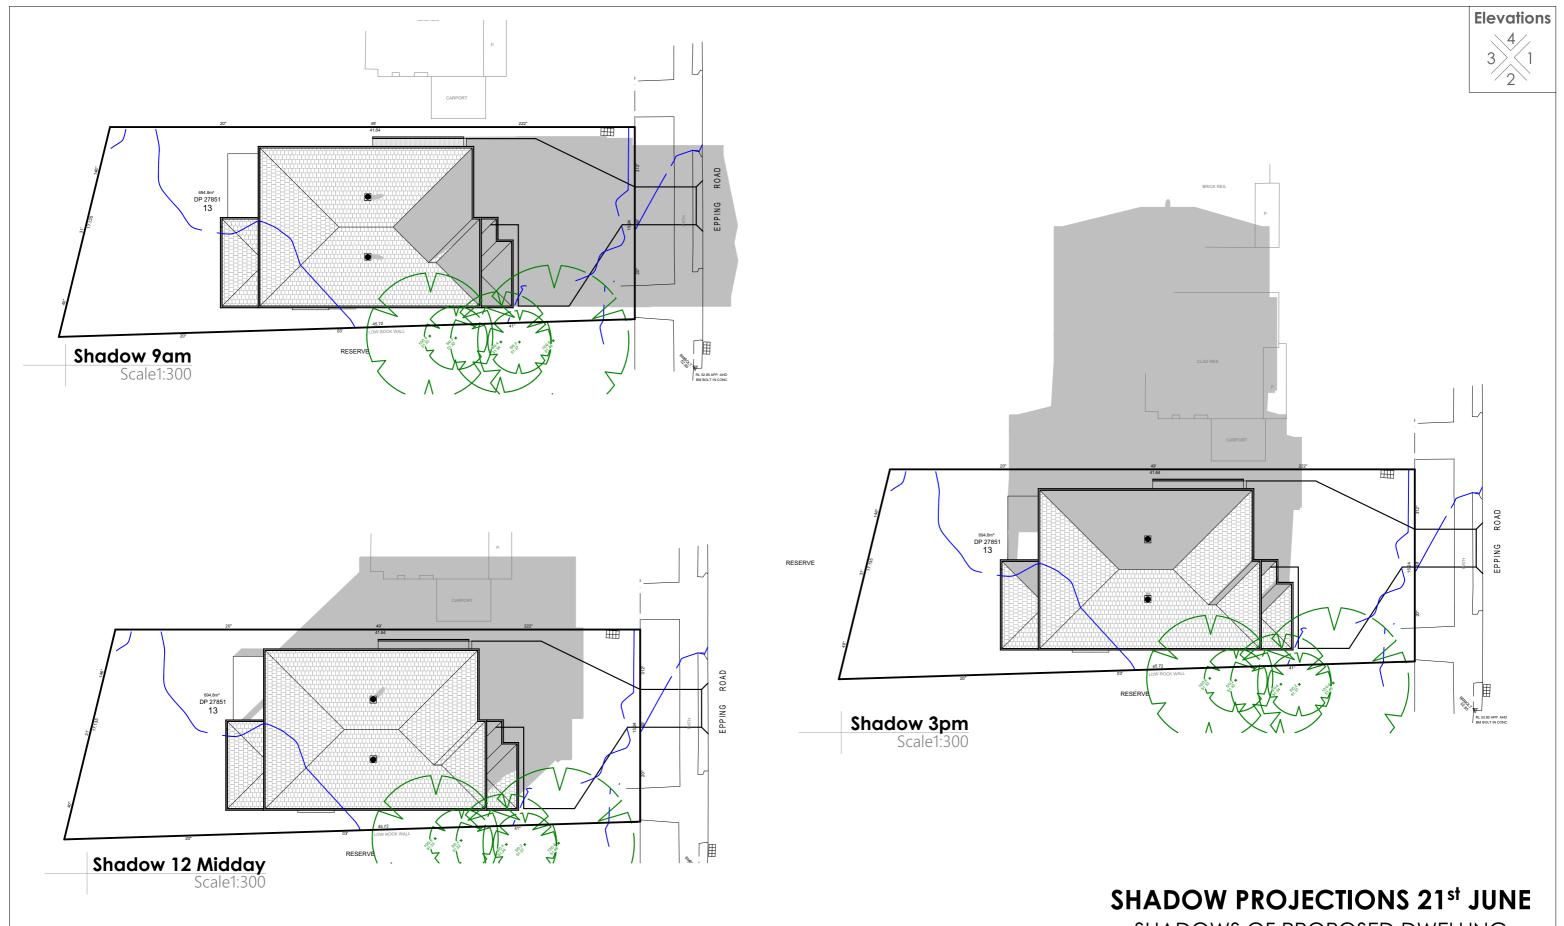

SHADOWS OF PROPOSED DWELLING



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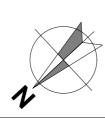
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LODGEMENT: DA ONLY COUNCIL: RYDE DESIGN: CUSTOM DATE: 2/08/2022 Shadows DP No: 27851

site address : LOT 13, NO.23A EPPING ROAD NORTH RYDE

CLIENT NAMES : CRYSTELE HOMES

DRWG No: 013 VERSION No: FP2 Scale:

1:200

KP22-119

